## ADDITION TO

## THE BLUEBERRY PAVILION

## WILMOT ORCHARDS, CLARINGTON, ONTARIO

## DRAWING INDEX

A001	TITLE SHEET, DRAWING INDEX &
	OBC DATA MATRICES
A101	SITE PLAN & CONCRETE PAVING PLAN
A102	BASEMENT & FOUNDATION PLAN
A103	GROUND FLOOR PLAN
A104	ROOF PLAN
A105	REFLECTED CEILING PLAN
A106	SELECTIVE DEMOLITION PLAN
A201	EXTERIOR ELEVATIONS
A301	SECTIONS & EXTERIOR ELEVATION
A401	WALL SECTIONS & DETAILS
S1	FOUNDATION & ROOF FRAMING PLAN

ГΑ	RTS 3						
	ITEM						OBC REFERENCE
							PART 3
1	PROJECT DESCRIPTION ADDITION TO S BLUEBERRY PION PAVILION	EASONAL	□ NEW ■ ADDITION □ ALTERATION □ CHANGE OF	USE			
2	MAJOR OCCUPANCY:		ASSEMBLY, D	IVISION 2			3.1.2.1.(1)
3	BUILDING AREA:		EXISTING 156.73 m2	NEW 151.99 m	•	0TAL 08.72 m2	1.4.1.2.
4	GROSS FLOOR AREA BASEMENT FLO GROUND FLOOF ROOF THIRD FLOOR TOTAL	OR	EXISTING 97.33 m2 156.73 0.00 0.00 254.06 m2	151.99 0.00 <u>0.00</u>	n2 3 _	OTAL 97.33 m2 08.72 0.00 <u>0.00</u> 06.05 m2	1.4.1.2.
5	NO. OF STOREYS:	1	1 ABOVE GRA	ADE, PARTIAL	BELOW	/ GRADE	1.4.1.2.
6	NO. OF STREETS:	1	ACCESS ROU	TE BY PRIVA	ATE GRA	VEL DRIVE	3.2.2.10. & 3.2.5
7	BUILDING CLASSIFICA	ATION:	GROUP A, DI	VISION 2			3.2.2.28.
8	SPRINKLER SYSTEM	PROPOSED:	□ ENTIRE BUILD □ SELECTED RO □ BASEMENT □ IN LIEU OF F	OOMS OR AF			3.2.2.28. 3.2.5. & 3.2.2.17
9	STANDPIPE REQUIRE	D:	□YES	■ NO			3.2.9.
10	FIRE ALARM REQUIR	ED:	□YES	■ NO			3.2.4.
11	WATER SERVICE ADE	EQUATE:		□NO			3.2.5.7.
12	HIGH BUILDING:		□YES	■ NO			3.2.6.
13	PERMITTED CONSTRUCTION		□ COMB. □ COMB.	□NON-CON			3.2.2.28.
14	MEZZANINE AREA:		NOT APPLICA	BLE			3.2.1.1.(3)-(8)
15	BARRIER-FREE DESI	GN:	© YES	□NO			3.8.
16	HAZARDOUS SUBSTA	NCES:	□YES	□ NO			3.3.1.2. & 3.3.1.19.
17	REQUIRED FIRE—RESISTANCE RATINGS:	ASSEMBLY: FLOORS: MEZZANINES: ROOF: SUPPORTING SUPPORTING	WALLS:	RATING IN HRS.: 0 0 0 0		DESIGN NO. -2:	3.2.2.28. 3.2.1.4.
18	OCCUPANT LOAD BA	SED ON:	☐ AREA/PERSO	N I	DESIGN	I OF BLDG.	3.1.17.
	FLOOR & OCCUPANG EXISTING PAVIL PAVILION SHELT TOTAL OCCUPA	ION TER ADDITION	AREA 156.73 m2 151.99	FACTOR BY DESIG 0.95	N <u>1</u>	ERSONS 40 60 00	

PART	II - RENOVATI	ON OF EXISTING BUILDING		T
	ITEM			OBC REFERENCE
11.1.	GENERAL:	EXISTING BUILDING IS SUBJECT TO EXT	ENSION.	11.1.2.
11.2.	CLASSIFICATION OF EXISTING BUILDING:			11.2.1.  Table 11.2.1.1.A  Table 11.2.1.1.B  TO N
11.3.	ALTERATION TO EXISTING BUILDING IS:	■ BASIC RENOVATION □ EXTENSIVE RENOVATION CONSTRUCTION OF SHELTER IS CARRIE MAINTAIN PERFORMANCE LEVEL OF EXIS		11.3.3.1. 11.3.3.2.
11.4. 11.4.2.	REDUCTION IN PERFORMANCE LEVEL:	STRUCTURAL: BY INCREASE IN OCCUPANT LOAD: BY CHANGE OF MAJOR OCCUPANCY: PLUMBING: SEWAGE SYSTEMS:	NO□ YES® NO□ YES® NO® YES□ NO□ YES® NO□ YES®	11.4.2.1. 11.4.2.2. 11.4.2.3. 11.4.2.4. 11.4.2.5.
11.4.3.	COMPENSATING CONSTRUCTION:	STRUCTURAL: INCREASE IN OCCUPANT LOAD: CHANGE IN MAJOR OCCUPANCY: PLUMBING: SEWAGE SYSTEMS:	NO® YESONO YOU YESONO YOU YESONO YOU YESONO YO YOU YESONO YESONO YESONO YESONO YESONO YESONO YOU YESONO YOU YOU YESONO YOU YESONO YOU YESONO YOU YESONO YOU YESONO YOU YOU YESONO YOU YOU YESONO YOU YOU YOU YESONO YOU YOU YESONO YOU YOU YOU YOU YOU YOU YOU YOU YOU YO	11.4.3.2. 11.4.3.3. 11.4.3.4. 11.4.3.5. 11.4.3.6.
11.5.	COMPLIANCE ALTERNATIVES PROPOSED:	□ NO ■ YES, 3.2.5.7. WATER SUPPLY, DOES N PLUMBING & SEWAGE REQUIREMENTS ARE COMPENSATED DURING SEASONAL USE WITH RENTAL OF PORTABLE TOILE & WASHROOM TRAILER RENTALS; SEE SITE PLAN.		A24

GE	ENERAL REQUIREMENTS
1	CONSTRUCT WORK IN COMPLIANCE WITH ONTARIO BUILDING CODE AS AMENDED & REGULATIONS & BY-LAWS OF AUTHORITIES HAVING JURISDICTION, INCLUDING REGULATION: & WORKPLACE SAFETY PROTOCOLS RESULTING FROM COVID 19 PANDEMIC.
2	DO NOT SCALE DRAWINGS.
3	PROVIDE ALL ITEMS, MATERIALS, INCIDENTALS, & SERVICES TO MAKE FINISHED WORK COMPLETE & FULLY OPERATIONAL, CONSISTENT WITH INTENT OF DRAWINGS, UNLESS NOTED OTHERWISE.
4	CHECK & VERIFY ALL DIMENSIONS, DRAWINGS & SPECIFICATIONS ON SITE. REPORT DISCREPANCIES TO ARCHITECT BEFORE PROCEEDING WITH WORK.
5	CONFIRM EXACT LOCATIONS OF ALL BELOW—GROUND SERVICES WITH RESPECTIVE UTILITIES & AUTHORITIES HAVING JURISDICTION, PRIOR TO COMMENCING EXCAVATING.
6	WHERE SPECIFIC PRODUCTS ARE SPECIFIED, SUPPLY & INSTALL SPECIFIED PRODUCT AS NOTED. SUBSTITUTIONS WITH PRODUCTS CONSIDERED EQUAL WILL NOT BE ACCEPTED WITHOUT ARCHITECT'S PRIOR APPROVAL.
7	APPLY ALL MATERIALS IN STRICT COMPLIANCE WITH MANUFACTURER'S INSTRUCTIONS.
8	PATCH, REPAIR, & MAKE GOOD EXISTING FINISHES AS NECESSARY WHERE EXECUTION OF NEW WORK AFFECTS EXISTING CONDITIONS.
9	PERFORM WORK IN ACCORDANCE WITH MINISTRY OF LABOUR REQUIREMENTS & OCCUPATIONAL HEALTH & SAFETY ACT.
10	CLEAN UP & REMOVE FROM SITE ALL DEBRIS RESULTING FROM WORK.

		F					۲] [ر		J	Ι	
		A	R	C	Н		Ţ	E	C	T	
48	WALT	ON S	STREET	Γ,	PORT	НОРЕ	, ON	ITAR <b>I</b> O	LIA	1N6,	CANADA

148 WALTON STREET, PORT HOPE, ONTARIO L1A 1N6, CANADA TEL: (905) 885-8729 www.picciniarchitect.net

THESE DRAWINGS, DETAILS AND SPECIFICATIONS ARE A CONFIDENTIAL AND PROPRIETARY WORK PROTECTED UNDER COPYRIGHT. ALL RIGHTS ARE RESERVED. THEY ARE THE PROPERTY OF PICCINI ARCHITECT AND MAY NOT BE REPRODUCED BY ANY MEANS, ALTERED OR RE-USED WITHOUT THE EXPRESS WRITTEN PERMISSION OF PICCINI ARCHITECT.

THESE DRAWINGS, DETAILS AND SPECIFICATIONS ARE NOT TO BE USED FOR CONSTRUCTION UNTIL COUNTER-SIGNED BY THE ARCHITECT

- 1				
١	NO:	DATE:	ISSUE/REVISION FOR:	BY:
١		D.M.Y.		
١	1	13.02.20	BUILDING PERMIT	R.P.
	2	14.05.20	TENDER	R.P.

RESPONSIBILITY SCHEDULE

EXCAVATING, BACKFILLING & ROUGH GRADING GC

SUPPLIED INSTALLED

0

GC

0

GC

GC GC

GC GC

GC GC

GC

GC

GC GC

0

GC GC

GC

GC

0

GC

GC

GC

GC

GC

GC

GC

GC

GC GC

GC

GC

GC

GC

0

GC

GC

GC

GENERAL CONTRACTOR (GC) IS RESPONSIBLE FOR COORDINATING WORK WITH OWNER (O) & OWNER'S FORCES AS REQUIRED TO COMPLETE

SCOPE OF WORK INCLUDES, BUT IS NOT

PAYMENT OF PERMIT APPLICATION FEES

LIMITED TO THE FOLLOWING:

SELECTIVE DEMOLITION

FINISH GRADING & SODDING

HELICAL FOUNDATION PILES

CASE-IN-PLACE CONCRETE

MISCELLANEOUS METAL

ROUGH CARPENTRY

FINISH CARPENTRY

THERMAL INSULATION

AIR VAPOUR BARRIERS

ENGINEERED LAP SIDING

JOINT SEALANTS

GYPSUM BOARD

PAINTING & COATING

STONE MASONRY, MISCELLANEOUS REPAIRS

FIBERGLASS-REINFORCED ASPHALT SHINGLES

THERMOPLASTIC MEMBRANE ROOFING

(BI-FOLDING DOORS & SLIDING DOORS)

DOOR HARDWARE ALLOWANCE OF \$8,500

(FOR SUPPLY OF FINISHING HARDWARE)

(EXIT DOORS & VESTIBULE WINDOW SCREENS)

DUCTLESS SPLIT-TYPE AC UNIT FOR SHELTER

ADDITION (EXCLUDING VESTIBULES)

ELECTRICAL CONDUIT & DEVICES

PENDANT LIGHT FIXTURES

EXIT & EMERGENCY LIGHTING

LED LIGHT FIXTURES

EXTERIOR DOORS & WINDOWS

ALUMINUM DOORS & WINDOWS

DOOR HARDWARE INSTALLATION

CONCRETE PAVING

BUILDING PERMIT APPLICATION


## ADDITION TO THE BLUEBERRY PAVILION


WILMOT ORCHARDS 3377 CONCESSION ROAD 3 CLARINGTON, ON L1B 0N1

SHEET TITLE:

TITLE SHEET,
DRAWING INDEX &
OBC DATA MATRICES

DRAWN BY: RP	CHK'D BY: RP
PROJECT NO:	DATE:
19.316	MAY 2019

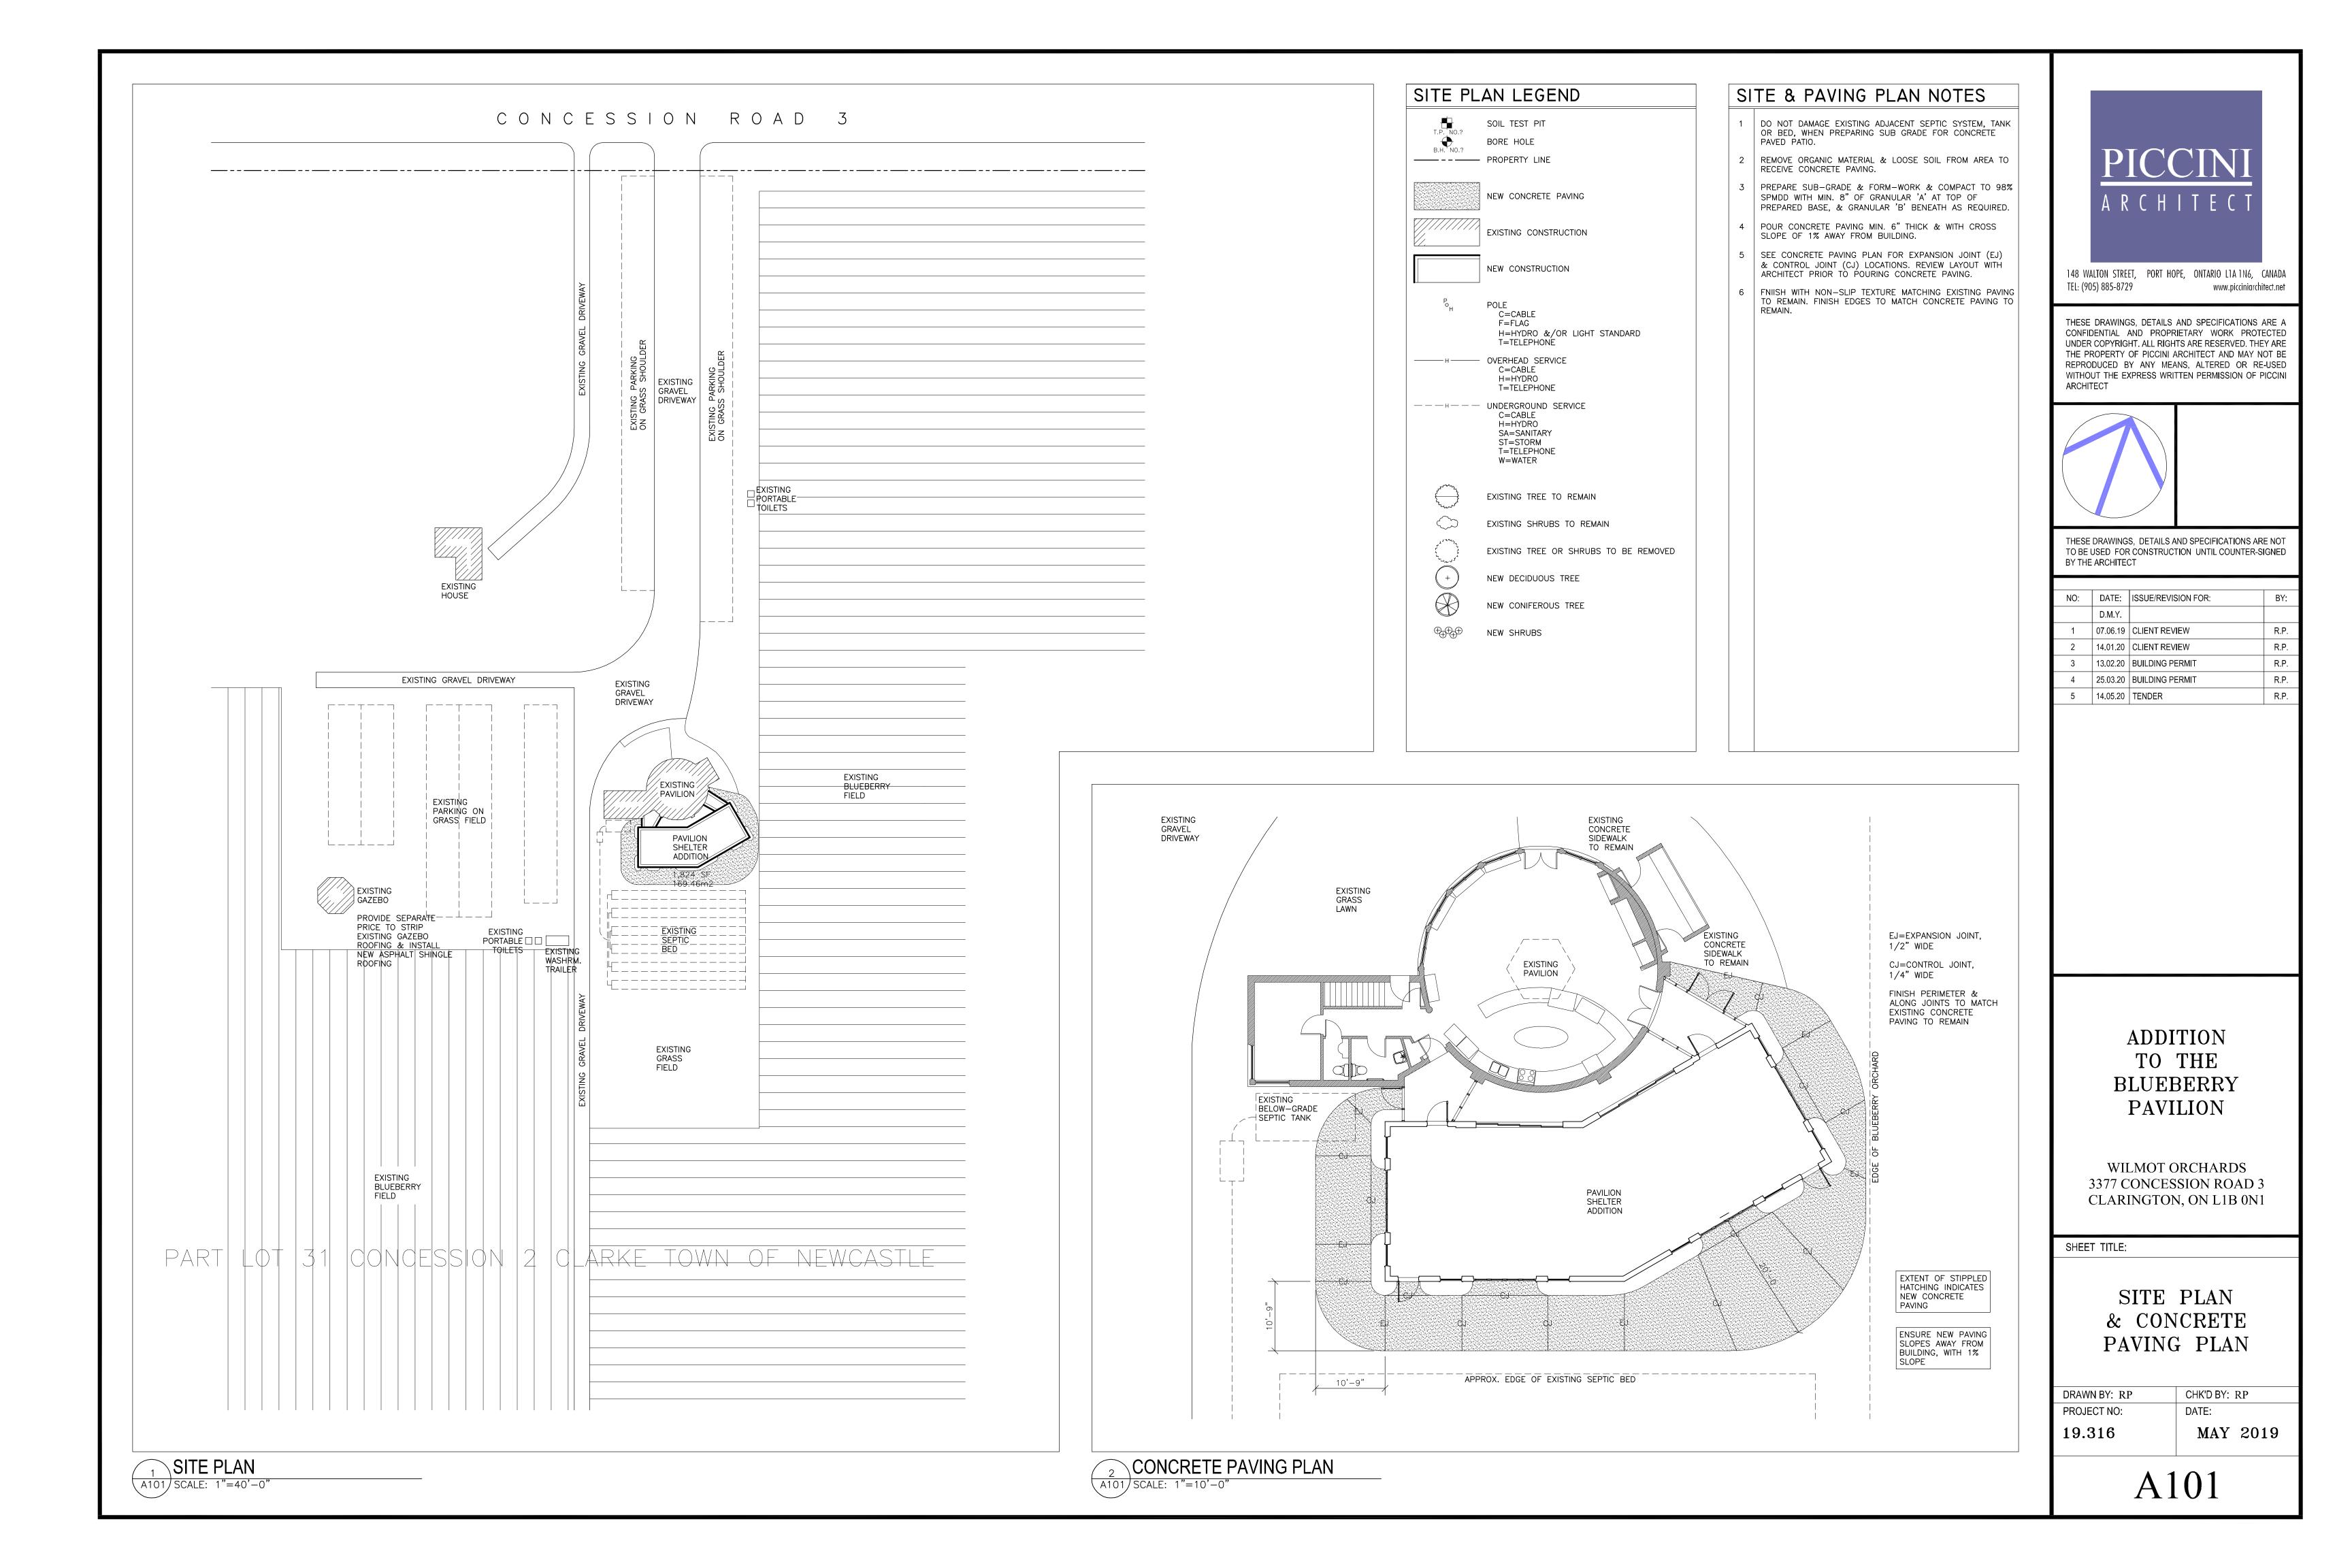


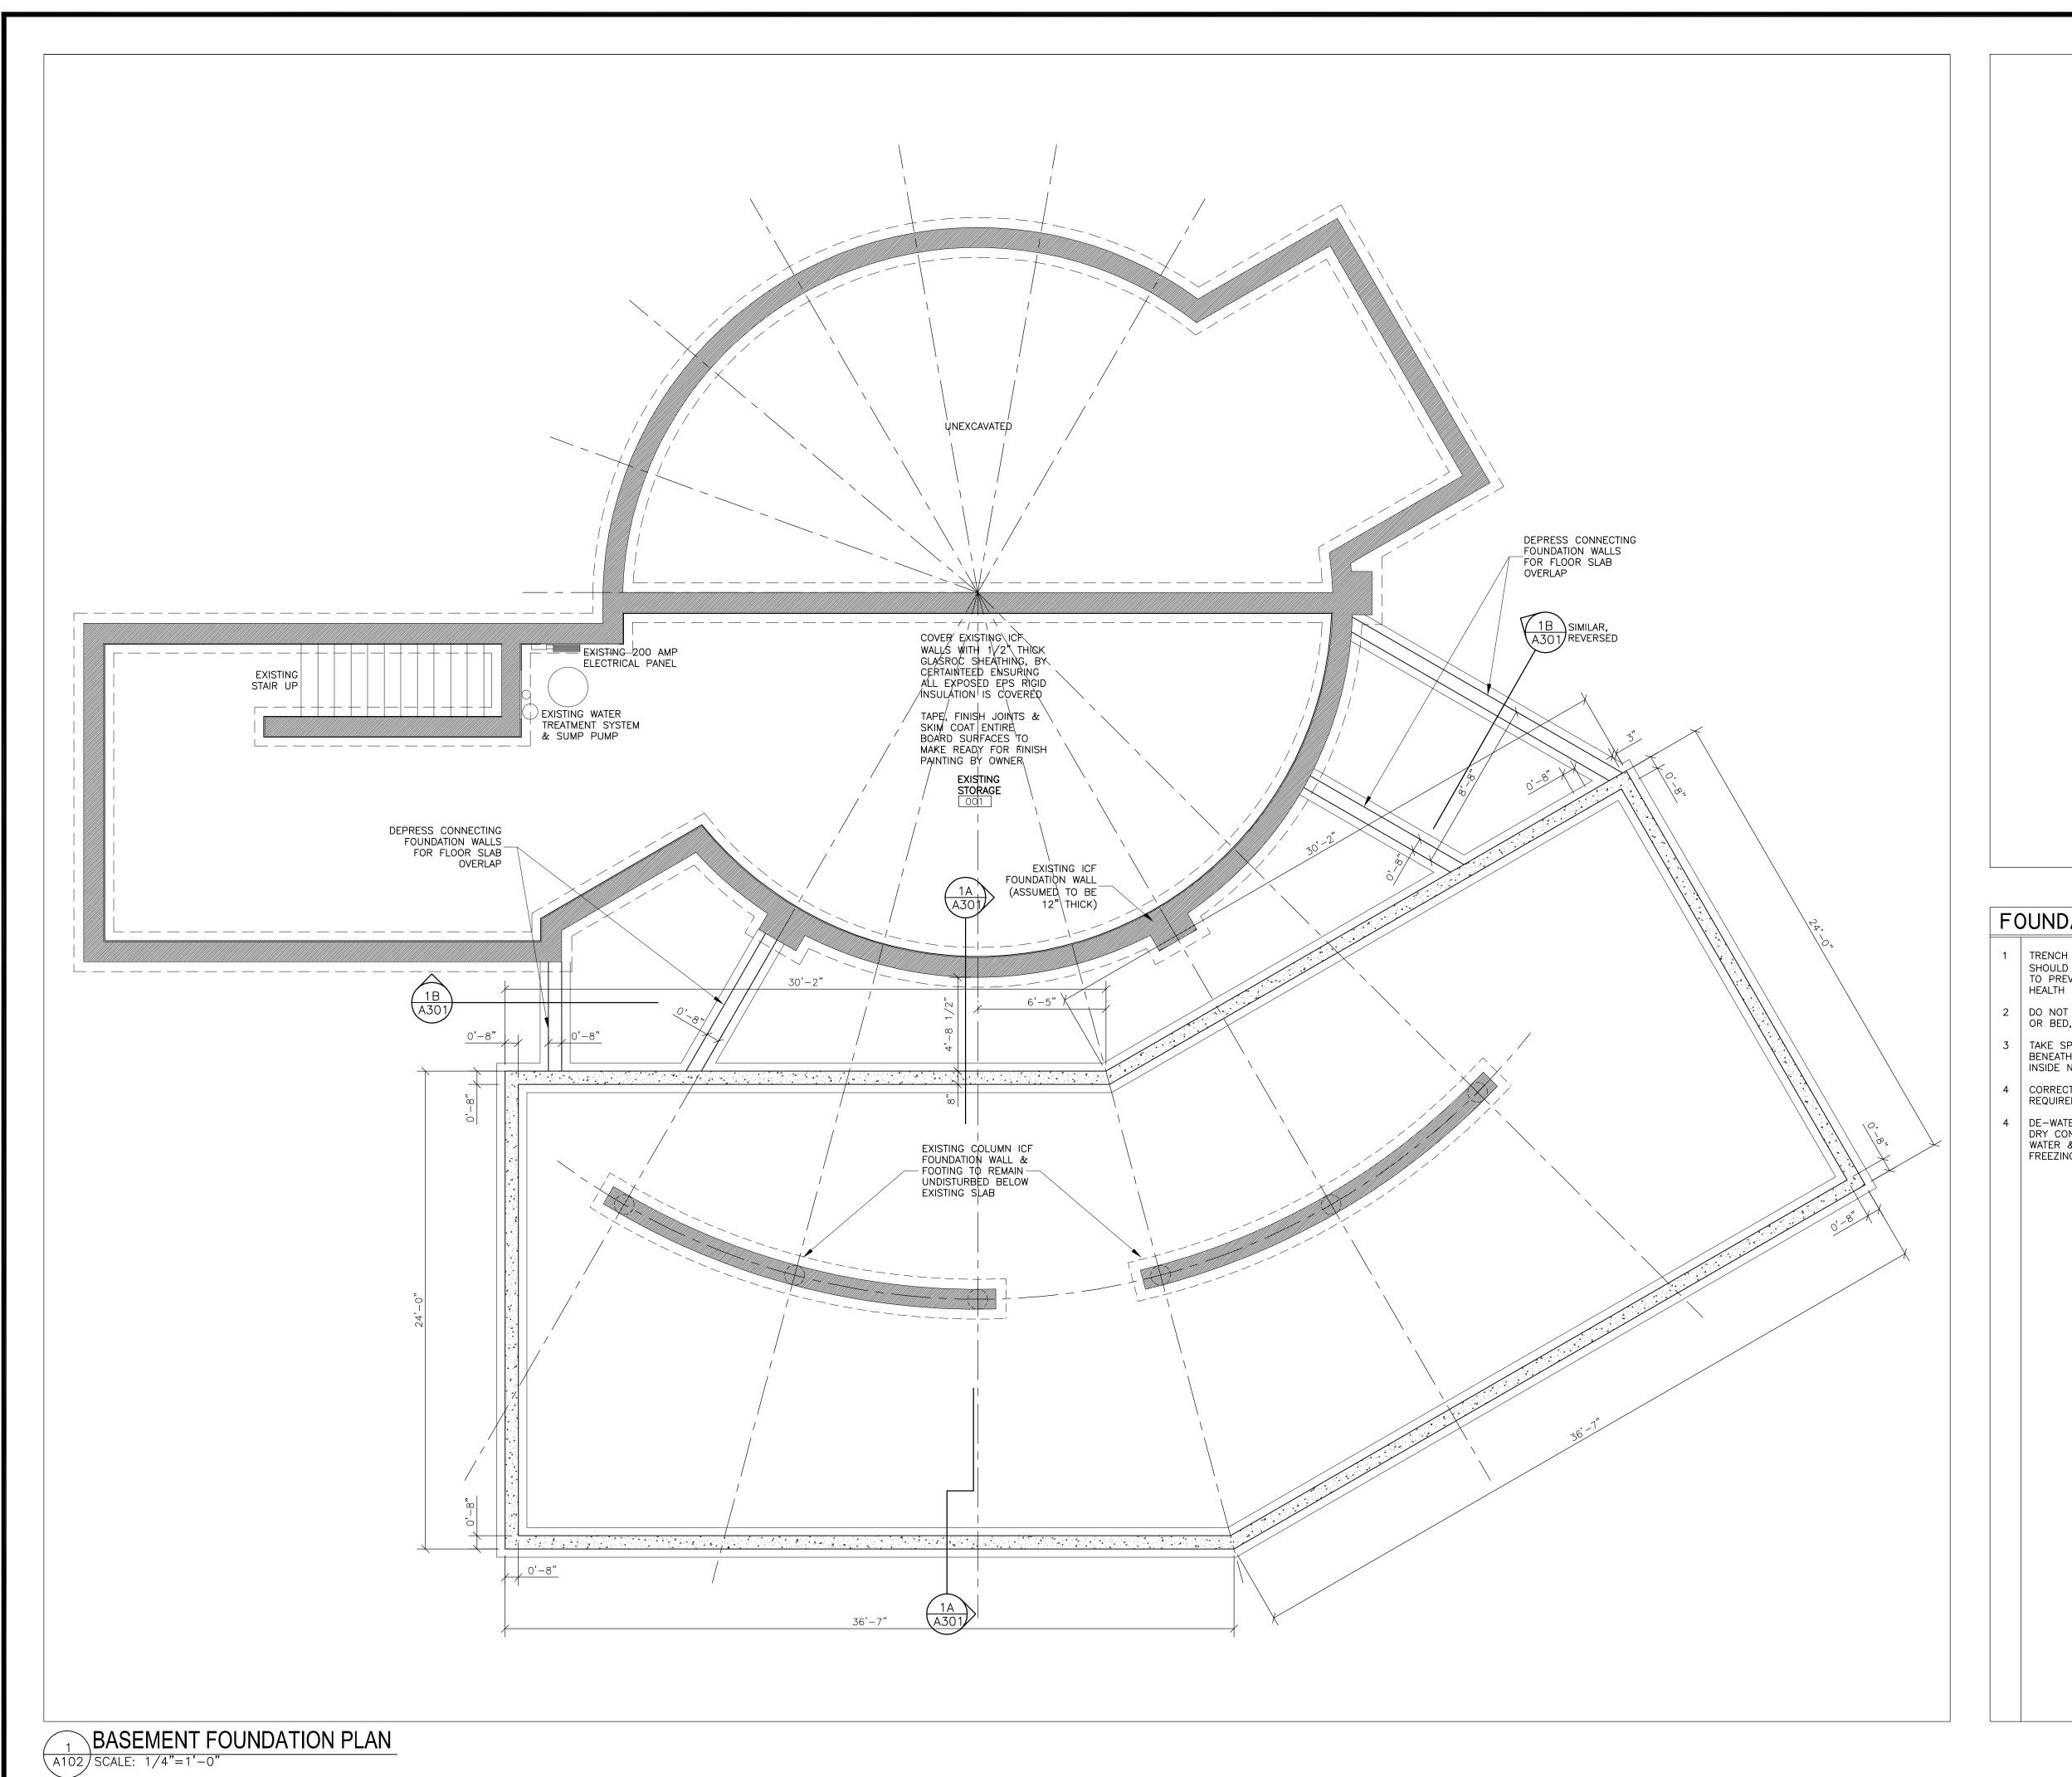



148 WALTON STREET, PORT HOPE, ONTARIO L1A 1N6, CANADA TEL: (905) 885-8729 www.picciniarchitect.net

THESE DRAWINGS, DETAILS AND SPECIFICATIONS ARE A CONFIDENTIAL AND PROPRIETARY WORK PROTECTED UNDER COPYRIGHT. ALL RIGHTS ARE RESERVED. THEY ARE THE PROPERTY OF PICCINI ARCHITECT AND MAY NOT BE REPRODUCED BY ANY MEANS, ALTERED OR RE-USED WITHOUT THE EXPRESS WRITTEN PERMISSION OF PICCINI ARCHITECT

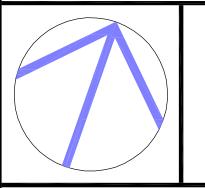

THESE DRAWINGS, DETAILS AND SPECIFICATIONS ARE NOT TO BE USED FOR CONSTRUCTION UNTIL COUNTER-SIGNED BY THE ARCHITECT

NO:	DATE:	ISSUE/REVISION FOR:	BY:
	D.M.Y.		
1	14.01.20	CLIENT REVIEW	R.P.
2	13.02.20	BUILDING PERMIT	R.P.
3	14.05.20	TENDER	R.P.

## FOUNDATION PLAN NOTES

- TRENCH OR EXCAVATE TO DEPTHS SHOWN. IF EXCAVATION SHOULD EXCEED 1.2m OR 4' IN DEPTH, SHORE & BRACE TO PREVENT FAILURE IN ACCORDANCE WITH OCCUPATIONAL HEALTH & SAFETY ACT.
- DO NOT DAMAGE EXISTING ADJACENT SEPTIC SYSTEM, TANK OR BED, WHEN EXCAVATING FOR FOUNDATIONS.
- TAKE SPECIAL PRECAUTION NOT TO UNDERMINE SOIL BENEATH EXISTING CONCRETE FLOOR SLAB TO REMAIN INSIDE NEW PAVILION ADDITION.
- CORRECT OVER-EXCAVATION ERROR BY FILLING UP TO REQUIRED ELEVATION WITH LOW SLUMP CONCRETE.
- DE-WATER EXCAVATION SO CONCRETE MAY BE PLACED IN DRY CONDITIONS. KEEP EXCAVATION FREE OF STANDING WATER & PREVENT BOTTOM OF EXCAVATION FROM FREEZING.

## ADDITION TO THE BLUEBERRY PAVILION


WILMOT ORCHARDS 3377 CONCESSION ROAD 3 CLARINGTON, ON L1B 0N1

SHEET TITLE:

BASEMENT & FOUNDATON PLAN

CHK'D BY: RP DRAWN BY: RP PROJECT NO: DATE: 19.316

MAY 2019

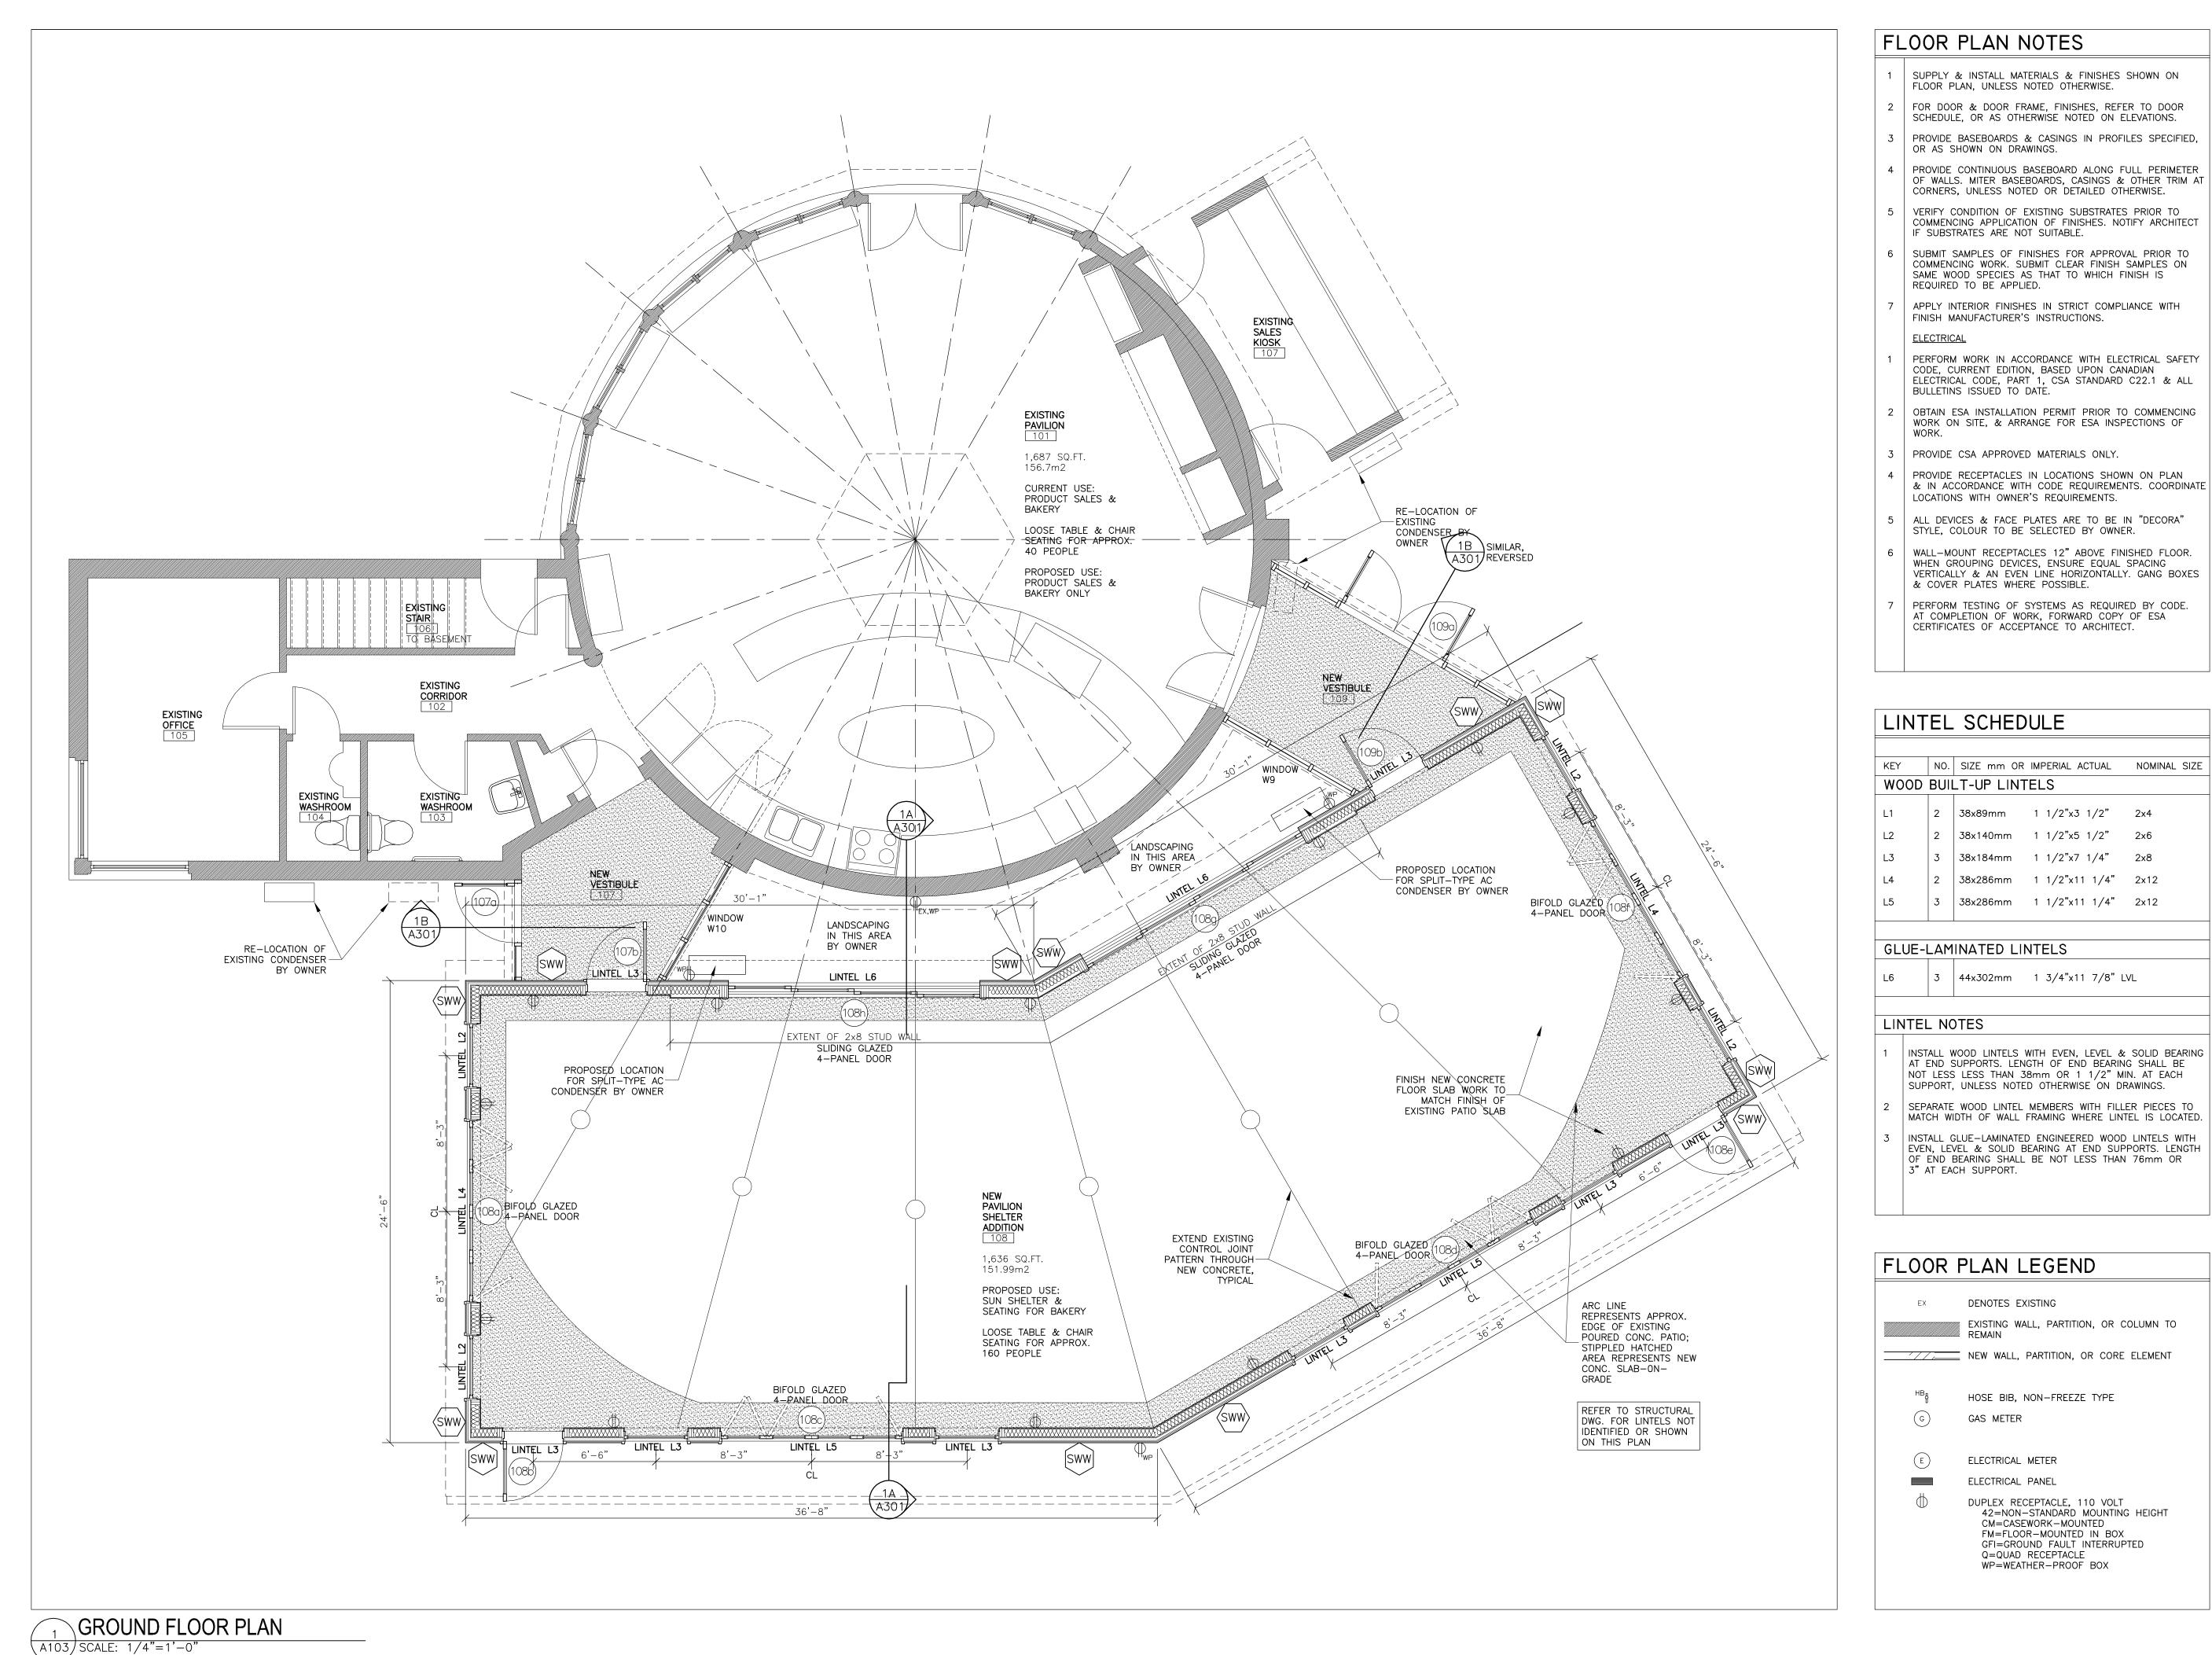

#### FLOOR PLAN NOTES

- SUPPLY & INSTALL MATERIALS & FINISHES SHOWN ON FLOOR PLAN, UNLESS NOTED OTHERWISE.
- FOR DOOR & DOOR FRAME, FINISHES, REFER TO DOOR
- SCHEDULE, OR AS OTHERWISE NOTED ON ELEVATIONS. PROVIDE BASEBOARDS & CASINGS IN PROFILES SPECIFIED,
- OR AS SHOWN ON DRAWINGS. PROVIDE CONTINUOUS BASEBOARD ALONG FULL PERIMETER
- CORNERS, UNLESS NOTED OR DETAILED OTHERWISE. VERIFY CONDITION OF EXISTING SUBSTRATES PRIOR TO COMMENCING APPLICATION OF FINISHES. NOTIFY ARCHITECT
- IF SUBSTRATES ARE NOT SUITABLE. SUBMIT SAMPLES OF FINISHES FOR APPROVAL PRIOR TO COMMENCING WORK. SUBMIT CLEAR FINISH SAMPLES ON SAME WOOD SPECIES AS THAT TO WHICH FINISH IS
- APPLY INTERIOR FINISHES IN STRICT COMPLIANCE WITH FINISH MANUFACTURER'S INSTRUCTIONS.
- **ELECTRICAL** PERFORM WORK IN ACCORDANCE WITH ELECTRICAL SAFETY CODE, CURRENT EDITION, BASED UPON CANADIAN ELECTRICAL CODE, PART 1, CSA STANDARD C22.1 & ALL
- OBTAIN ESA INSTALLATION PERMIT PRIOR TO COMMENCING WORK ON SITE, & ARRANGE FOR ESA INSPECTIONS OF
- PROVIDE CSA APPROVED MATERIALS ONLY.
- PROVIDE RECEPTACLES IN LOCATIONS SHOWN ON PLAN & IN ACCORDANCE WITH CODE REQUIREMENTS. COORDINATE LOCATIONS WITH OWNER'S REQUIREMENTS.
- ALL DEVICES & FACE PLATES ARE TO BE IN "DECORA" STYLE, COLOUR TO BE SELECTED BY OWNER.
- WALL-MOUNT RECEPTACLES 12" ABOVE FINISHED FLOOR. WHEN GROUPING DEVICES, ENSURE EQUAL SPACING VERTICALLY & AN EVEN LINE HORIZONTALLY. GANG BOXES & COVER PLATES WHERE POSSIBLE.
- PERFORM TESTING OF SYSTEMS AS REQUIRED BY CODE. AT COMPLETION OF WORK, FORWARD COPY OF ESA CERTIFICATES OF ACCEPTANCE TO ARCHITECT.

#### LINTEL SCHEDULE

	KEY	NO.	SIZE mm OR	IMPERIAL ACTUAL	NOMINAL SIZE
	WOOD	BUIL	T-UP LINT	ΓELS	
	L1	2	38x89mm	1 1/2"x3 1/2"	2x4
	L2	2	38x140mm	1 1/2"x5 1/2"	2x6
	L3	3	38x184mm	1 1/2"x7 1/4"	2x8
	L4	2	38x286mm	1 1/2"x11 1/4"	2x12
	L5	3	38x286mm	1 1/2"x11 1/4"	2x12

### GLUE-LAMINATED LINTELS

44x302mm 1 3/4"x11 7/8" LVL

#### LINTEL NOTES

- INSTALL WOOD LINTELS WITH EVEN, LEVEL & SOLID BEARING AT END SUPPORTS. LENGTH OF END BEARING SHALL BE NOT LESS LESS THAN 38mm OR 1 1/2" MIN. AT EACH SUPPORT, UNLESS NOTED OTHERWISE ON DRAWINGS.
- SEPARATE WOOD LINTEL MEMBERS WITH FILLER PIECES TO MATCH WIDTH OF WALL FRAMING WHERE LINTEL IS LOCATED.
- INSTALL GLUE—LAMINATED ENGINEERED WOOD LINTELS WITH EVEN, LEVEL & SOLID BEARING AT END SUPPORTS. LENGTH OF END BEARING SHALL BE NOT LESS THAN 76mm OR 3" AT EACH SUPPORT.

### FLOOR PLAN LEGEND

DENOTES EXISTING

EXISTING WALL, PARTITION, OR COLUMN TO REMAIN NEW WALL, PARTITION, OR CORE ELEMENT

HOSE BIB, NON-FREEZE TYPE GAS METER

ELECTRICAL METER ELECTRICAL PANEL

DUPLEX RECEPTACLE, 110 VOLT FM=FLOOR-MOUNTED IN BOX GFI=GROUND FAULT INTERRUPTED


42=NON-STANDARD MOUNTING HEIGHT CM=CASEWORK-MOUNTED Q=QUAD RECEPTACLE WP=WEATHER-PROOF BOX

A103



148 WALTON STREET, PORT HOPE, ONTARIO L1A 1N6, CANADA TEL: (905) 885-8729 www.picciniarchitect.net

THESE DRAWINGS, DETAILS AND SPECIFICATIONS ARE A CONFIDENTIAL AND PROPRIETARY WORK PROTECTED UNDER COPYRIGHT. ALL RIGHTS ARE RESERVED. THEY ARE THE PROPERTY OF PICCINI ARCHITECT AND MAY NOT BE REPRODUCED BY ANY MEANS, ALTERED OR RE-USED WITHOUT THE EXPRESS WRITTEN PERMISSION OF PICCINI ARCHITECT

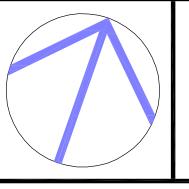

THESE DRAWINGS, DETAILS AND SPECIFICATIONS ARE NOT TO BE USED FOR CONSTRUCTION UNTIL COUNTER-SIGNED BY THE ARCHITECT

NO:	DATE:	ISSUE/REVISION FOR:	BY:
	D.M.Y.		
1	25.11.19	CLIENT REVIEW	R.P.
2	14.01.20	CLIENT REVIEW	R.P.
3	13.02.20	BUILDING PERMIT	R.P.
4	14.05.20	TENDER	R.P.


## ADDITION TO THE BLUEBERRY PAVILION

WILMOT ORCHARDS 3377 CONCESSION ROAD 3 CLARINGTON, ON L1B 0N1

SHEET TITLE:

GROUND FLOOR PLAN


DRAWN BY: RP CHK'D BY: RP PROJECT NO: DATE: MAY 2019 19.316

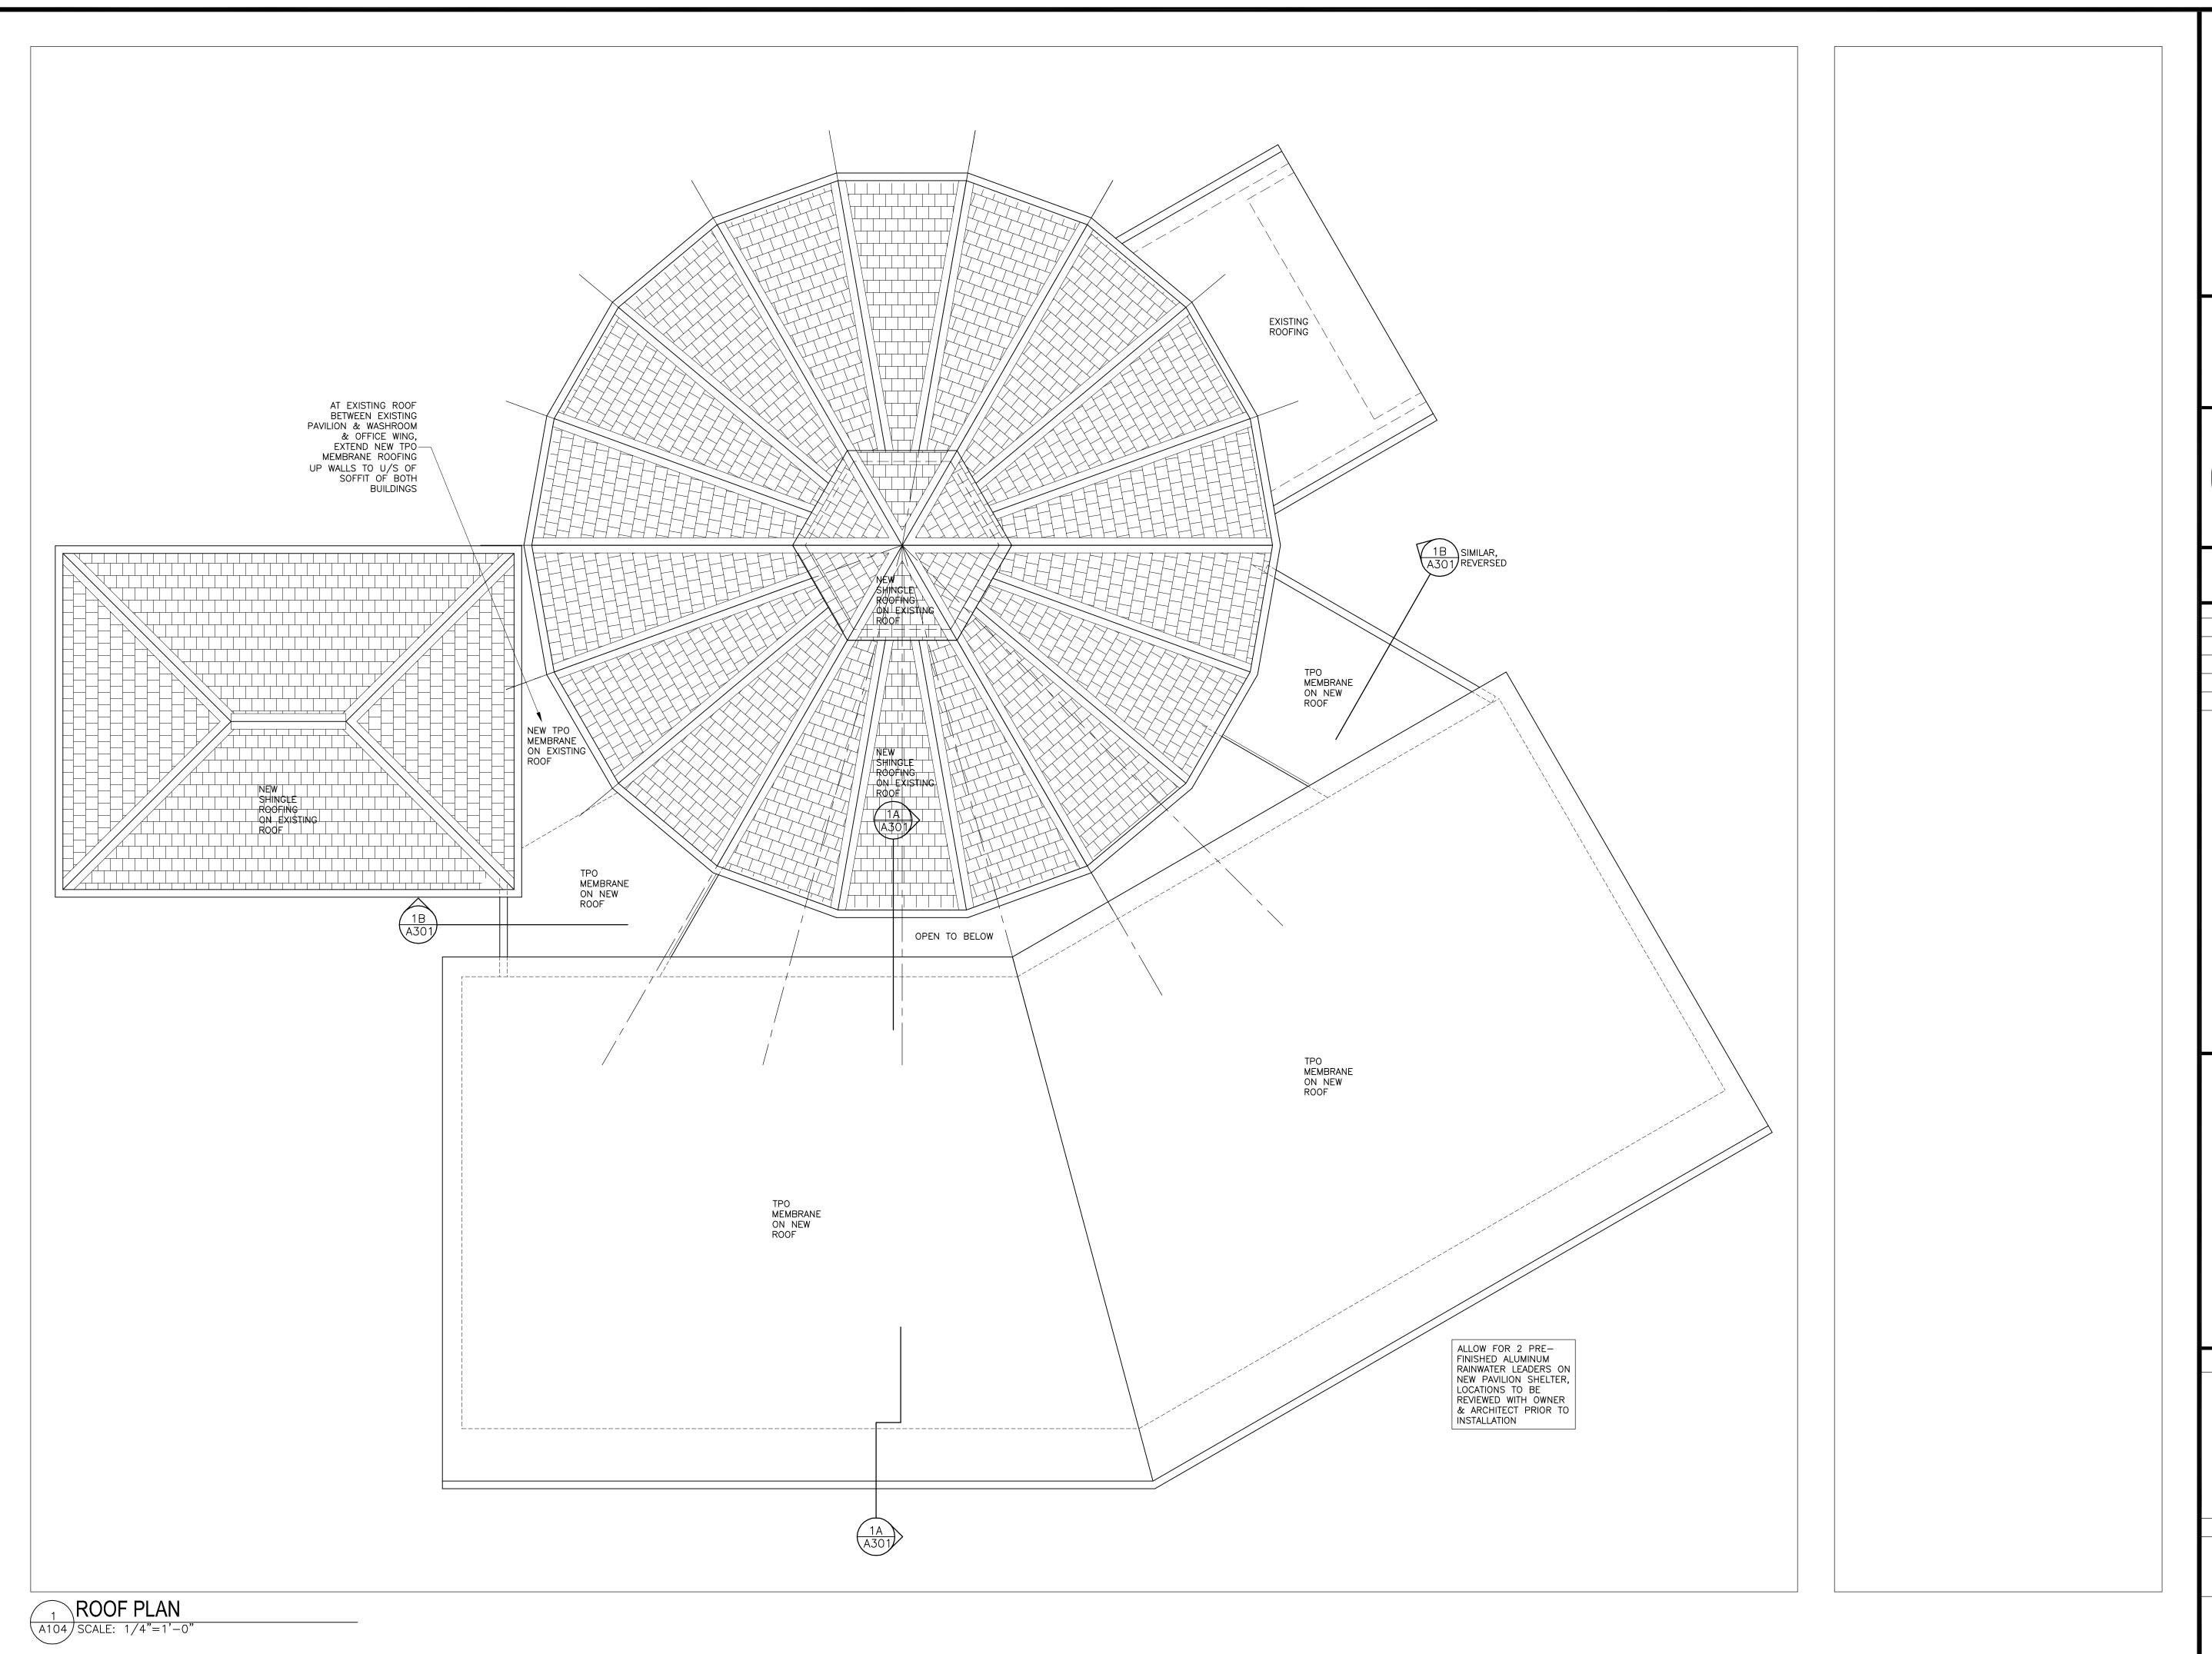



148 WALTON STREET, PORT HOPE, ONTARIO L1A 1N6, CANADA TEL: (905) 885-8729 www.picciniarchitect.net

THESE DRAWINGS, DETAILS AND SPECIFICATIONS ARE A CONFIDENTIAL AND PROPRIETARY WORK PROTECTED UNDER COPYRIGHT. ALL RIGHTS ARE RESERVED. THEY ARE THE PROPERTY OF PICCINI ARCHITECT AND MAY NOT BE REPRODUCED BY ANY MEANS, ALTERED OR RE-USED WITHOUT THE EXPRESS WRITTEN PERMISSION OF PICCINI ARCHITECT

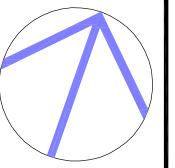

THESE DRAWINGS, DETAILS AND SPECIFICATIONS ARE NOT TO BE USED FOR CONSTRUCTION UNTIL COUNTER-SIGNED BY THE ARCHITECT

- 1				
١	NO:	DATE	ISSUE/REVISION FOR:	BY:
١		D.M.Y.		
١	1	14.01.20	CLIENT REVIEW	R.P.
	2	13.02.20	BUILDING PERMIT	R.P.
	3	14.05.20	TENDER	R.P.

# ADDITION TO THE BLUEBERRY PAVILION

WILMOT ORCHARDS 3377 CONCESSION ROAD 3 CLARINGTON, ON L1B 0N1


SHEET TITLE:

ROOF PLAN

 DRAWN BY: RP
 CHK'D BY: RP

 PROJECT NO:
 DATE:

 15.261
 MAY 2019

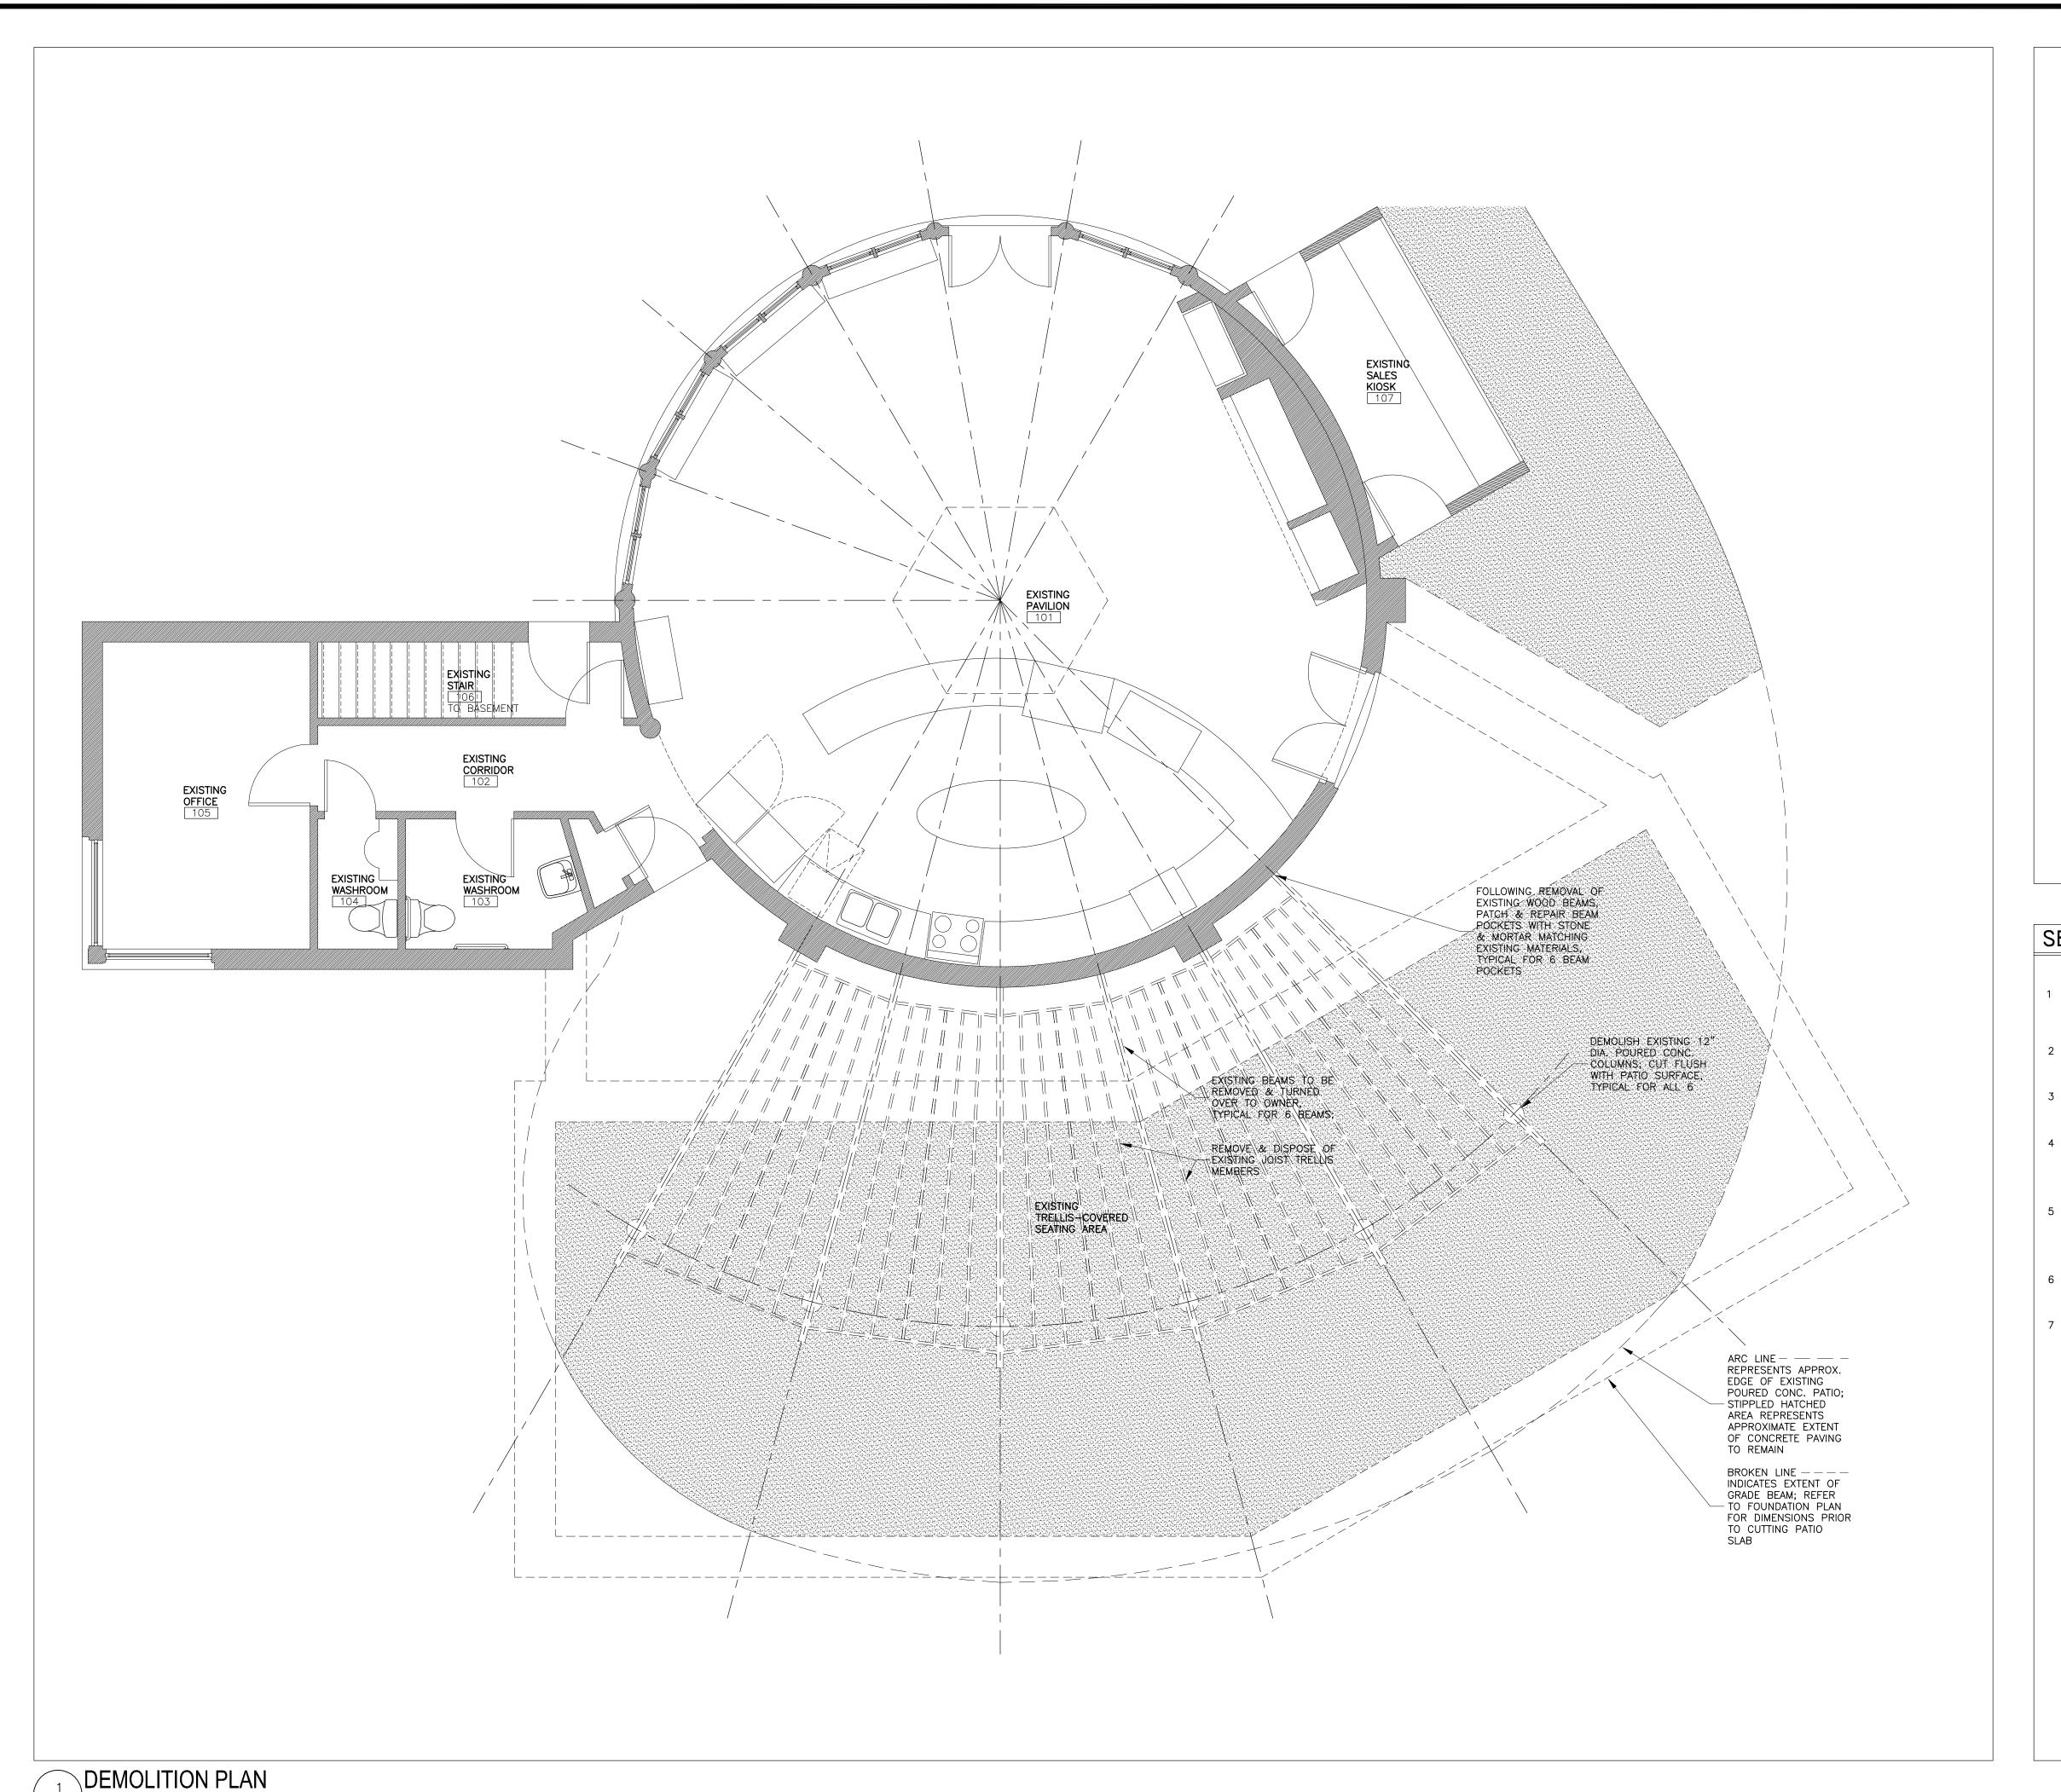


(A105) SCALE: 1/4"=1'-0"



148 WALTON STREET, PORT HOPE, ONTARIO L1A 1N6, CANADA TEL: (905) 885-8729 www.picciniarchitect.net

THESE DRAWINGS, DETAILS AND SPECIFICATIONS ARE A CONFIDENTIAL AND PROPRIETARY WORK PROTECTED UNDER COPYRIGHT. ALL RIGHTS ARE RESERVED. THEY ARE THE PROPERTY OF PICCINI ARCHITECT AND MAY NOT BE REPRODUCED BY ANY MEANS, ALTERED OR RE-USED WITHOUT THE EXPRESS WRITTEN PERMISSION OF PICCINI ARCHITECT

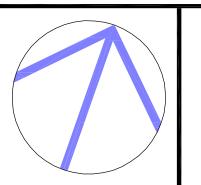

THESE DRAWINGS, DETAILS AND SPECIFICATIONS ARE NOT TO BE USED FOR CONSTRUCTION UNTIL COUNTER-SIGNED BY THE ARCHITECT

١	NO:	DATE:	ISSUE/REVISION FOR:	BY:
١		D.M.Y.		
١	1	14.01.20	CLIENT REVIEW	R.P.
	2	13.02.20	BUILDING PERMIT	R.P.
	3	14.05.20	TENDER	R.P.

## SELECTIVE DEMOLITION NOTES

SELECTIVE DEMOLITION

- PROTECT AREA SURROUNDING SELECTIVE DEMOLITION FROM DAMAGE FROM FALLING DEBRIS & OTHER CAUSES.
  PERFORM WORK IN ACCORDANCE WITH CSA S350-M, CODE OF PRACTICE FOR SAFETY IN DEMOLITION OF STRUCTURES.
- BRACE LOAD—BEARING ELEMENTS TO ENSURE WORK AT NO TIME IS IN DANGER OF COLLAPSING OR ENDANGERING SAFETY OF WORKERS OR BUILDING OCCUPANTS.

  3 REMOVE CAREFULLY THE FOLLOWING ITEMS & TURN OVER
- 3 REMOVE CAREFULLY THE FOLLOWING ITEMS & TURN OVE TO OWNER:

  —SIX 4"x8" WOOD BEAMS
- REMOVE EXISTING CONCRETE COLUMNS & PORTIONS OF PATIO SLAB AS SHOWN ON DRAWINGS. CUT COLUMNS FLUSH WITH ADJACENT PATIO SURFACE, TAKING CARE NOT TO DAMAGE EXISTING CONCRETE PATIO SURFACE. PROVIDE SURFACE PROTECTION AS REQUIRED.
- DEMOLISH COLUMNS & TRELLIS STRUCTURE IN SMALL PORTIONS. CUT PATIO SLAB STRAIGHT WITH POWER DRIVEN ABRASIVE CUTTING DISC. WET DOWN AREA TO KEEP DUST EMISSIONS TO MINIMUM. PREVENT DUST FROM MIGRATING BEYOND WORK AREA INTO EXISTING BUILDING.
- REPAIR & MAKE GOOD DAMAGE TO EXISTING FINISHES & SUBSTRATES CAUSED DURING PERFORMANCE OF DEMOLITION WORK.
- REMOVE & DISPOSE OF DEMOLITION DEBRIS UNLESS NOTED OTHERWISE.

ADDITION
TO THE
BLUEBERRY
PAVILION

WILMOT ORCHARDS 3377 CONCESSION ROAD 3 CLARINGTON, ON L1B 0N1


SHEET TITLE:

SELECTIVE DEMOLITION PLAN

 DRAWN BY: RP
 CHK'D BY: RP

 PROJECT NO:
 DATE:

 19.316
 MAY 2019

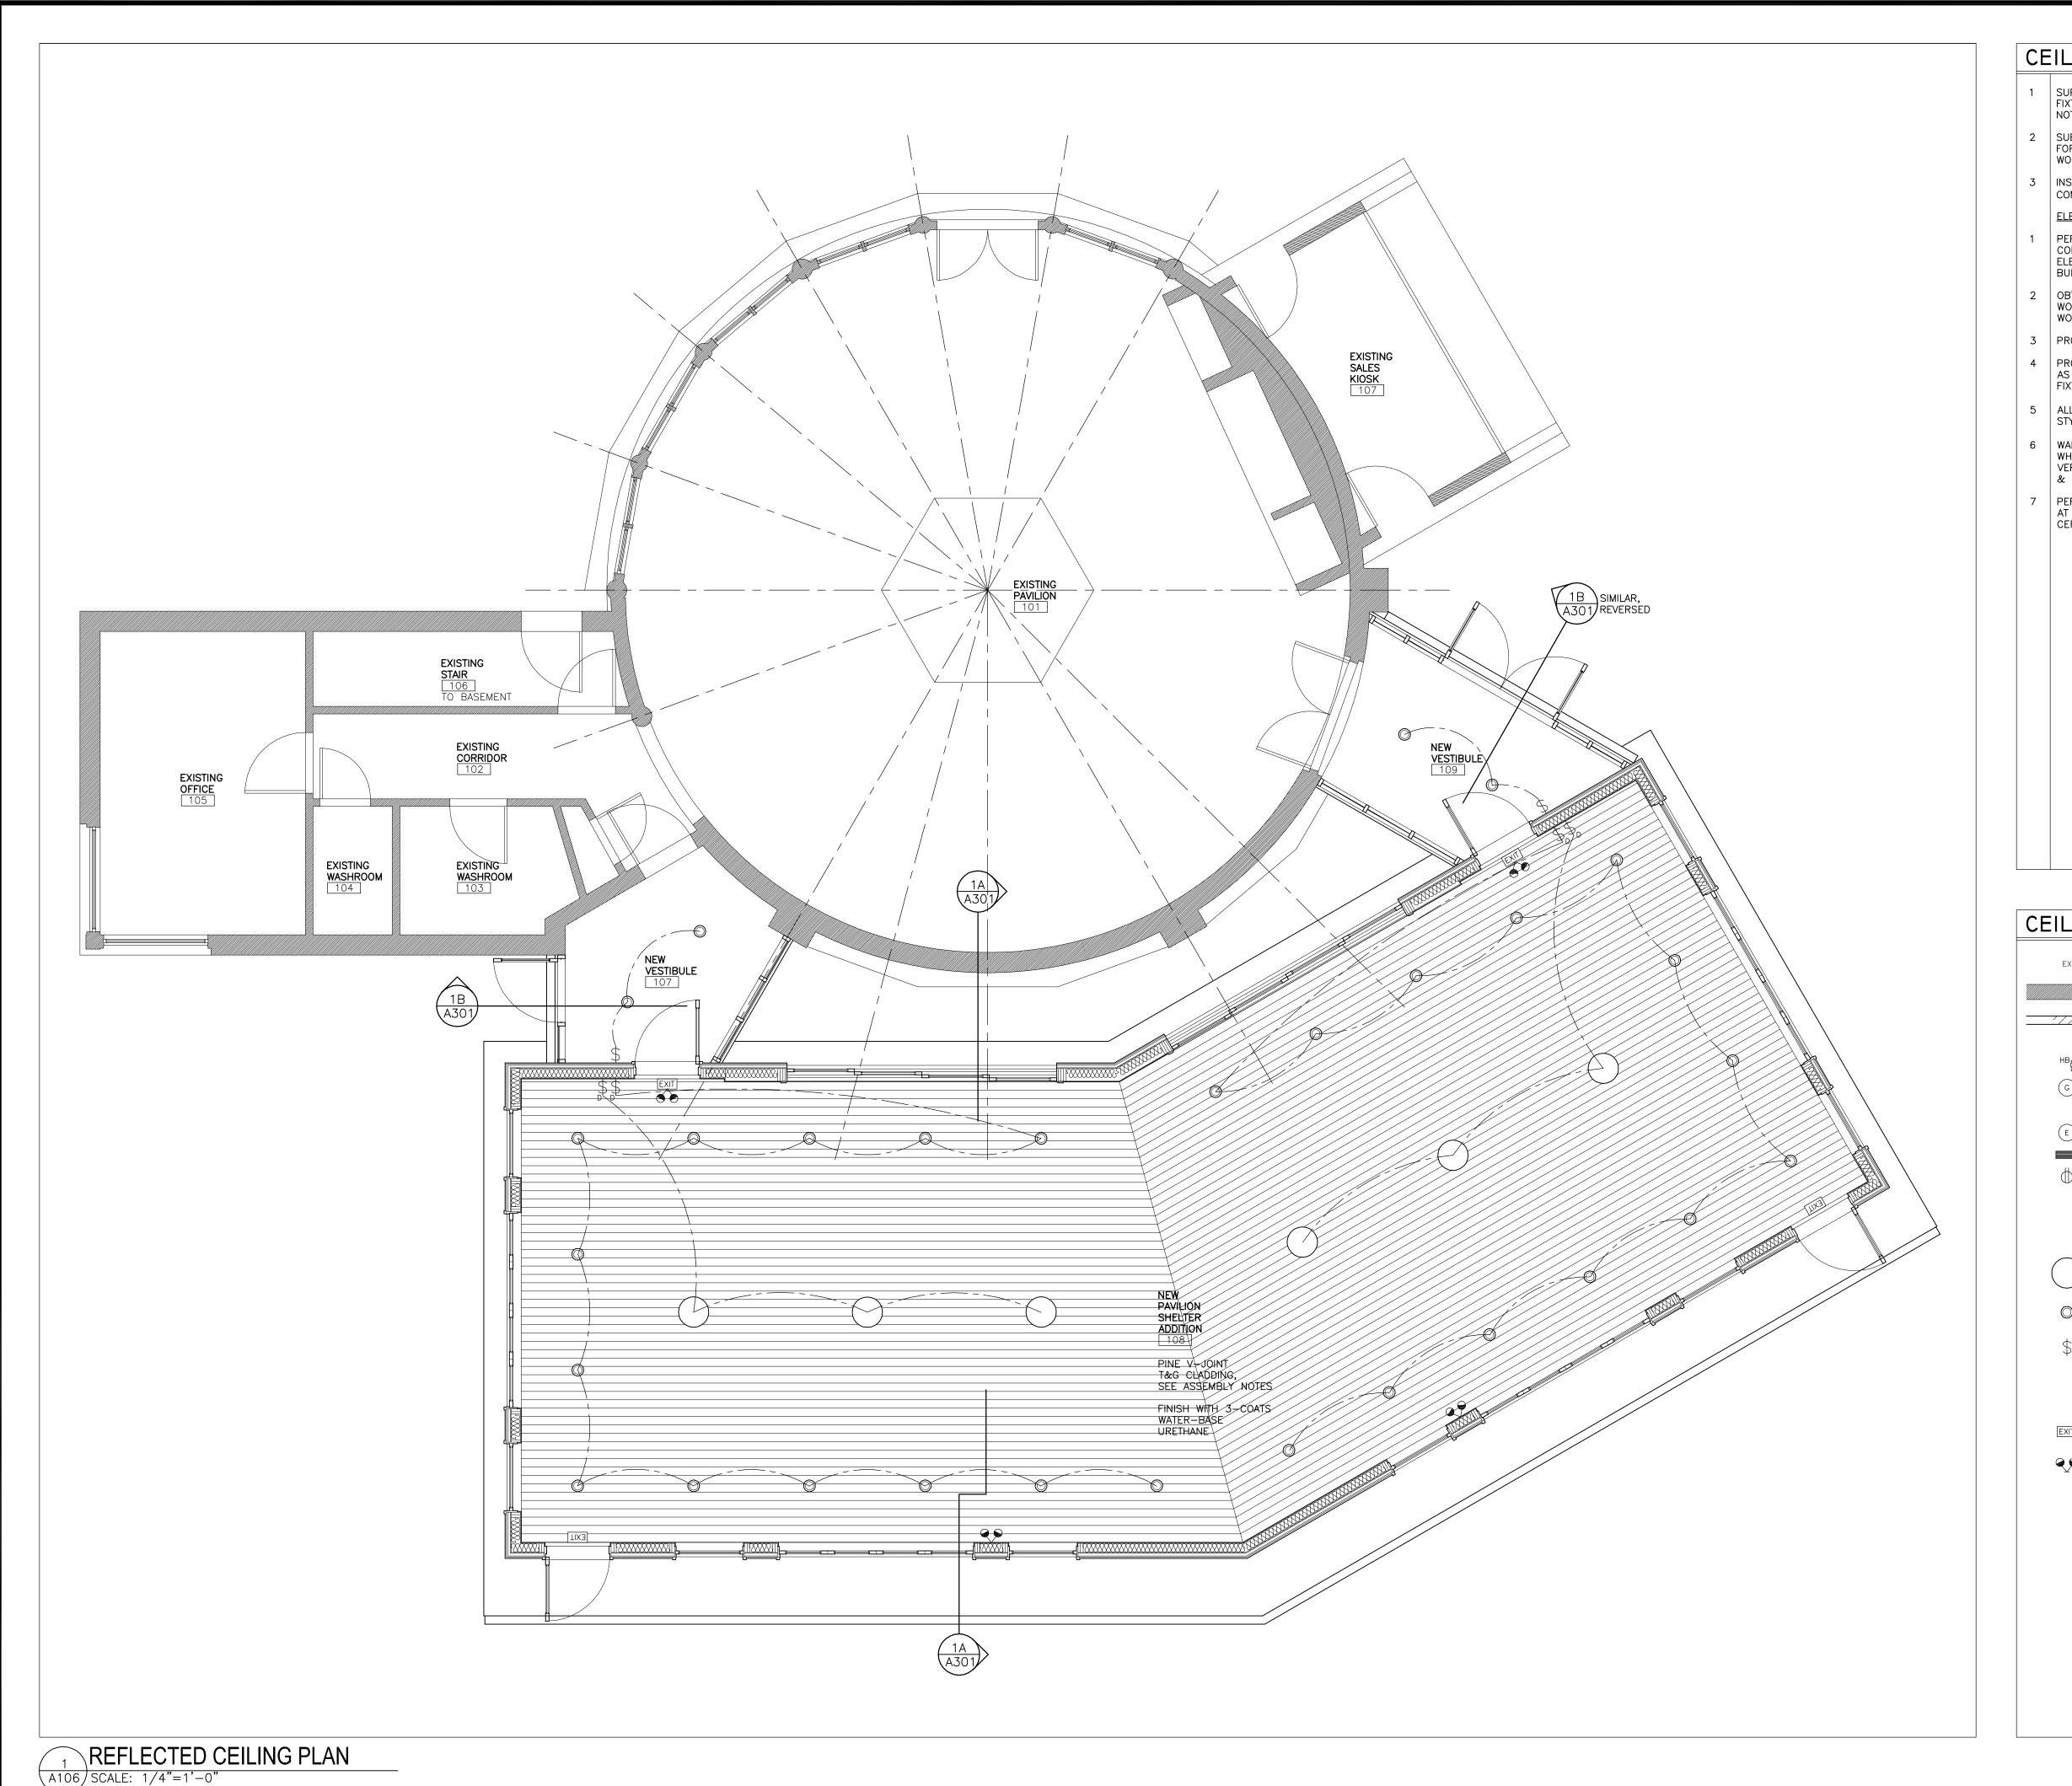

### CEILING PLAN NOTES


- 1 SUPPLY & INSTALL MATERIALS, FINISHES & ELECTRICAL FIXTURES SHOWN ON REFLECTED CEILING PLANS, UNLESS NOTED OTHERWISE.
- 2 SUBMIT SAMPLES OF MATERIALS & FINISHES TO ARCHITECT FOR APPROVAL PRIOR TO PROCURING & COMMENCING
- 3 INSTALL & APPLY ALL MATERIALS & FINISHES IN STRICT COMPLIANCE WITH MANUFACTURER'S INSTRUCTIONS.

  ELECTRICAL
- PERFORM WORK IN ACCORDANCE WITH ELECTRICAL SAFETY CODE, CURRENT EDITION, BASED UPON CANADIAN ELECTRICAL CODE, PART 1, CSA STANDARD C22.1 & ALL BULLETINS ISSUED TO DATE.
- OBTAIN ESA INSTALLATION PERMIT PRIOR TO COMMENCING WORK ON SITE, & ARRANGE FOR ESA INSPECTIONS OF
- 3 PROVIDE CSA APPROVED MATERIALS ONLY.
- PROVIDE NEW LIGHT FIXTURES IN QUANTITY & LOCATIONS AS SHOWN ON REFLECTED CEILING PLAN, & INSTALL FIXTURES SCHEDULED TO BE SUPPLIED BY OWNER.
- 5 ALL SWITCHES & FACE PLATES ARE TO BE IN "DECORA" STYLE, COLOUR TO BE SELECTED BY OWNER.
- WALL MOUNT LIGHT SWITCHES 46" ABOVE FINISHED FLOOR. WHEN GROUPING DEVICES, ENSURE EQUAL SPACING VERTICALLY & AN EVEN LINE HORIZONTALLY, GANG BOXES & COVER PLATES WHERE POSSIBLE.
- 7 PERFORM TESTING OF SYSTEMS AS REQUIRED BY CODE.
  AT COMPLETION OF WORK, FORWARD COPY OF ESA
  CERTIFICATES OF ACCEPTANCE TO ARCHITECT.



148 WALTON STREET, PORT HOPE, ONTARIO L1A 1N6, CANADA TEL: (905) 885-8729 www.picciniarchitect.net

THESE DRAWINGS, DETAILS AND SPECIFICATIONS ARE A CONFIDENTIAL AND PROPRIETARY WORK PROTECTED UNDER COPYRIGHT. ALL RIGHTS ARE RESERVED. THEY ARE THE PROPERTY OF PICCINI ARCHITECT AND MAY NOT BE REPRODUCED BY ANY MEANS, ALTERED OR RE-USED WITHOUT THE EXPRESS WRITTEN PERMISSION OF PICCINI ARCHITECT

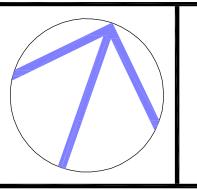

THESE DRAWINGS, DETAILS AND SPECIFICATIONS ARE NOT TO BE USED FOR CONSTRUCTION UNTIL COUNTER-SIGNED BY THE ARCHITECT

NO:	DATE:	ISSUE/REVISION FOR:	BY:
	D.M.Y.		
1	13.02.20	BUILDING PERMIT	R.P.
2	14.05.20	TENDER	R.P.
			_

## CEILING PLAN LEGEND

EX DENOTES EXISTING

EXISTING WALL, PARTITION, OR COLUMN TO REMAIN

NEW WALL, PARTITION, OR CORE ELEMENT

HB HOSE BIB, NON-FREEZE TYPE

GAS METER

FI FOTDICAL

ELECTRICAL METER

ELECTRICAL PANEL

DURI EX RECEPTACIE

DUPLEX RECEPTACLE, 110 VOLT

42=NON-STANDARD MOUNTING HEIGHT
CM=CASEWORK-MOUNTED
FM=FLOOR-MOUNTED IN BOX
GFI=GROUND FAULT INTERRUPTED
Q=QUAD RECEPTACLE
WP=WEATHER-PROOF BOX

LIGHT FIXTURE, PENDANT TYPE, 120V, SUPPLIED BY OWNER

LIGHT FIXTURE, FLUSH MOUNT TYPE, LED 3000K, 120V, THIN LINE DOWN LIGHT, 6.85" DIA., BY MAGICLITE

SWITCH, SINGLE POLE, WALL-MOUNTED,

3=3 WAY, 4=4 WAY
D=WITH DIMMER CONTROL
K=KEY OPERATED SWITCH
M=WITH MOTION SENSOR
P=WITH PILOT LIGHT

EXIT SIGN, ILLUMINATED 120V, WITH RUNNING SYMBOL

EMERGENCY LIGHT, SINGLE OR DOUBLE HEAD AS SHOWN, CEILING OR WALL—MOUNTED

# ADDITION TO THE BLUEBERRY PAVILION

WILMOT ORCHARDS 3377 CONCESSION ROAD 3 CLARINGTON, ON L1B 0N1


SHEET TITLE:

REFLECTED CEILING PLAN

DRAWN BY: RP
PROJECT NO:
19.316

DATE: MAY 2019

CHK'D BY: RP

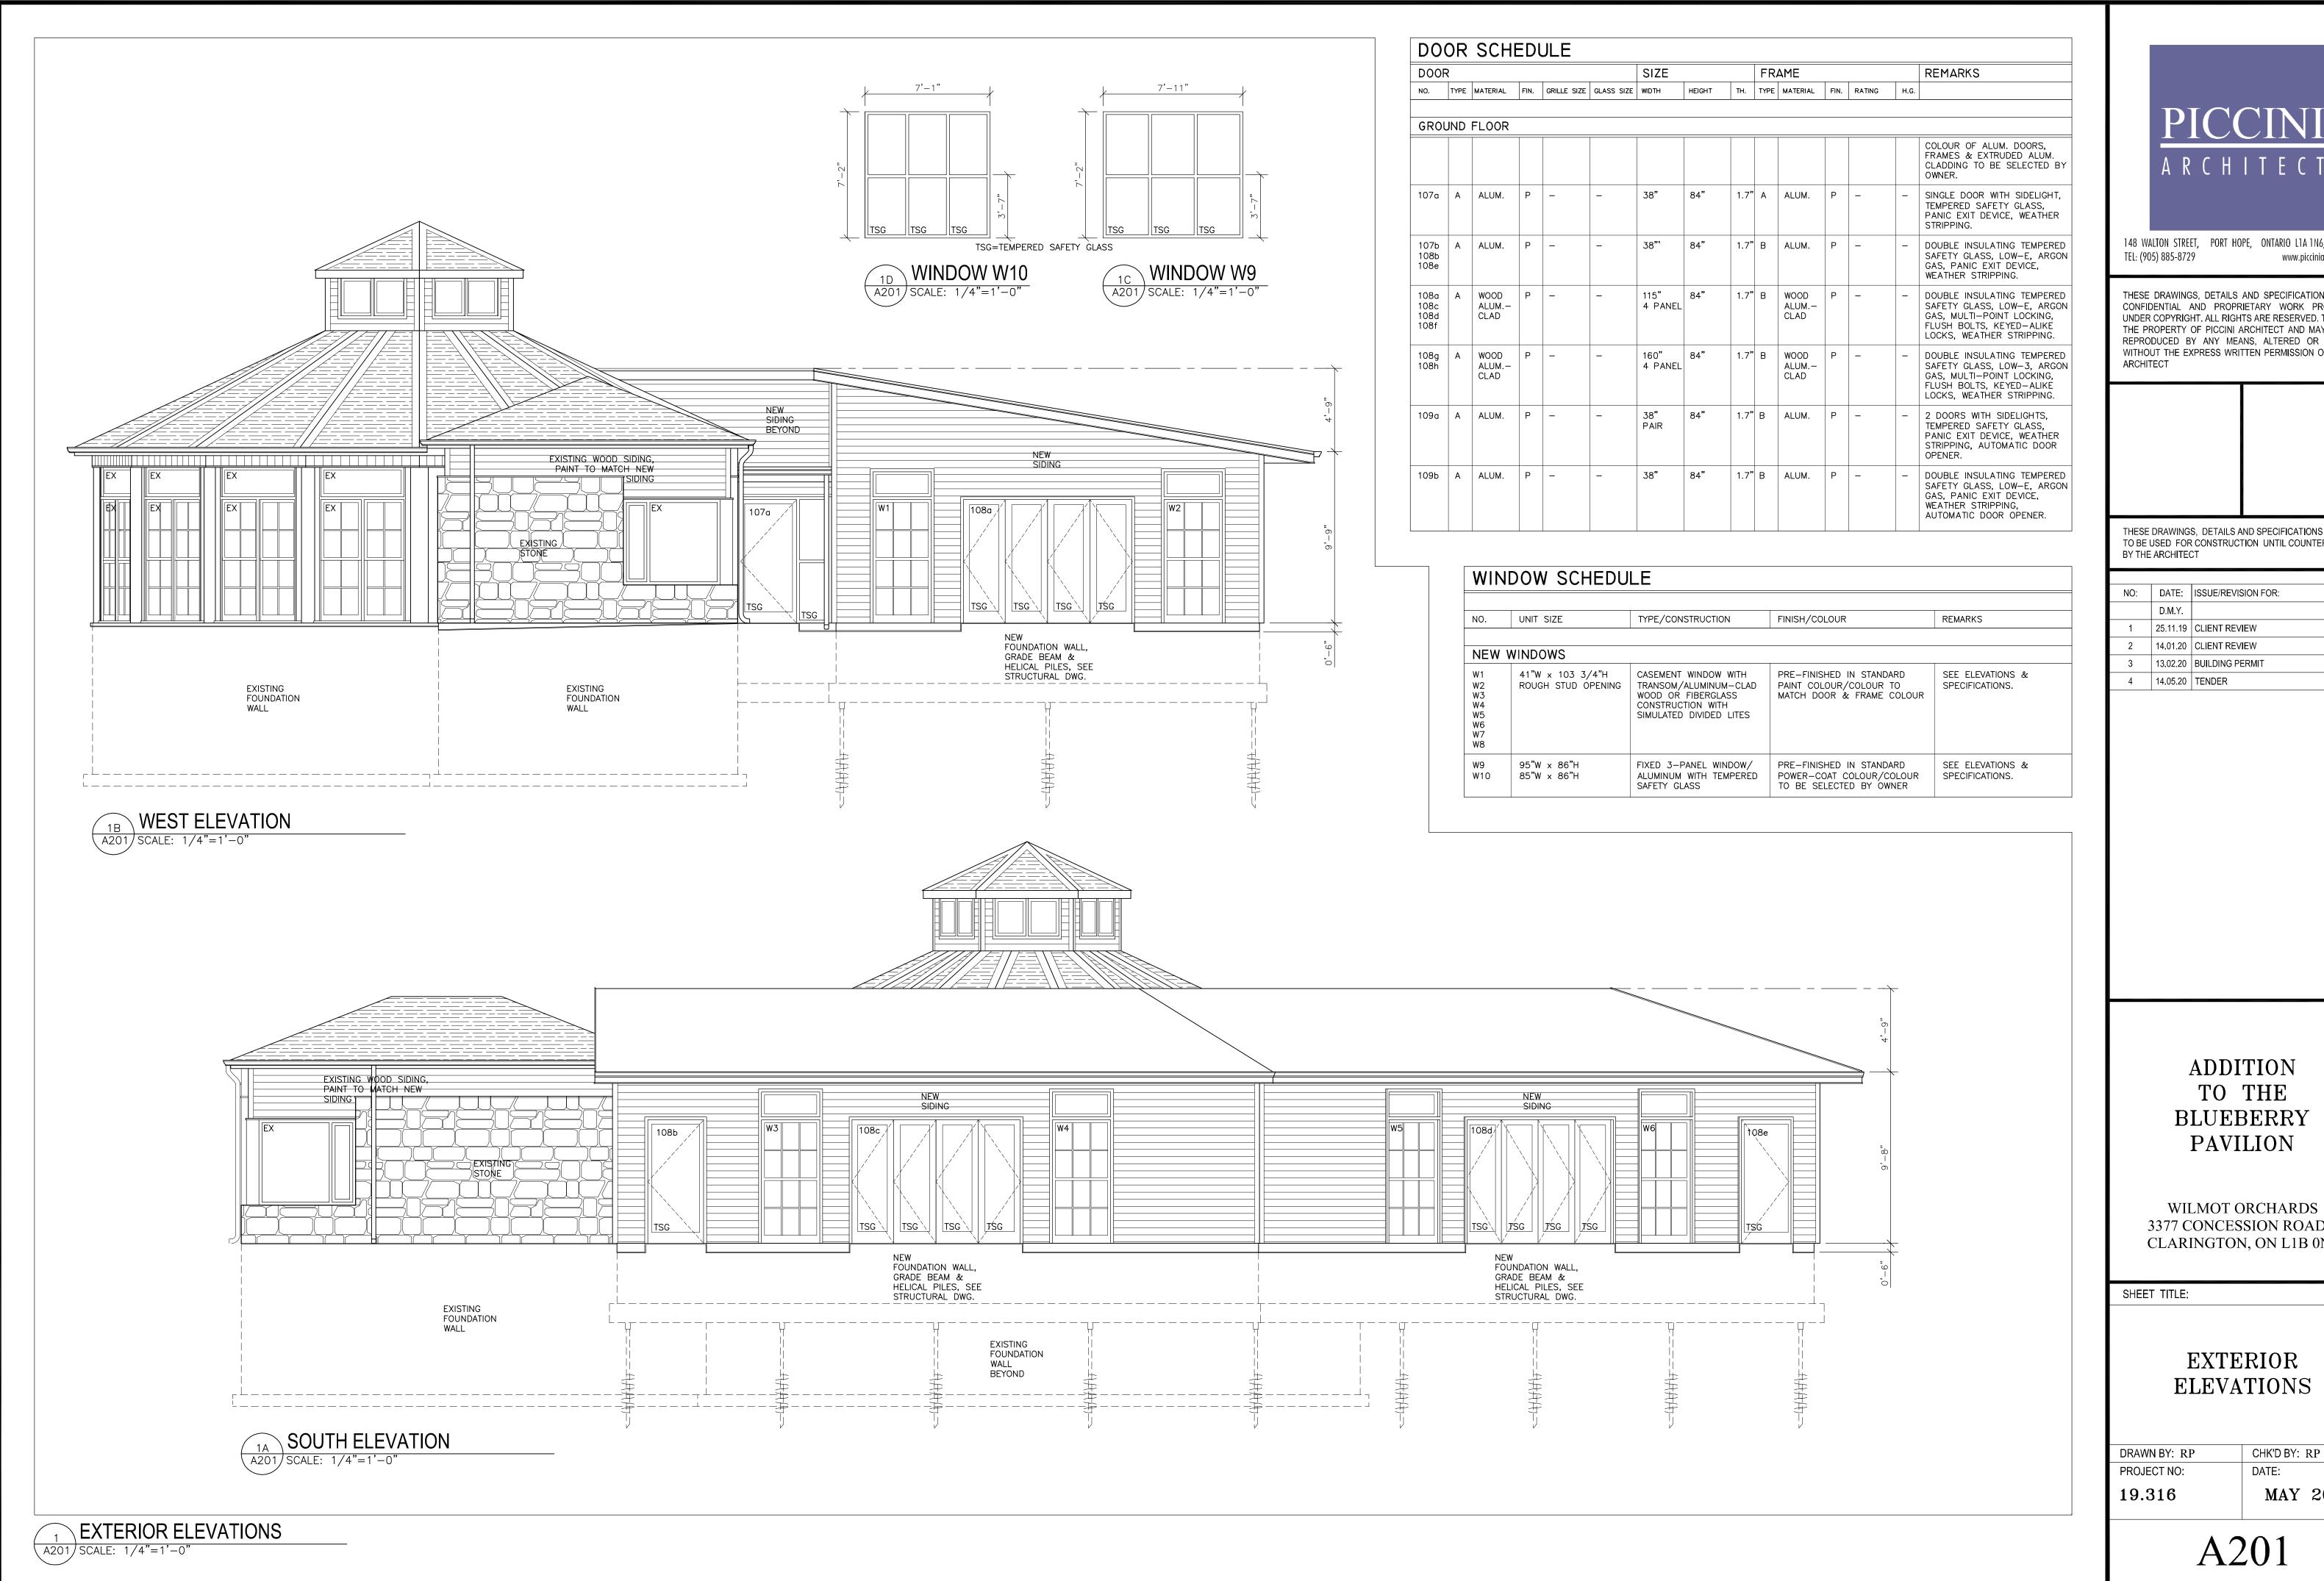



148 WALTON STREET, PORT HOPE, ONTARIO L1A 1N6, CANADA www.picciniarchitect.net

THESE DRAWINGS, DETAILS AND SPECIFICATIONS ARE A CONFIDENTIAL AND PROPRIETARY WORK PROTECTED UNDER COPYRIGHT. ALL RIGHTS ARE RESERVED. THEY ARE THE PROPERTY OF PICCINI ARCHITECT AND MAY NOT BE REPRODUCED BY ANY MEANS, ALTERED OR RE-USED WITHOUT THE EXPRESS WRITTEN PERMISSION OF PICCINI

THESE DRAWINGS, DETAILS AND SPECIFICATIONS ARE NOT TO BE USED FOR CONSTRUCTION UNTIL COUNTER-SIGNED


NO:	DATE:	ISSUE/REVISION FOR:	BY:
	D.M.Y.		
1	25.11.19	CLIENT REVIEW	R.P.
2	14.01.20	CLIENT REVIEW	R.P.
3	13.02.20	BUILDING PERMIT	R.P.
4	14.05.20	TENDER	R.P.

## ADDITION TO THE BLUEBERRY PAVILION

3377 CONCESSION ROAD 3 CLARINGTON, ON L1B 0N1


> **EXTERIOR ELEVATIONS**

CHK'D BY: RP DATE: MAY 2019

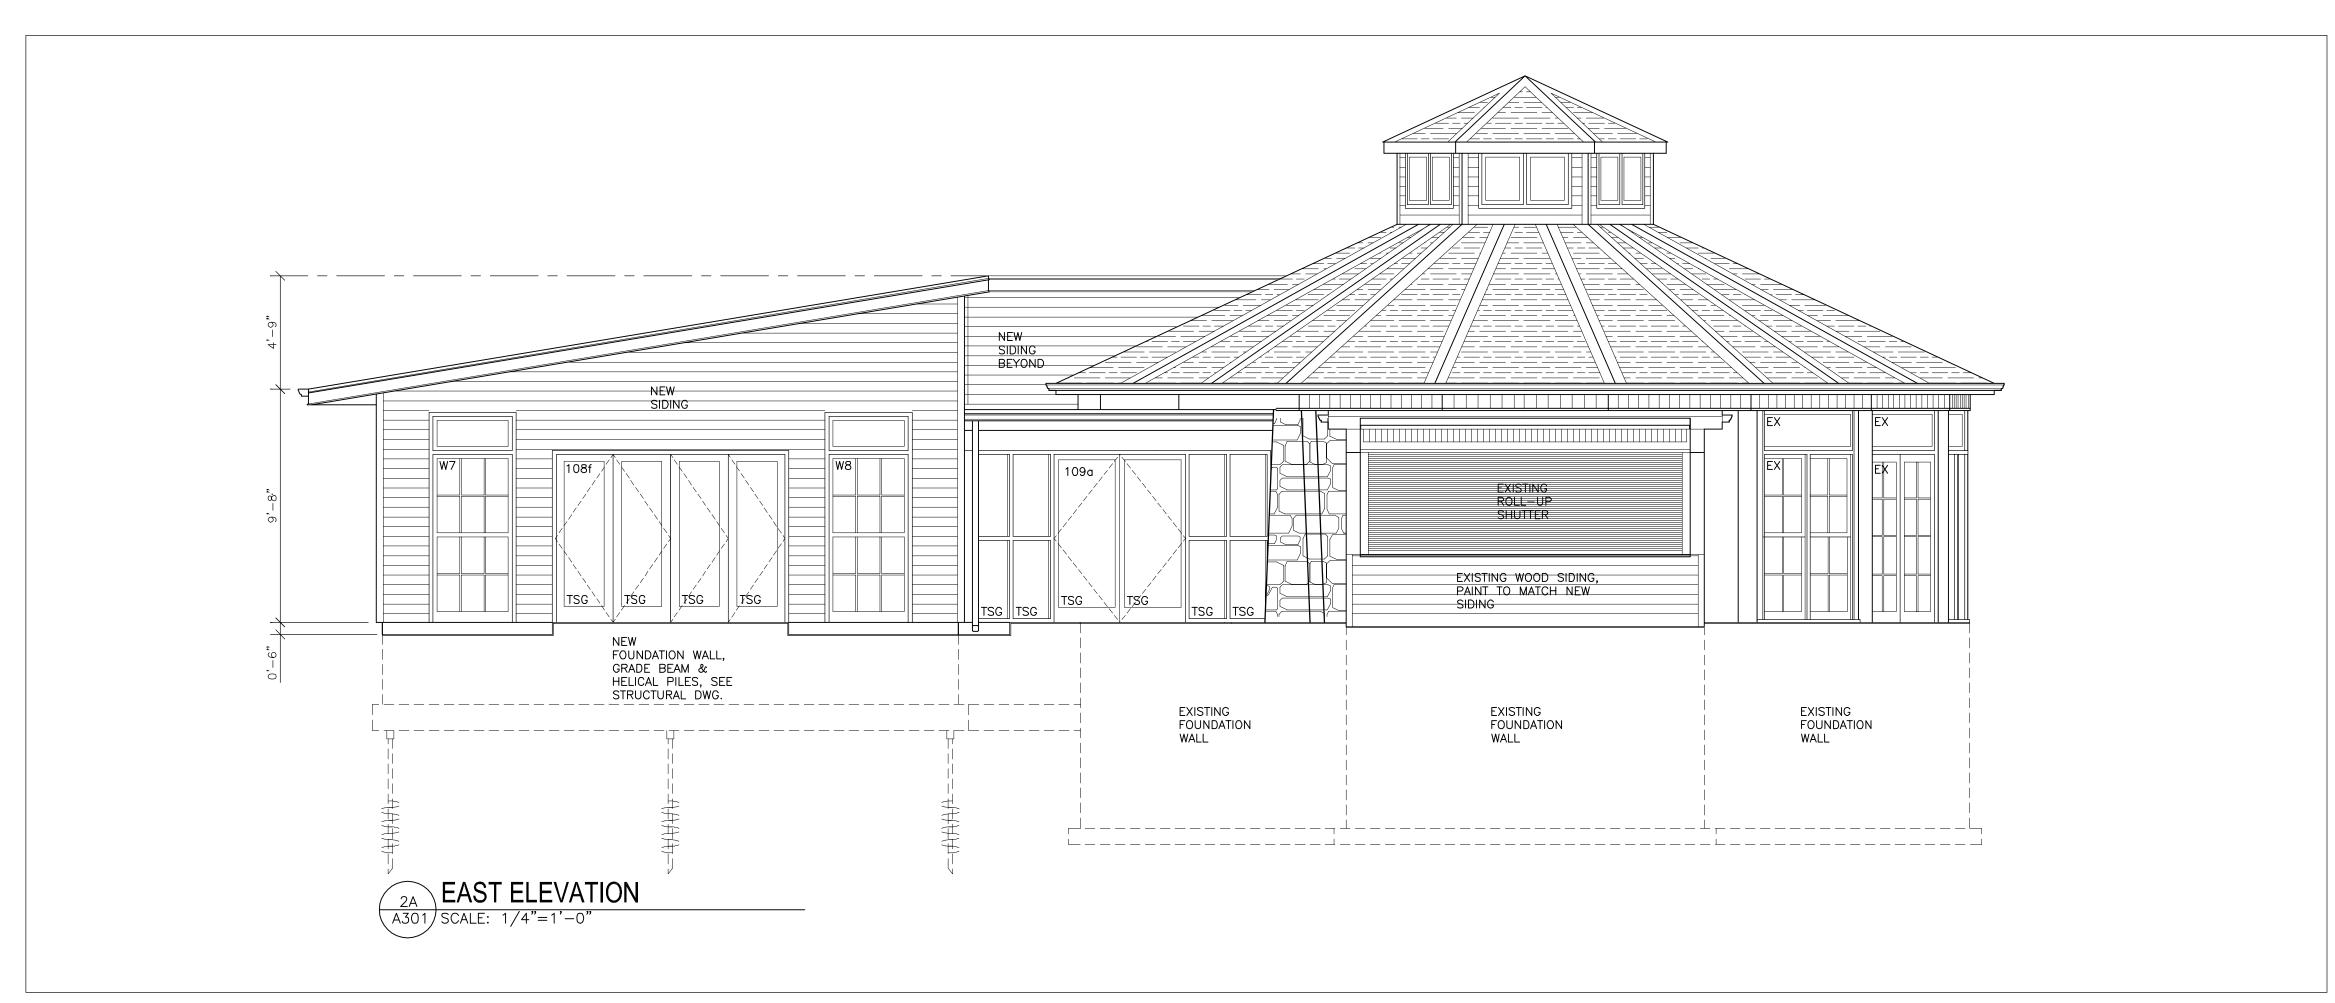

## **EXTERIOR ELEVATION**

A301) SCALE: 1/4"=1'-0"

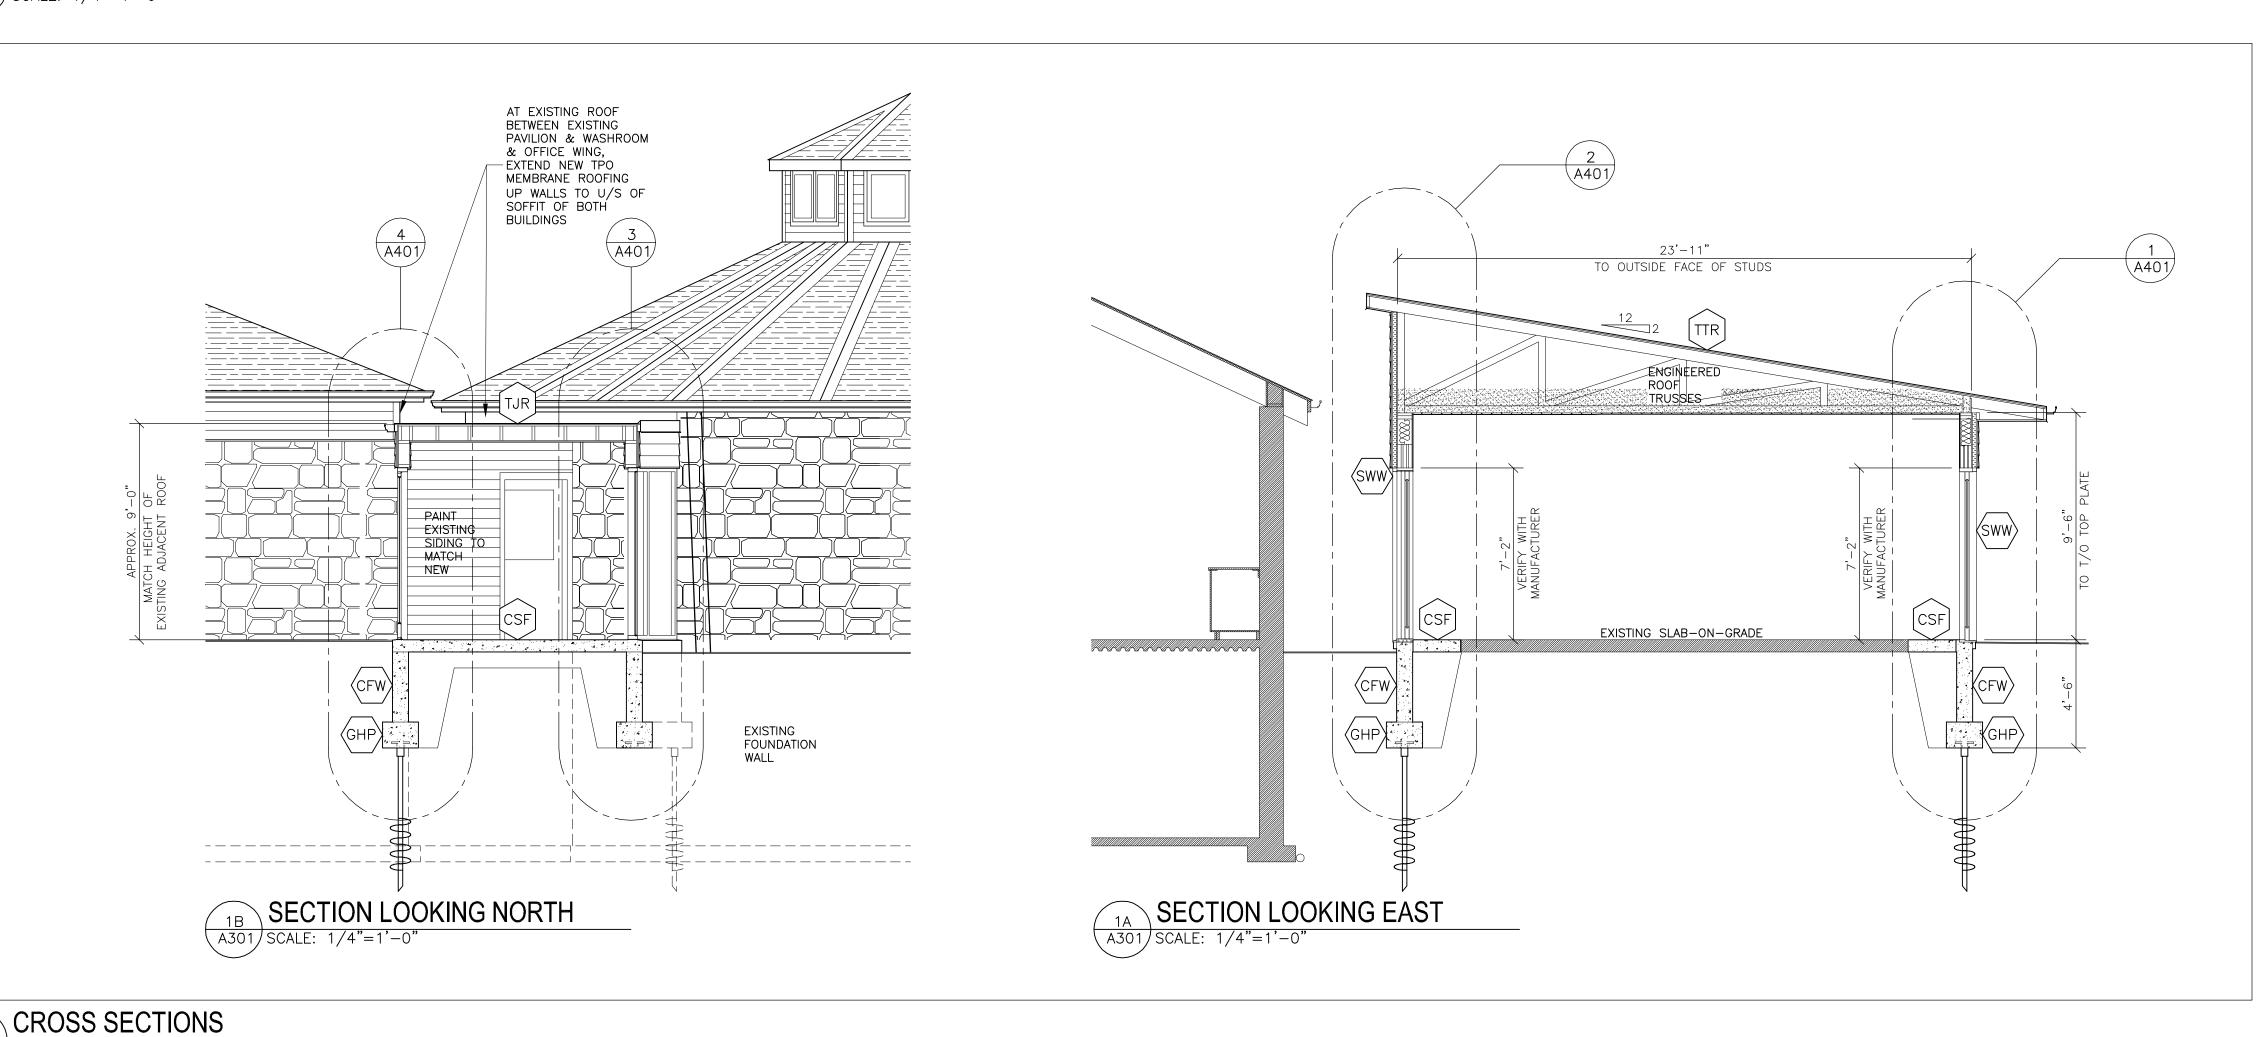

## ROOF ASSEMBLIES

#### TPO ROOF MEMBRANE ON JOIST ROOF

THO ROOFING MEMBRANE, 60mil OR 1.52mm
THICK, FULLY ADHERED & MECHANICALLY
FASTENED, FIRESTONE ULTRAPLY TPO, OVER
-COVER-BOARD SHEATHING, 1/2" OR 12.7mm
THICK, ISOGARD HD BY FIRESTONE,
-PLYWOOD SHEATHING, EXTERIOR GRADE T&G,
5/8" OR 16mm THICK, NAILED & GLUED,
-WOOD ROOF JOISTS, SEE STRUCTURAL DWG.
FOR SIZE & SPACING,
-EXTERIOR GRADE GYPSUM BOARD CEILING,
1/2" OR 12.7mm THICK

#### TPO ROOF MEMBRANE ON TRUSS ROOF

IIOK	OUI FILITIDICANE ON TRUSS ROUT	
		THERMAL RESISTANCE
[TTR]	THO ROOFING MEMBRANE, 60mil OR 1.52mm	
	THICK, FULLY ADHERED & MECHANICALLY FASTENED, FIRESTONE ULTRAPLY TPO, OVER	
	-COVER-BOARD SHEATHING, 1/2" OR 12.7mm	2.50
	THICK, ISOGARD HD BY FIRESTONE,	0.78
	-PLYWOOD SHEATHING, EXTERIOR GRADE T&G, 5/8" OR 16mm THICK, NAILED & GLUED,	0.76
	-ENGINEERED WOOD ROOF TRUSSES, SEE	
	STRUCTURAL DWGS. FOR SPACING, —CELLULOSE INSULATION, BLOWN—IN, TO MIN.	38.00
	DEPTH TO ACHIEVE R VALUE EQUAL TO 38,	36.00
	-POLYETHYLENE AIR/VAPOUR BARRIER, MIN.	
	0.006" OR 0.15mm THICK, ALL JOINTS TAPED,	
	-PINE T&G V-JOINT CLAD CEILING, 3/4" THICK WITH 5" EXPOSURE, NO. 1 & 2 GRADE.	1.05
	R VALUE:	42.33
	RSI VALUE:	7.45

### EXTERIOR WALL ASSEMBLIES

SIDING	SIDING ON WOOD-FRAME WALL			
		THERMAL RESISTANCE		
$\langle SWW \rangle$	-PRE-FINISHED ENGINEERED WOOD LAP SIDING,			
	4.84" EXPOSURE, RESITECH BY MAIBEC,			
	COLOUR TO BE CONFIRMED BY OWNER, -WOOD STRAPPING, 1x3 OR 19x64mm, SPACED			
	VERTICALLY 16" OR 406mm OC OVER STUDS,			
	-RIGID EPS INSULATION, WITH REFLECTIVE	10.00		
	LAMINATION BOTH SIDES, STAGGERED LAYOUT			
	OF 4'x8' OR 1.2x2.4m SHEETS, EDGES BUTTING TIGHTLY & JOINTS TAPED.			
	SILVERBOARD BY AMVIC OR APPROVED EQUAL,			
	-PLYWOOD SHEATHING, 1/2" OR 12.7mm THICK,	0.63		
	-WOOD STUDS, 2x6 OR 38x140mm, SPACED			
	16" OR 406mm OC, WITH 2x6 WOOD BLOCKING AT MID HEIGHT,			
	-FIBERGLASS BATT INSULATION, 5 1/2" OR	21.50		
	140mm THICK IN STUD CAVITIES,			
	-POLYETHYLENE AIR/VAPOUR BARRIER, MIN.			
	0.006" OR 0.15mm THICK, LAPPED 1 STUD FRAMING MODULE WITH ALL JOINTS TAPED,			
	GYPSUM BOARD COVER, 1/2" OR 12.7mm	0.45		
	THICK,			
	R VALUE:	41.71		
	RSI VALUE:	7.3		

### FLOOR ASSEMBLIES

#### CONCRETE SLAB-ON-GRADE FLOOR

-POURED CONCRETE FLOOR SLAB, MIN. 4" OR 102mm THICK, BROOM FINISH, MATCH FINISH OF EXISTING SLAB, 2900 psi OR 20 MPa COMPRESSIVE STRENGTH AFTER 28 DAYS, WITH 6x6 6/6 WELDED WIRE MESH SHEET REINFORCING AT SLAB CENTRE, -GRANULAR 'A' MIN. 8" OR 200mm BASE, COMPACTED TO 98% SPMDD, OVER PROOF-ROLLED NATIVE SOIL TO 20 MPa/m. ADJACENT FOUNDATION WALLS, COMPACT GRANULAR FILL IN MAXIMUM 6" OR 150mm LIFTS. SEE STRUCTURAL DWG.

#### FOUNDATION ASSEMBLIES

### CONCRETE FOUNDATION WALL

-CONCRETE FOUNDATION WALL, SEE STRUCTURAL DWG. FOR REINFORCEMENT DETAIL & CONCRETE STRENGTH.

#### GRADE BEAM & HELICAL PILES

GHP -CONCRETE GRADE BEAM & HELICAL PILES, SEE STRUCTURAL DWG. FOR REINFORCEMENT DETAIL, CONCRETE STRENGTH & HELICAL PILE NOTES.



148 WALTON STREET, PORT HOPE, ONTARIO L1A 1N6, CANADA TEL: (905) 885-8729 www.picciniarchitect.net

THESE DRAWINGS, DETAILS AND SPECIFICATIONS ARE A CONFIDENTIAL AND PROPRIETARY WORK PROTECTED UNDER COPYRIGHT. ALL RIGHTS ARE RESERVED. THEY ARE THE PROPERTY OF PICCINI ARCHITECT AND MAY NOT BE REPRODUCED BY ANY MEANS, ALTERED OR RE-USED WITHOUT THE EXPRESS WRITTEN PERMISSION OF PICCINI ARCHITECT

THESE DRAWINGS, DETAILS AND SPECIFICATIONS ARE NOT TO BE USED FOR CONSTRUCTION UNTIL COUNTER-SIGNED BY THE ARCHITECT

10:	DATE:	ISSUE/REVISION FOR:	BY:
	D.M.Y.		
1	25.11.19	CLIENT REVIEW	R.P.
2	14.01.20	CLIENT REVIEW	R.P.
3	13.02.20	BUILDING PERMIT	R.P.
4	14.05.20	TENDER	R.P.

## ADDITION TO THE BLUEBERRY PAVILION

WILMOT ORCHARDS 3377 CONCESSION ROAD 3 CLARINGTON, ON L1B 0N1

SHEET TITLE:

SECTIONS & EXTERIOR ELEVATION

 DRAWN BY: RP
 CHK'D BY: RP

 PROJECT NO:
 DATE:

 19.316
 MAY 2019

