

P-300

SCALE: NTS

GENERAL NOTES

1. VERIFY ALL DIMENSIONS PRIOR TO CONSTRUCTION.

- 2. DO NOT SCALE DRAWINGS.
- 3. REPORT ALL DISCOVERIES OF ERRORS, OMISSIONS OR DISCREPANCIES TO THE DESIGN ENGINEER AS APPLICABLE.
- 4. USE ONLY LATEST REVISED DRAWINGS OR THOSE THAT ARE MARKED "ISSUED FOR CONSTRUCTION".
- 5. DESIGN AND CONSTRUCTION OF THIS PROJECT SHALL COMPLY WITH THE PROVINCIAL AND LOCAL BUILDING CODES LATEST EDITION.
- 6. ALL WORKS AND MATERIALS USED SHALL COMPLY AS REQUIRED BY THE BUILDING CODE LATEST EDITION.
- 7. THIS DRAWING SHALL BE READ IN CONJUNCTION WITH ALL RELEVANT DRAWINGS & SPECIFICATIONS.
- 8. EVERYTHING IS TO BE CONSIDERED NEW UNLESS SPECIFIED EXISTING OTHERWISE.

GRADING AND SERVICING NOTES

- 1. ALL DIMENSIONS AND ELEVATIONS ARE METRIC, UNLESS NOTED OTHERWISE.
- 2. ALL DIMENSIONS AND DESIGN ELEVATIONS MUST BE VERIFIED BY THE CONTRACTOR PRIOR TO CONSTRUCTION. ANY DISCREPANCIES MUST BE BROUGHT TO THE ATTENTION OF THE DESIGN ENGINEER OR ARCHITECT WHERE APPLICABLE.
- 3. THE CONTRACTOR SHALL RESTORE TO ORIGINAL OR BETTER CONDITION FOR ANY EXISTING CONDITION DISTURBED DURING THE CONSTRUCTION AT CONTRACTOR'S **EXPENSE**
- 4. CONTROL MANHOLES ARE TO BE BENCHED TO THE
- 5. LANDSCAPING SHALL NOT ENCROACH ON BOULEVARD NOR SHALL BOULEVARD GRADES BE ALTERED.
- MUNICIPALITY CONSTITUTE PART OF THE PLANS OF THE
- 7. ANY CONFLICT WITH EXISTING SERVICES SHALL BE RECTIFIED AS PER REGION OR MUNICIPAL REQUIREMENTS.
- 8. 8. MINIMUM VERTICAL AND HORIZONTAL SEPARATION BETWEEN THE INVERTS OF THE SEWER AND A CROWN OF A WATER MAIN SHALL COMPLY WITH THE REGION AND LOCAL BY-LAWS AT ALL CROSSINGS.
- 9. ALL CONCRETE CURBS FROM EXISTING ROAD CURB TO STREET LINE SHALL BE STD CURB AND GUTTER AS PER OPSD 600.040. ALL CONCRETE CURB HEIGHTS SHALL BE 150mm ABOVE FINISHED GRADE (A.F.G.) UNLESS OTHERWISE NOTED. DRIVEWAY CURBS ARE TO BE DISCONTINUOUS AT SIDEWALKS AND TAPERED BACK MINIMUM OF 300mm OR TO THE APPROVAL OF DESIGN
- 10. ALL REQUIRED CURB CUTTING AT ENTRANCES AND CURB DEPRESSIONS AT SIDEWALK CROSSINGS SHALL BE INSTALLED TO THE APPROVAL OF THE DESIGN ENGINEER.
- 11. A MINIMUM CLEARANCE OF 1000mm FROM ALL ABOVE GROUND SERVICES AND UTILITIES IS REQUIRED. ¹12. INSTALLATION OF WATER MAIN IN PRIVATE PROPERTY
- SHALL COMPLY WITH THE MUNICIPAL AND LOCAL BY-LAWS. _13. OUTDOOR LIGHTS ARE TO BE DIRECTED DOWNWARDS AS WELL AS INWARD.
- 14. THE CONTRACTOR IS RESPONSIBLE FOR LOCATING AND PROTECTING ALL UTILITIES DURING CONSTRUCTION. BELL, HYDRO, GAS, OR ANY OTHER UTILITIES THAT MAY EXIST ON THE SITE OR WITHIN THE STREET LINE MUST BE LOCATED AND VERIFIED BY THE RESPECTIVE UTILITY COMPANY PRIOR TO CONSTRUCTION.
- 15. ALL SANITARY SEWER, STORM SEWER, AND WATER MAIN ON PRIVATE PROPERTY ARE TO BE INSTALLED IN ACCORDANCE WITH THE PROVINCIAL BUILDING CODE.
- 16. ALL WATER MAIN AND HYDRANT INSTALLATIONS ARE TO BE CARRIED OUT IN ACCORDANCE WITH THE LATEST PLANS, STANDARDS, AND SPECIFICATIONS OF THE LOCAL UTILITIES
- 17. NO BLASTING IS PERMITTED ON THE TOWN RIGHT-OF-WAY AND NEAR ANY ADJACENT BUILDING.
- 18. THE TOP OF CONCRETE CURBS ABUTTING TOWN'S SIDEWALKS SHALL BE KEPT LEVEL WITH THE SIDEWALKS FOR A DISTANCE OF 600mm FROM THE SIDEWALK.
- 19. THE PROPERTY IS TO BE GRADED AND SELF-CONTAINED SO THAT SURFACE DRAINAGE IS DIRECTED AWAY FROM THE BUILDINGS.
- 20. THE OWNER AND/OR CONTRACTOR IS REQUIRED TO OBTAIN A "ROAD CUT PERMIT" FROM THE TOWN BEFORE COMMENCING ANY WORK ON THE TOWN'S ROAD



TYP. PAVEMENT SECTION

SCALE: NTS



KEY PLAN SCALE: NTS PLAN OF SURVEY OF BLOCK 3 REGISTERED PLAN 40M-2486 TOWN OF AJAX REGIONAL MUNICIPALITY OF DURHAM

METRIC

DISTANCES AND COORDINATES SHOWN ON THIS PLAN ARE IN METRES AND CAN BE CONVERTED TO FEET BY DIVIDING BY 0.3048

BEARING NOTE

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DISTANCE NOTE


DISTANCES SHOWN HEREON ARE GROUND DISTANCES AND CAN BE CONVERTED TO GRID DISTANCES BY MULTIPLYING BY A COMBINED SCALE FACTOR OF 0.999902.

BENCHMARK NOTE

ELEVATIONS ARE REFERRED TO THE TOWN OF AJAX BENCHMARK No. 703, LOCATED 11.1m WEST OF WEST FACE OF CONCRETE CURB ON SALEM ROAD NORTH, 22.0m NORTH, OF CENTRELINE OF ENTRANCE TO COSTCO AND 185.0m SOUTH OF CENTRELINE OF RINGER ROAD. TABLET IS SET ON TOP OF SOUTHEAST CORNER OF CONCRETE OUTFALL STRUCTURE. HAVING AN ELEVATION OF 102.595 m.

VERTICAL DATUM: CANADIAN GEODETIC DATUM, 1928 (1978 SOUTHERN ONTARIO READJUSTMENT)

<u>LEGEND</u>

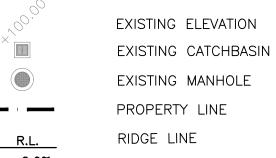

2.0% SLOPE PROPOSED ELEVATION + 100.00

MATCH EXIST. ELEVATION + 100.00* PROP. ELE. (CURB TOP) - 100.15 PROP. ELE. (CURB BOTTOM)

NEW CATCHBASIN NEW STORMCEPTOR EFO4 NEW MANHOLE

PROP. SWALE MAX 3:1 SLOPE

HEAVY DUTY ASPHALT PAVING

No.	Date	Description	Drawn Checked
0	20 MAR '24	ISSUED FOR REVIEW	JM JS
1	05 APR '24	ISSUED FOR REVIEW	JM JS
2	19 APR '24	REVISED AS PER SITEPLAN	JM JS
3	28 MAY '24	REVISED AS PER SITEPLAN	JM JS

REVISIONS

J + B ENGINEERING INC CALGARY 707-10TH AVE. SW 25 CENTURIAN DR.


SUITE 201 SUITE 150
MARKHAM, ON L3R 5N8 CALGARY AB T2R 0B3
416 229 2636 403 355 2295

Project:

GRADING PLAN

45 BLOWERS CRES Date: 07 MAR '24 ACAD INFO File No: 230152 Drawn By: **HR** Scale: **1:200** Sheet 1 of 1 Plotting Scale: 1=1 Checked By: JS

AJAX, ON Dwg. File: 230152 P-300 Drawing Size: **D** Drawing No: P-300

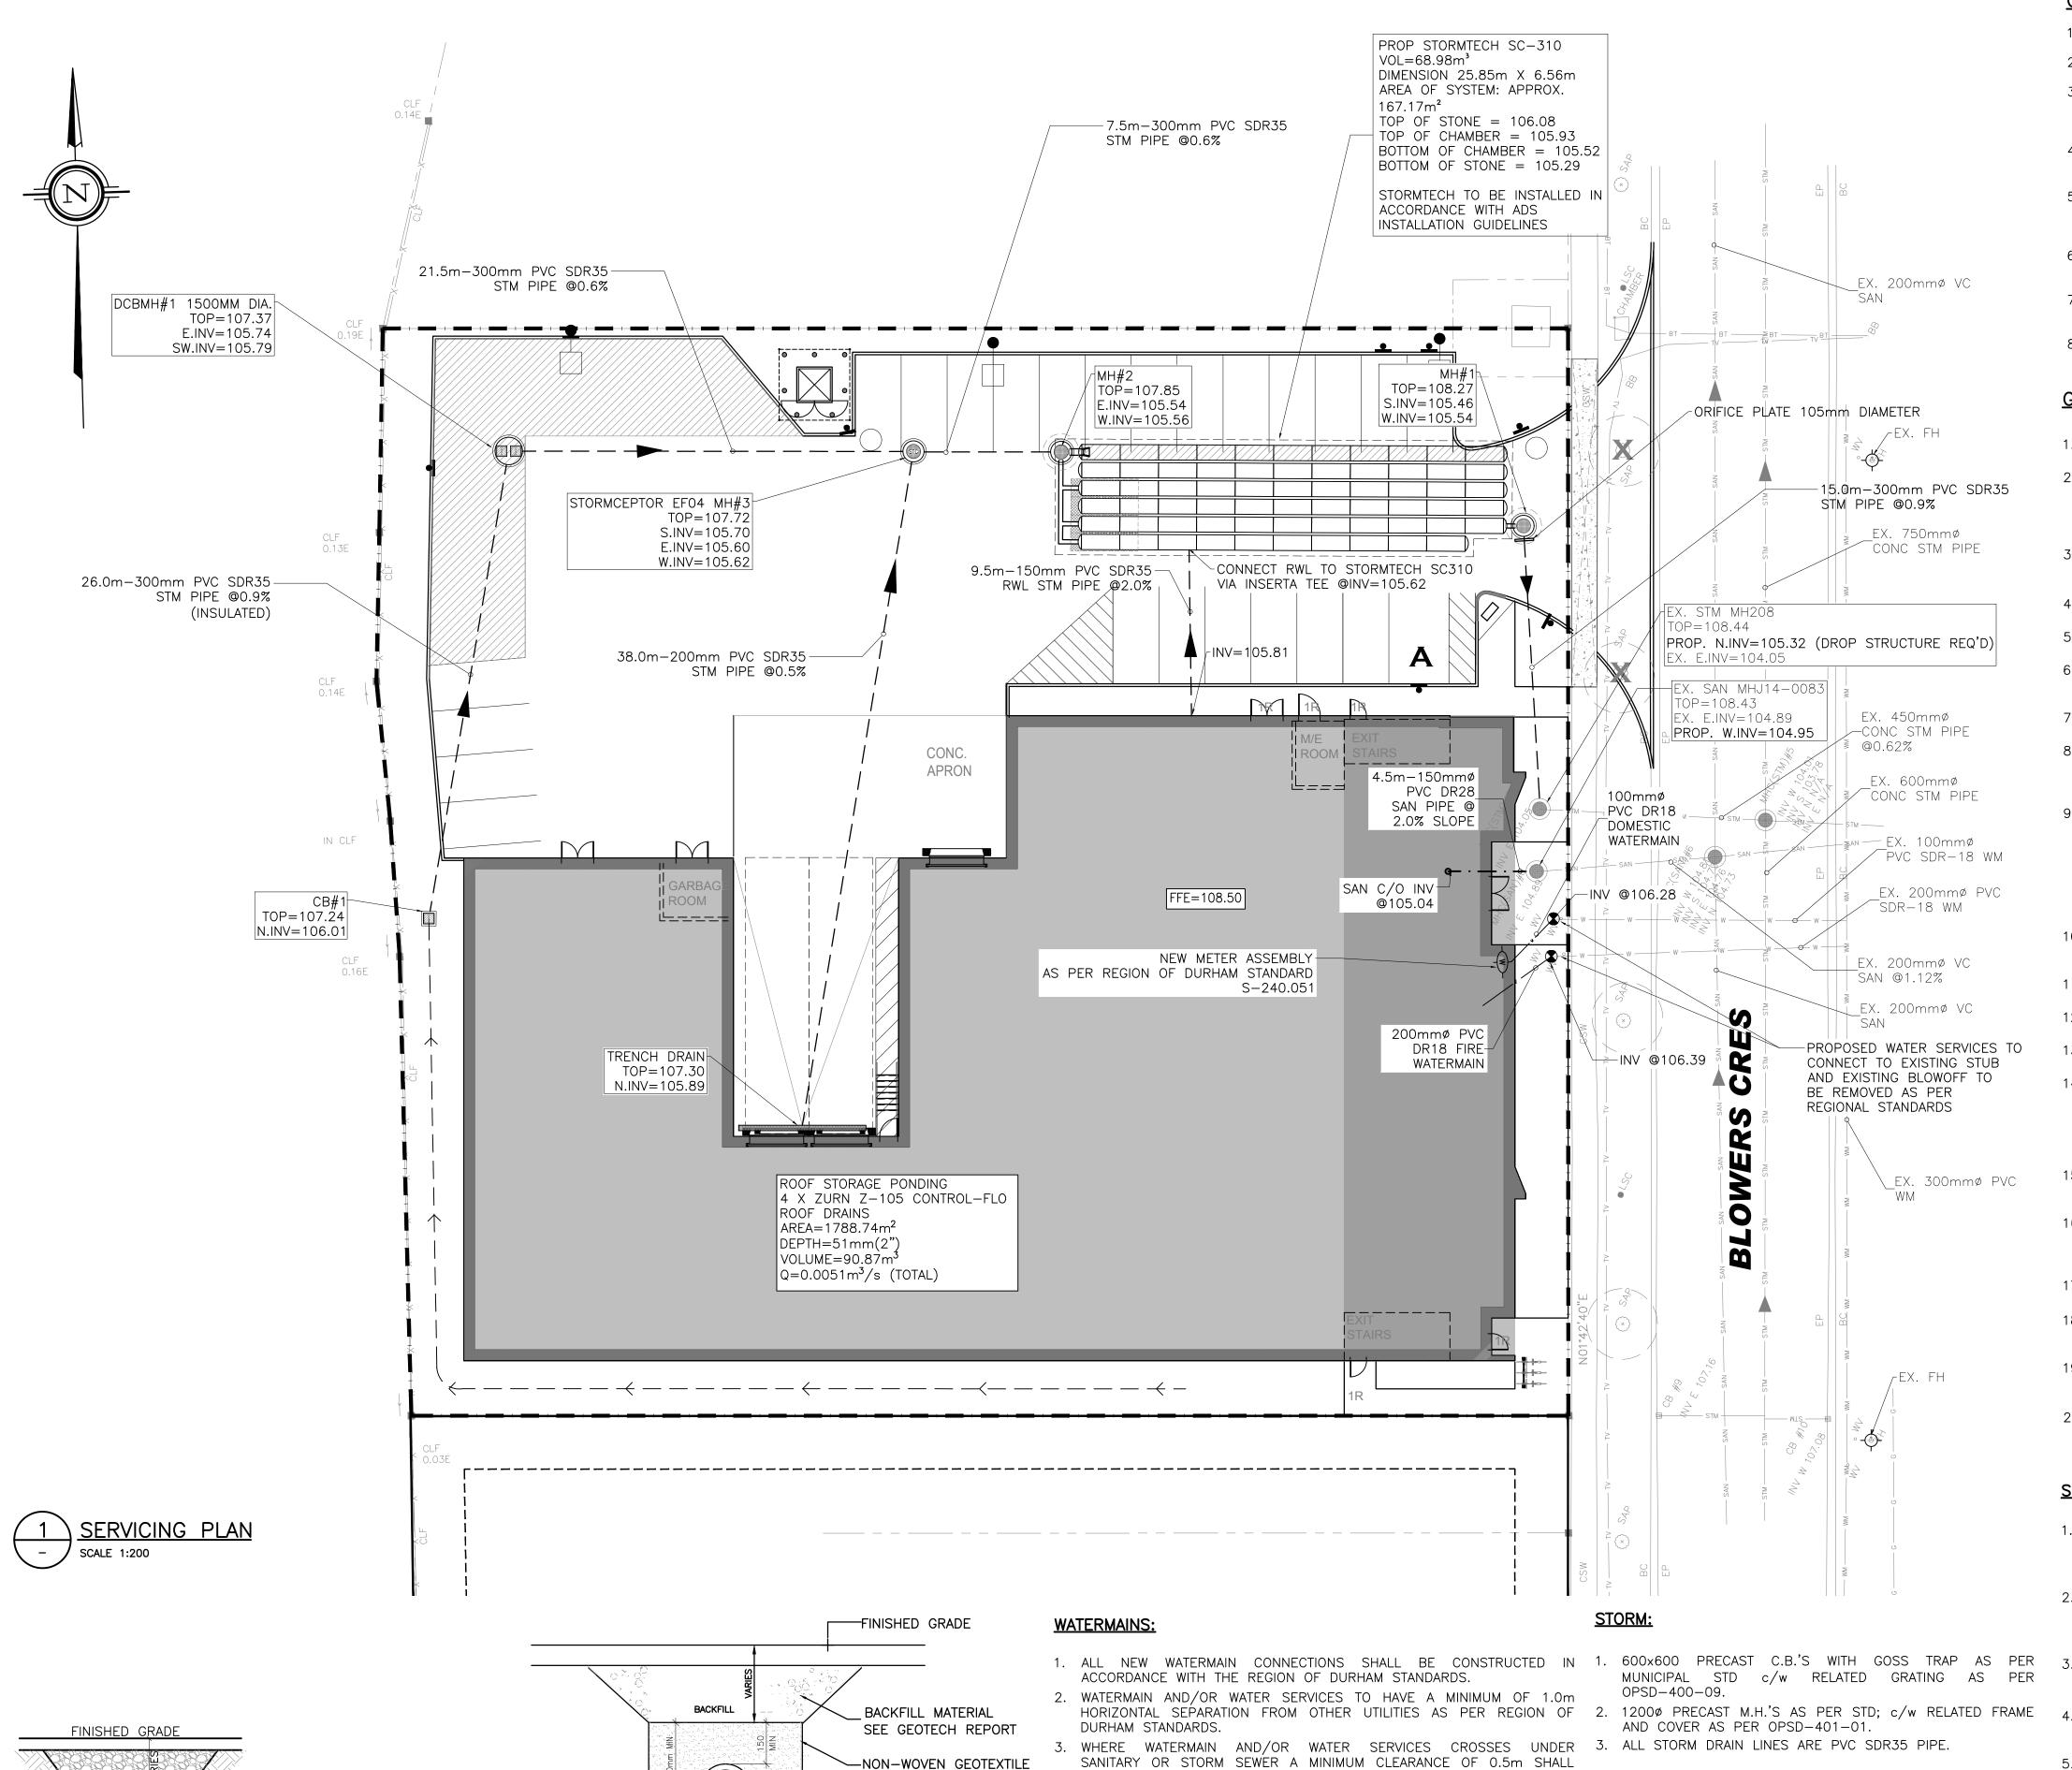

BE PROVIDED.

UTILITIES.

DURHAM STANDARDS.

AROUND BETWEEN NATIVE 4. WATER SERVICE TO HAVE MIN. 1.8m COVER AS PER REGION OF

-FREE DRAINING GRANULAR 6. MINIMUM CLEARANCE OF 1.0m FROM ALL ABOVE GROUND SERVICES AND

5. CONTRACTOR TO PROVIDE PRESSURE TEST RESULTS OF NEW WATERMAIN.

FILTER FABRIC ALL

MATERIALS

SOIL AND BEDDING/FILL

UNDISTURBED SOIL -+

PIPE DIA. + 610mm

FOR BACKFILL

SCALE: NTS

REQUIREMENTS

REFER TO GEOTECH REPORT

PIPE BEDDING DETAIL

PERVIOUS PIPE -

-APPROVED BACKFILL

OR EQUIVALENT

-UNDISTURBED SOIL

PIPE Ø + VARIES

P-301 SCALE: NTS

TYP. FROST PROTECTION DETAIL

_50mm STYROFOAM DOW SM

-APPROVED BEDDING MATERIAL

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SERVICES NOTES:

- 1. CONTACT LOCAL UTILITY AGENCIES (GAS, HYDRO & TELEPHONE) TO LOCATE THE EXISTING INCOMING SERVICES, AND USE THE SAME TO SERVE NEW INSTALLATIONS (IF APPLICABLE).
- 2. PRIVATE WATER SUPPLY PIPES ARE DESIGNED IN ACCORDANCE TO MINISTRY OF THE ENVIRONMENT PIBS 6881e, "DESIGN GUIDELINES FOR DRINKING-WATER SYSTEMS".
- 3. PRIVATE SEWERS ARE DESIGNED IN ACCORDANCE WITH THE MINISTRY OF ENVIRONMENT PIBS 6879, "DESIGN GUIDELINES FOR SEWAGE WORKS".
- 4. ALL SERVICES WITHIN TOWN OF AJAX ROW TO BE CONSTRUCTED WITH A VERTICAL TRENCH AND BACKFILL AS PER TOWN STANDARDS AS-173 AND AS-135
- 5. BEDDING AS PER REGION OF DURHAM STANDARD S-200.010 OR TOWN OF AJAX STANDARDS.

<u>SANITARY</u>

- 1. 1200¢ PRECAST M.H'S AS PER OPSD 701.01 c/w
- RELATED GRATING AS PER OPSD 401.030. 2. DROP STRUCTURE IF REQUIRED AS PER REGION OF
- DURHAM STANDARDS S-100.080. 3. BEDDING AS PER REGION OF DURHAM STANDARD
- S-200.010. 4. BENCHING AS PER OPSD 701.021.
- 5. SANITARY PIPES TO BE PVC SDR35 UNLESS OTHERWISE



KEY PLAN SCALE: NTS

PLAN OF SURVEY OF BLOCK 3

REGISTERED PLAN 40M-2486 TOWN OF AJAX

REGIONAL MUNICIPALITY OF DURHAM

DISTANCES AND COORDINATES SHOWN ON THIS PLAN ARE IN METRES AND CAN BE CONVERTED TO FEET BY DIVIDING BY 0.3048

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<u>LEGEND</u>

DENOTES SURVEY MONUMENT FOUND

SURVEY MONUMENT PLANTED STANDARD IRON BAR

EXISTING ELEVATION

SHORT STANDARD IRON BAR SSIB IRON BAR

EXISTING CATCHBASIN EXISTING MANHOLE

EXISTING FIRE HYDRANT EXISTING WATER VALVE

EXISTING SANITARY LINE EXISTING STORM LINE

EXISTING WATER LINE PROPERTY LINE


NEW CATCHBASIN

NEW STORMCEPTOR EF04 NEW MANHOLE

NEW FIRE WATER LINE

NEW DOMESTIC WATER LINE NEW SANITARY LINE NEW STORM LINE -----

PROP. SWALE - o -

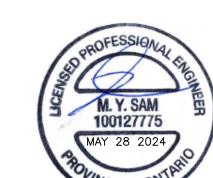

3	28 MAY '24	REVISED AS PER SITEPLAN	JM	JS		
2	19 APR '24	REVISED AS PER SITEPLAN	JM	JS		
1	05 APR '24	ISSUED FOR REVIEW	JM	JS		
0	20 MAR '24	ISSUED FOR REVIEW	JM	JS		
No.	Date	Description	Drawn	Checked		




J + B ENGINEERING INC CALGARY 707-10TH AVE. SW 25 CENTURIAN DR. SUITE 201 SUITE 150
MARKHAM, ON L3R 5N8 CALGARY AB T2R 0B3

SERVICING PLAN

45 BLOWERS CRES AJAX, ON File No: 230152 Date: 07 MAR '24 ACAD INFO Scale: 1:200


Drawn By: **HR** Dwg. File: 230152 P-301 Sheet 1 of 1 Plotting Scale: 1=1 Checked By: JS Drawing Size: **D** Drawing No: P-301

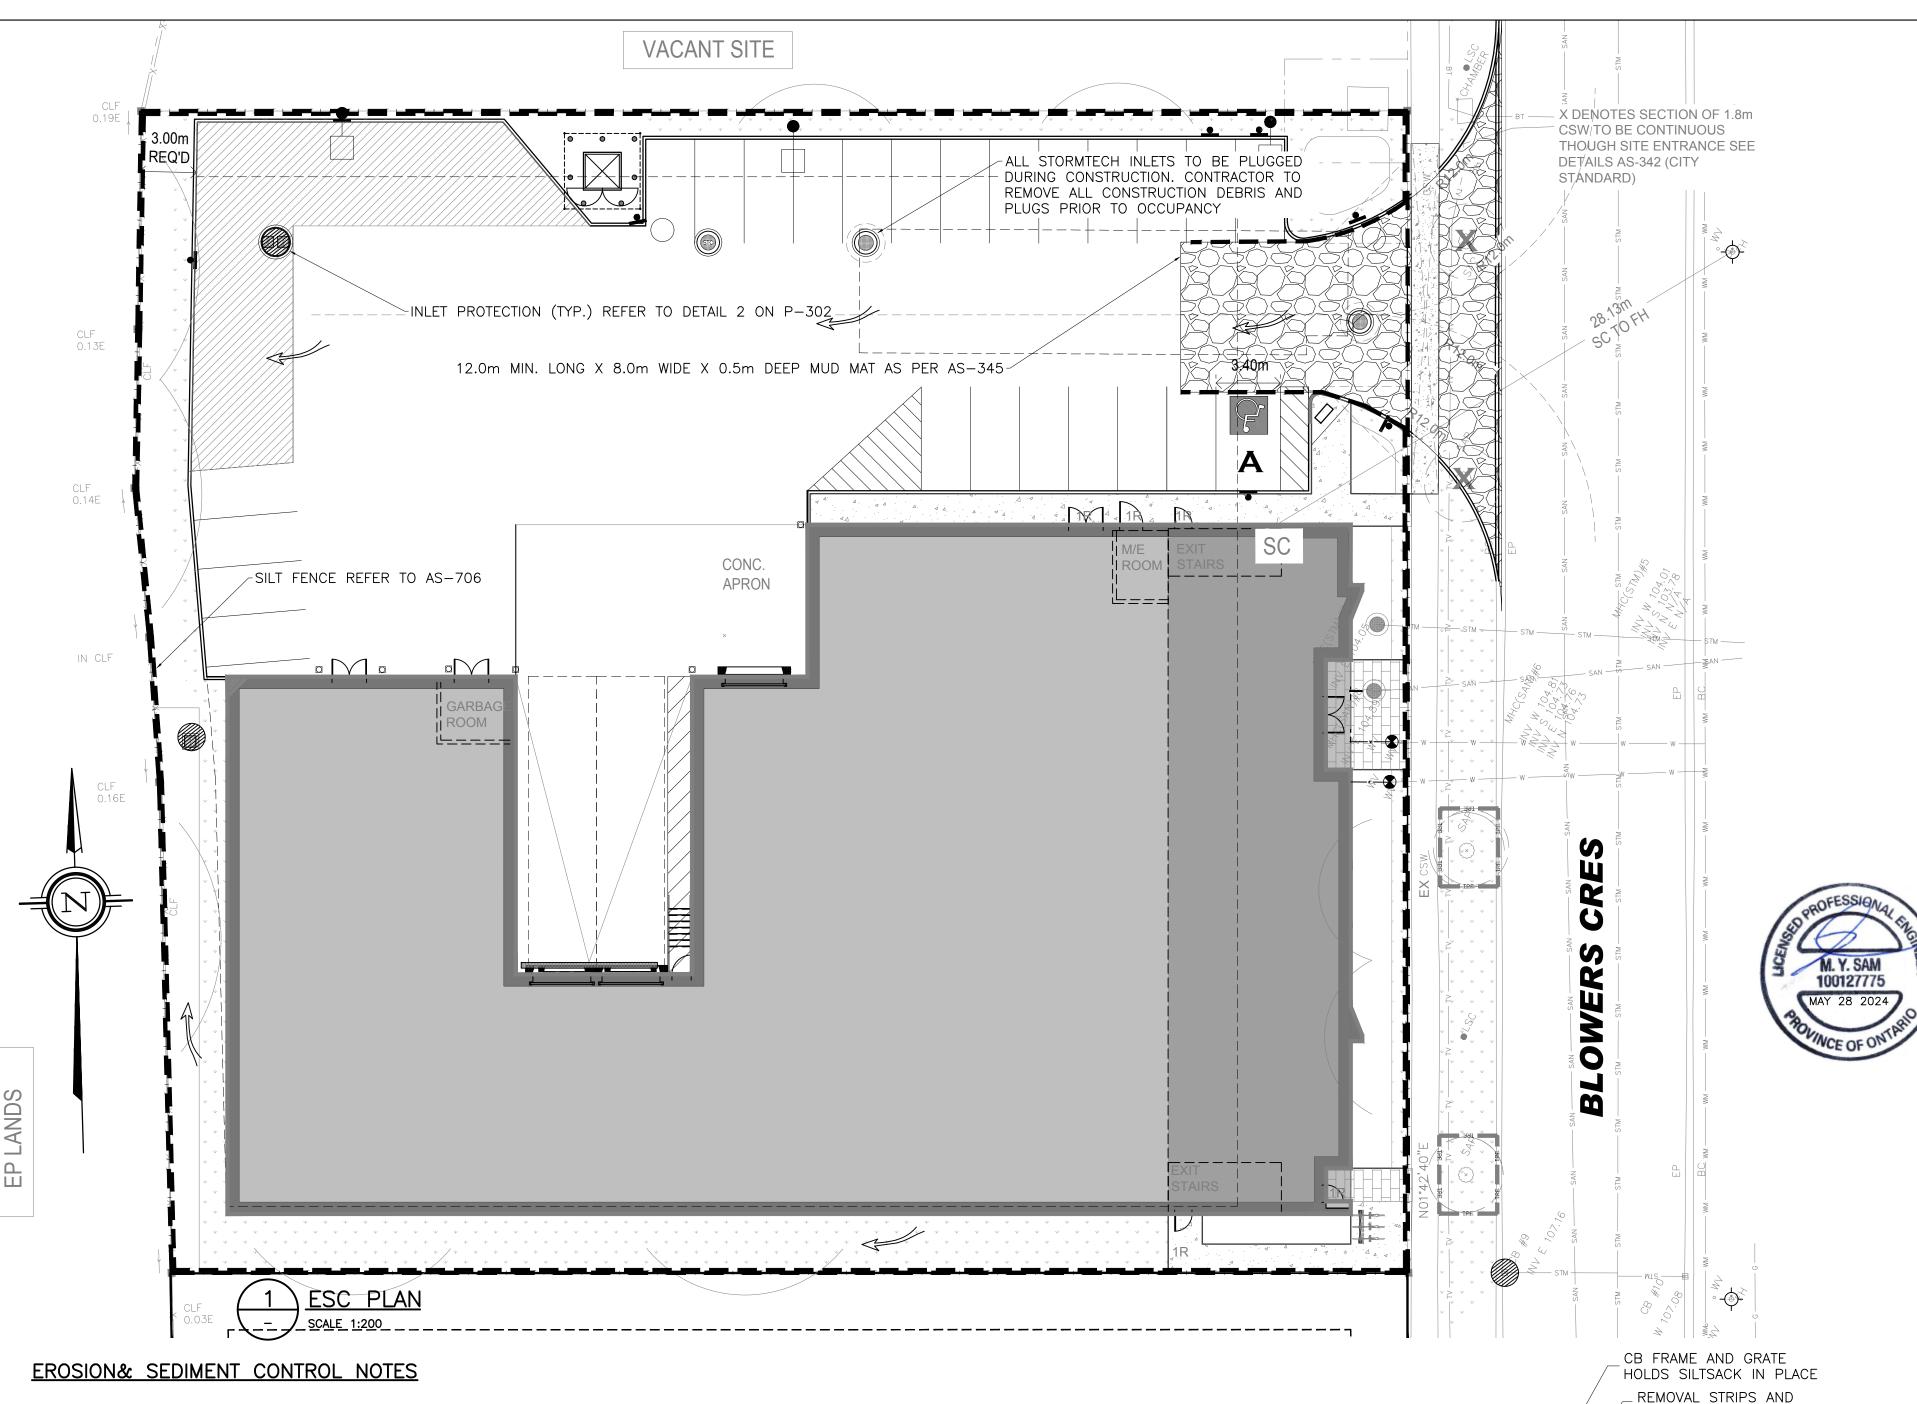

- 1. PRIOR TO COMMENCEMENT OF ANY ON-SITE WORK/TOPSOIL STRIPPING, EROSION AND SEDIMENT CONTROL (ESC) MEASURES, AS PER APPROVED EROSION & SEDIMENT CONTROL PLAN, MUST BE INSTALLED TO PREVENT SURFACÉ RUNOFF FROM LEAVING THE SITE "UNTREATED". ALL ÈSC MEASURES ARE TO BE MAINTAINED UNTIL THE SITE HAS BEEN
- 2. THE CONTRACTOR SHALL BE RESPONSIBLE FOR THE PROPER INSTALLATION, MAINTENANCE AND REMOVAL OF ALL TEMPORARY EROSION AND SEDIMENT CONTROL MEASURES DURING
- CONSTRUCTION, AS DIRECTED BY THE ENGINEER OR THE TOWN OF AJAX. 3. SEDIMENT CONTROL FENCE TO USE GEOTEXTILE WITH WEAVE DENSITY OF 270R TERRAFIX OR EQUIVALENT
- 4. ALL EXPOSED SOILS SHALL BE IMMEDIATELY STABILIZED AS DIRECTED BY THE ENGINEER OR TOWN OF AJAX.
- 5. CHECK DAMS ARE TO BE USED IN ANY TEMPORARY DRAINAGE SWALES REQUIRED DURING THE CONSTRUCTION PERIOD.
- 6. ADDITIONAL EROSION AND SEDIMENT CONTROL MEASURES MAY BE REQUIRED AND SHALL BE DETERMINED BY THE ENGINEER OR THE TOWN OF AJAX.
- 7. ALL SWALES ARE TO BE STABILIZED PRIOR TO USE.
- 8. INSPECTION OF THE PROPOSED EROSION AND SEDIMENT CONTROL MEASURES WILL OCCUR ON A WEEKLY BASIS, AFTER RAINFALL EVENTS EXCEEDING 10mm OR AFTER RAPID SNOW MELT EVENTS AND DAILY DURING EXTENDED RAIN OR SNOW MELT PERIODS. THE SILT CONTROL FENCE MUST BE INSPECTED FOR RIPS OR TEARS, BROKEN STAKES, BLOW OUTS AND ACCUMULATION OF SEDIMENT. THE SILT CONTROL FENCE MUST BE FIXED AND/OR REPLACED IMMEDIATELY WHEN DAMAGED. ACCUMULATED SEDIMENT MUST BE REMOVED FROM THE SILT CONTROL FENCE WHEN ACCUMULATION REACHES 50% OF THE HEIGHT OF THE FENCE.
- 9. ROCK CHECK DAMS ARE TO BE CLEANED OF ALL ACCUMULATED SEDIMENT AS SOON AS SEDIMENT HAS ACCUMULATED TO A DEPTH GREATER THAN 50% OF ALL THE UPSTREAM CHECK DAMS.
- 10. CLEANING AND REPAIR OF MUD MATS AND ANY OTHER TEMPORARY SEDIMENT CONTROL MEASURES SHALL BE DONE AS NECESSARY THROUGH REGULAR INSPECTION OR AS DIRECTED BY THE ENGINEER OR TOWN OF AJAX. ALL DAMAGED ESC MEASURES SHALL BE REPAIRED AND/OR REPLACED WITHIN 48 HOURS OF THE INSPECTION. 11. MATERIALS TO REPAIR DAMAGED ESC MEASURES MUST BE KEPT ON-SITE AT ALL TIMES.
- 12. THE ESC STRATEGIES ON THESE PLANS ARE NOT STATIC AND MAY NEED TO BE UPGRADED/AMENDED AS SITE CONDITIONS CHANGE TO PREVENT SEDIMENT RELEASES. FAILED ESC MEASURES MUST BE REPAIRED IMMEDIATELY.
- 13. NO CONSTRUCTION ACTIVITY OR MACHINERY SHALL INTRUDE BEYOND THE SILT CONTROL FENCE OR LIMIT OF DEVELOPMENT. ALL CONSTRUCTION VEHICLES SHALL LEAVE THE SITE AT DESIGNATED LOCATIONS AS SHOWN ON THE PLANS. ALL MATERIALS AND EQUIPMENT SHALL BE STORED ON SITE IN A DESIGNATED AREA. NO MATERIALS OR EQUIPMENT SHALL BE STORED ON THE MUNICIPAL RIGHT OF WAY. NO CONSTRUCTION VEHICLES WILL PARK ON MUNICIPAL ROADS.
- 14. SERVICING OF CONSTRUCTION EQUIPMENT ON SITE IS PROHIBITED.
- 15. THE CONTRACTOR MUST CLEAN ADJACENT ROADS ON A REGULAR BASIS. THE ROAD SHALL BE, AT A MINIMUM SCRAPED DAILY AND FLUSHED (IF NECESSARY) ON FRIDAY EVENINGS OR SATURDAY MORNINGS.
- 16. DUST CONTROL TO BE REVIEWED DAILY. WATER TRUCK OR CALCIUM CHLORIDE IS TO BE PROVIDED ON-SITE AND HAUL ROADS/WORKING AREAS ARE TO BE TREATED AS REQUIRED TO ENSURE THAT DUST IS CONTROLLED ON-SITE.
- 17. AT THE END OF CONSTRUCTION PERIOD, ACCUMULATED SEDIMENT IS TO BE REMOVED OFF SITE PRIOR TO THE REMOVAL OF THE SILT FENCE.
- 18. ALL LITTER AND DEBRIS SHALL BE MONITORED AND DISPOSED OF DAILY OR AS NECESSARY THROUGH REGULAR INSPECTION.
- 19. ALL TOPSOIL STOCKPILES SHALL BE SURROUNDED WITH SEDIMENT CONTROL FENCE AND STABILIZED WITH SEED MIX AS PER THIS DRAWING.
- 20. DISTURBED AREAS ARE TO BE MINIMIZED TO THE EXTENT POSSIBLE AND STABILIZED AS THE WORK PROGRESSES. ANY AREA EXPOSED FOR MORE THAN 30 DAYS WILL BE
- 21. TEMPORARY "TRUCK ENTRANCE" SIGNS SHALL BE INSTALLED ON THE SHOULDER, 150m IN ADVANCE OF THE ACCESS. (NOTE: SEE DETAILS ON THE USE OF THESE SIGNS IN THE 7. THIS DRAWING SHALL BE READ IN CONJUNCTION WITH ONTARIO TRAFFIC MANUAL BOOK 7). THE APPLICANT WILL BE RESPONSIBLE FOR THE COST OF OBTAINING, ERECTING AND MAINTAINING THESE SIGNS.
- 22. TEMPORARY CONSTRUCTION ACCESS SHALL BE REMOVED FROM THE ROAD ALLOWANCE AND ALL DISTURBED AREAS SHALL BE RESTORED TO ORIGINAL OR BETTER CONDITIONS

SEDIMENT CONTROL CONSTRUCTION SCHEDULE


- 1. INSTALL PERIMETER SILT FENCE AND CONSTRUCTION VEHICLE ACCESS.
- 2. STRIP SITE OF TOPSOIL AND REMOVE OFF SITE OR STOCK PILE AND PROVIDE SILT FENCE AROUND BOTTOM OF PILE.
- 3. INSTALL MINOR STORM SEWER SYSTEM ALONG WITH OTHER SERVICES.
- 4. INSTALL CATCHBASIN FILTRATION ON ALL CATCHBASINS.
- 5. SEDIMENT CONTROL MEASURES ARE TO BE MAINTAINED UNTIL ALL AREAS OF THE SITE HAVE BEEN STABILIZED WITH SOD OR ASPHALT

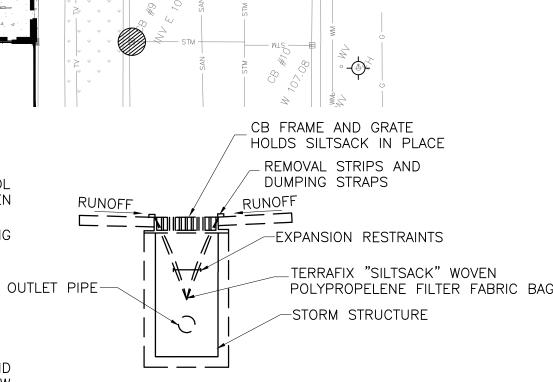

P-302/CONTROL FILTER FOR CATCHBASIN

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6. DEVELOPER IS RESPONSIBLE FOR ENSURING SIDEWALK IS SAFE, IN GOOD CONDITION, FREE OF DEBRIS AND

7. ANY DISTURBANCE/DAMAGE TO THE BOULEVARD IS TO BE RE-INSTATED TO THE THE SATISFACTION OF

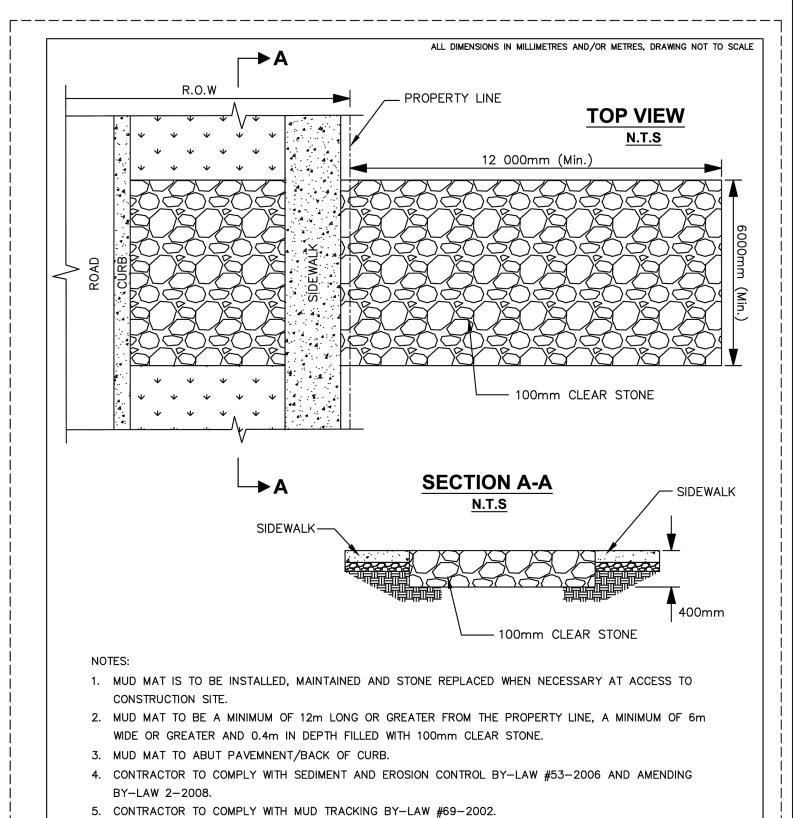MUD MAT DETAIL

Control measure support -

compacted

SECTION A-A

A All dimensions are in millimetres unless otherwise shown.

SILT FENCE BARRIER

dimensions are in millimetres unless otherwise snown.

ONTARIO PROVINCIAL STANDARD DRAWING Nov 2015 Rev 2

BARRIER - SILT FENCE

Miax

OPERATIONS SECTION

MUD AT ALL TIMES.

THE TOWN OF AJAX.

ENGINEERING SECTION



SCALE: NTS PLAN OF SURVEY OF BLOCK 3 | REGISTERED PLAN 40M-2486 TOWN OF AJAX

REGIONAL MUNICIPALITY OF DURHAM

<u>METRIC</u>

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BEARING NOTE

JOINT DETAIL

OPSD 219.130

REVISION No.

AS-706

SEPT. 2020

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VERTICAL DATUM: CANADIAN GEODETIC DATUM, 1928 (1978 SOUTHERN ONTARIO READJUSTMENT)

LEGEND

- DENOTES SURVEY MONUMENT FOUND
- " SURVEY MONUMENT PLANTED SIB " STANDARD IRON BAR
- SSIB " SHORT STANDARD IRON BAR
 - IRON BAR
- EXISTING ELEVATION EXISTING CATCHBASIN
- EXISTING MANHOLE
- EXISTING FIRE HYDRANT EXISTING WATER VALVE
- PROPERTY LINE
- NEW CATCHBASIN
- NEW STORMCEPTOR EFO4
- NEW MANHOLE
- SILT FENCE (AS-706) INLET PROTECTION

	No.	Date	DEVICIONS	Drawn	Checked
ı	NIO	Data	Description	Drawn	Classicad
	0	20 MAR '24	ISSUED FOR REVIEW	JM	JS
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	2	19 APR '24	REVISED AS PER SITEPLAN	JM	JS
	3	28 MAY '24	REVISED AS PER SITEPLAN	JM	JS

J + B ENGINEERING INC CALGARY 707-10TH AVE. SW 25 CENTURIAN DR.

Drawing No: P-302


MARKHAM, ON L3R 5N8 CALGARY AB T2R 0B3 416 229 2636 403 355 2295

AS - 345

FEBRUARY 2017

EROSION AND SEDIMENT CONTROL

5 BLOWERS CRES		AJAX, ON
e No: 230152	Date: 07 MAR '24	ACAD INFO
awn By: HR	Scale: 1:200	Dwg. File: 230152 P-302
necked By: JS	Sheet 1 of 1	Plotting Scale: 1=1
awing No: P-302		Drawing Size: D

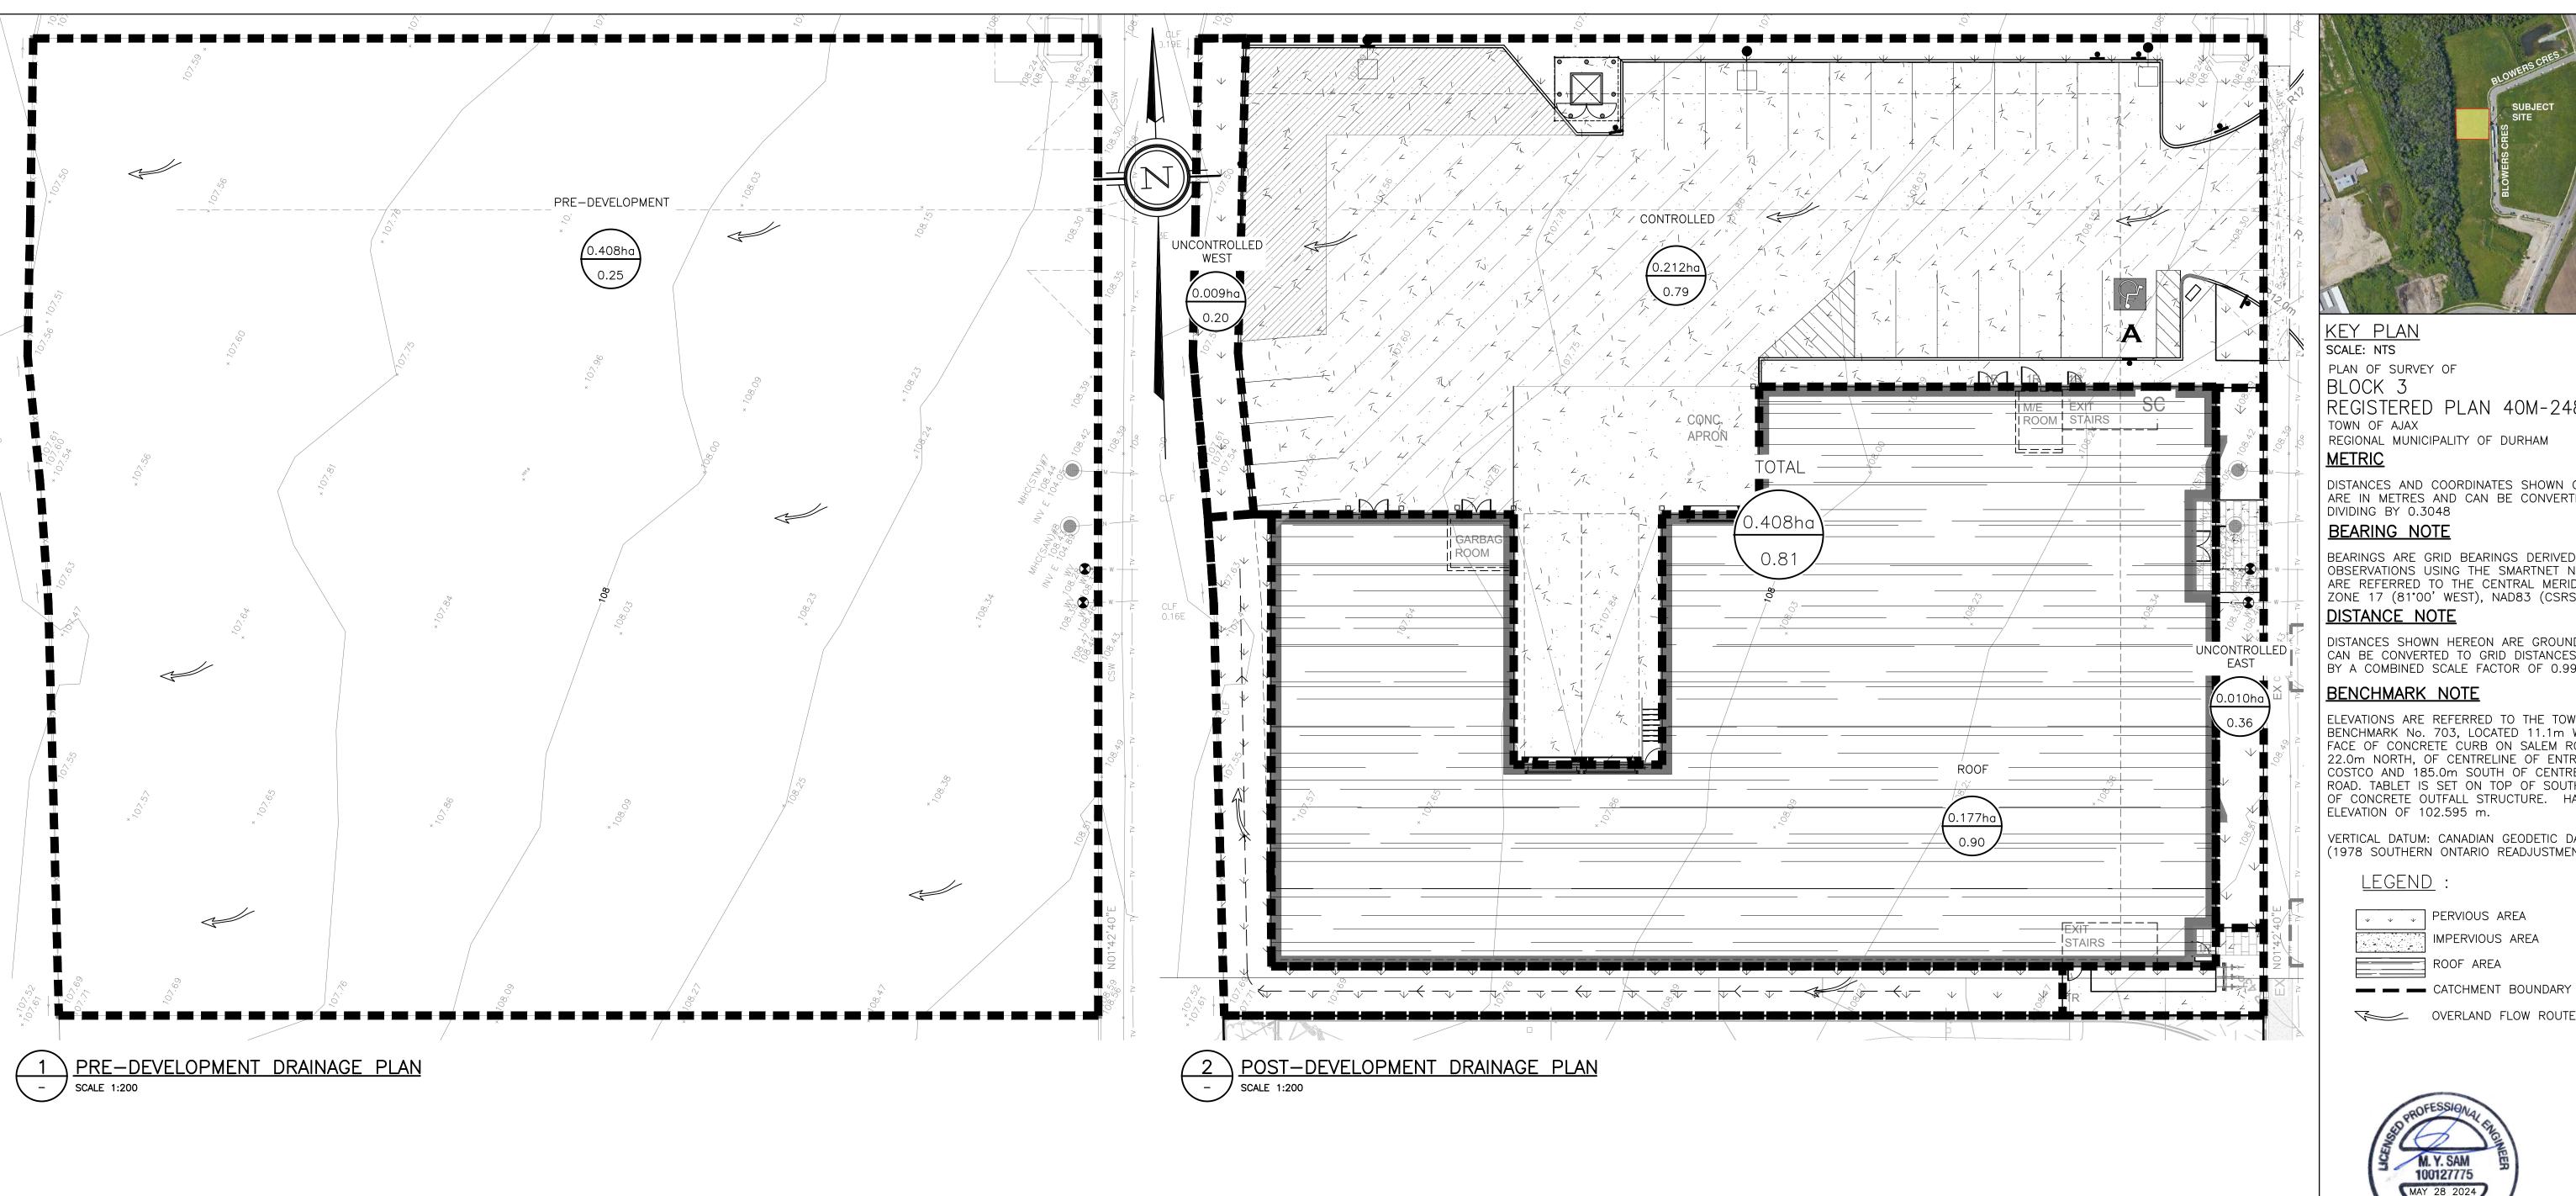



PLAN OF SURVEY OF

REGISTERED PLAN 40M-2486

REGIONAL MUNICIPALITY OF DURHAM

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DISTANCES SHOWN HEREON ARE GROUND DISTANCES AND CAN BE CONVERTED TO GRID DISTANCES BY MULTIPLYING BY A COMBINED SCALE FACTOR OF 0.999902.

BENCHMARK NOTE

ELEVATIONS ARE REFERRED TO THE TOWN OF AJAX BENCHMARK No. 703, LOCATED 11.1m WEST OF WEST FACE OF CONCRETE CURB ON SALEM ROAD NORTH, 22.0m NORTH, OF CENTRELINE OF ENTRANCE TO COSTCO AND 185.0m SOUTH OF CENTRELINE OF RINGER ROAD. TABLET IS SET ON TOP OF SOUTHEAST CORNER OF CONCRETE OUTFALL STRUCTURE. HAVING AN ELEVATION OF 102.595 m.

VERTICAL DATUM: CANADIAN GEODETIC DATUM, 1928 (1978 SOUTHERN ONTARIO READJUSTMENT)

<u>LEGEND</u>:



OVERLAND FLOW ROUTE

1	28 MAY '24	REVISED AS PER SITEPLAN	JM	JS
0	19 APR '24	REVISED AS PER SITEPLAN	JM	JS
No.	Date	Description	Drawn	Checked
		DEVICIONE	•	•



J + B ENGINEERING INC. TORONTO CALGARY
25 CENTURIAN DR. 707-10TH AVE. SW
SUITE 201 SUITE 150
MARKHAM, ON L3R 5N8 CALGARY AB T2R 0B3
416 229 2636 403 355 2295

Project:

PRE/POST DRAINAGE PLAN

45 BLOWERS CRES AJAX, ON File No: 230152 Date: 19 APR '24 ACAD INFO Dwg. File: 230152 P-303 Drawn By: **JM** Scale: **1:200** Sheet 1 of 1 Plotting Scale: 1=1 Checked By: JS Drawing No: P-303Drawing Size: **D**