# AFFORDABLE HOUSING BUILDING- COUNTY OF HASTINGS

	ELECTRICAL LEGEND						
SYMBOL	DESCRIPTION	SYMBOL	DESCRIPTION	SYMBOL	DESCRIPTION	SYMBOL	DESCRIPTION
	LIGHTING	GFI	GROUND FAULT INTERRUPTER		LIFE SAFETY SYSTEMS		U/G DUCT BANK
	LED LUMINAIRES. SIZE AS SHOWN ON PLANS.	M	UTILITY METERING.	EA	FIRE ALARM HORN/STROBE COMBINATION. CEILING/WALL MOUNTED		ELECTRIC HEATER
		│	PANELBOARD	⊡◀	FIRE ALARM MINI HORN. CEILING/WALL MOUNTED	¢	CONTROLLER. SUPPLIED BY OTHERS, INSTALLED BY DIVISION 26.
₽	GROUND MOUNTED HID LUMINAIRE		15A-125V 1PH-3W GROUNDED DUPLEX RECEPTACLE, WALL MOUNTED.	匠	FIRE ALARM HORN. CEILING/WALL MOUNTED	HD	ELECTRIC HAND DRYER, SUPPLIED BY OTHERS, INSTALLED AND WIRED
•0	POLE MOUNTED LUMINAIRE.	Φ	15A USB OUTLET: LEGRAND CAT# TM826USBWCC6	<u>I</u>	FIRE ALARM STROBE. CEILING/WALL MOUNTED	AV	BY DIVISION 26.  VGA, HDMI
Ω,Ω	INCANDESCENT OR LED LUMINAIRE — WALL MOUNTED	₩	15A-125V 1PH-3W GROUNDED QUAD RECEPTACLE IN COMMON BOX, WALL MOUNTED.	Ē	FIRE ALARM MANUAL PULL STATION.		
0,0	INCANDESCENT OR LED LUMINAIRE — CEILING MOUNTED OR FLOOR MOUNTED	Φ	15A-150V-3W GROUNDED DUPLEX RECEPTACLE. MOUNTED ABOVE COUNTER FOR GENERAL POWER CONNECTION.	<b>4</b> , <b>4</b>	F.A. HEAT DETECTOR (RATE OF RISE) — CEILING OR WALL MOUNTED		MISCELLANEOUS SYSTEMS
• • • •	BOLLARDS	<del> </del>	20A-125V 1PH-3W GROUNDED QUAD RECEPTACLE IN COMMON BOX, WALL MOUNTED.	⊙, <u>⊊</u>			(DIV.26 TO PROVIDE EMPTY CONDUITS, PULL WIRES AND OUTLET BACK BOXES ONLY.CABLING AND DEVICES BY SECURITY CONTRACTOR)
~~~~~~~~~~~~~~~~~~~~~~~~~~~~~~~~~~~~~~	LUMINAIRES ON EMERGENCY POWER.	Ф	15A-125V 2P-3W GROUNDED DUPLEX RECEPTACLE, WALL MOUNTED SPLIT WIRED.	<b>⊙</b> , ⊈ <b>⊙</b> , <b>Q</b>	120V SMOKE ALARM — CEILING OR WALL MOUNTED	CR MD	CARD READER & MOTION SENSOR DOOR RELEASE
'∅,೪		<b>●</b> P	15A-125V 2P-3W GROUNDED DUPLEX RECEPTACLE, COUNTER HEIGHT SPLIT WIRED.	_	F.A. SMOKE DETECTOR — CEILING OR WALL MOUNTED	KP	SECURITY SYSTEM KEY PAD
	COVE LIGHTING FIXTURE. 2', 3', 4' LENGTH TO SUIT SPACE.	0	15A-125V 1PH-3W DEDICATED GROUNDED DUPLEX RECEPTACLE, WALL MOUNTED.	<del></del>	F.A. DUCT SMOKE DETECTOR C/W REMOTE INDICATOR LIGHT	PTZ (	CCTV SURVEILLANCE CAMERA — PAN, TILT, ZOOM.  CCTV SURVEILLANCE CAMERA — FIXED
НА	LUMINAIRE DESIGNATOR — LETTER INSIDE DENOTES LUMINAIRE TYPE. REFER TO LUMINAIRE SCHEDULE IN SPECIFICATIONS.	φ	SINGLE RECEPTACLE, WALL MOUNTED.	FACP	MAIN FIRE ALARM CONTROL PANEL	CAMA	SECURITY CAMERA C/W PULL BOX IN CEILING AND 3/4"C BACK TO
<del></del>	TERRANCE LED STRIP LIGHTING	<u> </u>	15A-125V 1PH-3W GROUNDED DUPLEX RECEPTACLE MOUNTED IN FLUSH FLOOR BOX.	FAGP	FIRE ALARM DATA GATHERING PANEL	DH	COMMUNICATION ROOM.  DOOR HOLDER
		#	15A-125V 1PH-3W GROUNDED QUAD RECEPTACLE MOUNTED IN FLUSH FLOOR BOX.	ANN	FIRE ALARM ANNUNCIATOR PANEL C/W GRAPHIC MAP	ОН	HANDICAPPED DOOR OPENER
		Φ	15A-125V 1PH-3W GROUNDED DUPLEX RECEPTACLE CEILING MOUNTED	B	EMERGENCY LIGHTING BATTERY UNIT C/W UNIT MOUNTED LED HEADS.	Н	HANDICAPPED OPERATOR PUSHBUTTON
	SWITCHING	Φ	20A-125V 1PH-3W GROUNDED SINGLE RECEPTACLE	<b>₩₩₩</b> ₩	CEILING OR WALL MOUNTED GREEN RUNNING MAN	DC	SECURITY DOOR CONTACT LOCATION
\$. <b>\$.</b> \$	SINGLE POLE, SINGLE THROW TOGGLE SWITCH ('3' DENOTES		20A-125V 1PH-3W GROUNDED DUPLEX RECEPTACLE	<b>≅</b> . <b>₹</b> .≅	PICTOGRAM EXIT SIGNS, ARROW(S) INDICATE DIRECTION	ES	SECURITY ELECTRIC STRIKE LOCATION
<b>ም, ሞ, ሞ</b>	3-WAY, '4' DENOTES 4-WAY, 'PL' DENOTES PILOT LIGHT, 'LV' DENOTES LOW VOLTAGE. 'K' DENOTES KEY OPERATED).		15A-250V 1PH-3W GROUNDED SINGLE RECEPTACLE	SM	COMBINATION SMOKE ALARM. CARBON MONOXIDE DETECTOR & STROBE. 120V.	ML	EMERGENCY CALL STATION  SECURITY MAGNETIC LOCK LOCATION
ф	DIMMER SWITCH. DIMMER LIGHT SWITCH (600WATT UNLESS OTHER	₩	20A-250V 1PH-3W GROUNDED SINGLE RECEPTACLE			EN	ENTERPHONE
	WISE NOTED:10=1000W, 15=1500W)	<b>1</b>	WALL MOUNTED OR FLUSH IN FLOOR BOX 15A-125V 1PH-3W GROUNDED DUPLEX RECEPTACLE	M	COMBINATION SMOKE ALARM & STROBE. 120V	DO	DOOR OPENER
◎ , ◎ , ◎ →	OCCUPANCY SENSOR, WALL AND CEILING MOUNTED	•	50A-250V 1PH-3W GROUNDED SINGLE RECEPTACLE	SM	SMOKE ALARM DETECTOR. 120V	SEN	SMART ONE ENTERPHONE
DOO	DIMMER/OCCUPANCY SENSOR COMBINATION	•	15A-125/250V 3PH-4W GROUNDED SINGLE RECEPTACLE	<b>©</b>	CARBON MONOXIDE DETECTOR. 120V	SWP	SMART ONE WALL PAD
PC	PHOTOCELL	<b>I</b> ⊕	20A-125/250V 3PH-4W GROUNDED SINGLE RECEPTACLE	Ø	WALL MOUNTED OUTDOOR BEACON/STROBE LIGHT		MIGGELL ANEOLIG LEGEND
TS	TIME SWITCH	•	30A-125/250V 3PH-4W GROUNDED SINGLE RECEPTACLE	<b>-</b>			MISCELLANEOUS LEGEND
PB	PUSHBUTTON	•	50A-125/250V 3PH-4W GROUNDED SINGLE RECEPTACLE			Č	DENOTES REFER TO NOTE
		<b>1 0</b>	15A-120/208V 3PH-5W GROUNDED SINGLE RECEPTACLE		COMMUNICATION SYSTEMS	1 E-	DENOTES REFER TO DETAIL AND DRAWING NUMBER.
	POWER DEVICES	<b>1</b> ⊕	20A-120/208V 3PH-5W GROUNDED SINGLE RECEPTACLE		(DIV.26 TO PROVIDE EMPTY CONDUITS, PULL WIRES AND OUTLET BACK BOXES ONLY.CABLING AND DEVICES BY TELECOMMUNICATION CONTRACTOR)	WT	DENOTES WATERTIGHT (CSA ENCLOSURE 4)
——————————————————————————————————————	CIRCUIT BREAKER	 J	JUNCTION BOX	▼	TELEPHONE WALL OUTLET C/W 3/4"C HOME RUN TO NEAREST TELECOM	WP	DENOTES WEATHER PROOF (NEMA TYPE 3R)
	CIRCUIT BREAKER C/W TRIP SETTING. AMP RATING AND TRIP AS NOTED ON DWG.	C	CONTACTOR.		CONTROL BOX/ROOM  DATA OUTLET — WALL, ROOF OR CEILING MOUNTED C/W 3/4"C HOME RUN TO	GFI WG	DENOTES GROUND FAULT INTERRUPTER.  DENOTES WIRE GUARD
	FUSED DISCONNECT SWITCH	R	RELAY	$\triangle \wedge \square$	NEAREST TELEPHONE BOX/ROOM. MAXIMUM 4 DROPS PER WALLBOX — IF MORE THAN CONTRACTOR TO PROVIDE MULTI—GANG BOX AND FACEPLATE TO	JB	JUNCTION BOX
<b>→~</b> , ₫	UNFUSED DISCONNECT SWITCH		THERMOSTAT	<b>5</b>	ACCOMMODATE AS REQUIRED.	AFF	ABOVE FINISHED FLOOR
₩, ⊠	FEEDER	0	POWER DIRECT CONNECTION TO EQUIPMENT AS INDICATED.	☑	VOIP OUTLET — FLOOR MOUNTED C/W 3/4"C HOME RUN TO NEAREST TELECOM CONTROL BOX/ROOM	TP ST	TAMPER PROOF STOVE
	POWER TRANSFORMER	<b> </b>	MOTOR CONNECTION TO EQUIPMENT AS INDICATED.	$\Delta$	COMBINATION DATA AND TELEPHONE DROPS C/W 3/4"C HOME RUN TO NEAREST TELECOM CONTROL BOX/ROOM	MD	MOTORIZED DAMPER
DMS	DIGITAL METERING SYSTEM	Ą	MOTOR CONNECTION TO EQUIPMENT AS INDICATED.	TV, TV	CABLE TV OUTLET - CEILING OR WALL MOUNTED C/W 3/4" HOME RUN	FR DW	FRIDGE DISHWASHER
		⊠n	MOTOR STARTER. SUPPLIED AND INSTALLED BY DIV. 15. AND WIRED BY DIV. 16.	, <u></u>	TO NEAREST TELECOM ROOM		

GENERAL NOTES

## THIS IS A MASTER LEGEND. NOT ALL SYMBOLS SHOWN MAY BE USED ON THIS PROJECT.

- 2. THESE DRAWINGS ARE DIAGRAMMATIC ONLY. BEFORE ANY ELECTRICAL EQUIPMENT IS ROUGHED IN. ITS EXACT LOCATION MUST BE DETERMINED FROM THE ARCHITECTURAL PLANS AND INTERIOR DESIGNER DRAWINGS DETAILS AND ELEVATIONS OR DETAILS ON THE ELECTRICAL DRAWINGS. WHERE THIS DETAILED INFORMATION IS NOT SHOWN ON THE DRAWINGS, VERIFY THE EXACT LOCATION ON SITE.
- 3. ALL MEASUREMENTS SHOWN ON THE DRAWINGS ARE IN METRIC MILLIMETRE(S) OTHERWISE INDICATED.
- 4. DETAILS ARE INTENDED TO BE FOR GENERAL ARRANGEMENTS ONLY. THEY DO NOT SHOW ALL NECESSARY COMPONENTS, BUT ARE MERELY A GUIDE AS TO THE ORIENTATION OF EQUIPMENT WHICH IS REQUIRED.
- 5. PROVIDE ALL GROUNDING IN ACCORDANCE WITH THE RULES AND REGULATIONS OF AUTHORITIES HAVING JURISDICTION.
- 6. INDICATION ON SWITCH SAME AS FOR OUTLET(S) IT CONTROLS.
- 7. ARROWHEAD ON CONDUIT INDICATES HOMERUN TO PANEL.
- 8. ON ALL CONDUIT RUNS OF 33M OR MORE, INSTALL PULLBOXES WHERE REQUIRED TO SUIT SITE CONDITIONS.
- 9. WHERE CONDUITS CROSS EXPANSION JOINTS OF BUILDING AS SHOWN ON ARCHITECTURAL DRAWINGS, PROVIDE APPROVED TYPE EXPANSION JOINTS COMPLETE WITH GROUNDING STRAPS AND CLAMPS.
- 10. CO-ORDINATE ALL SWITCH AND RECEPTACLE LOCATIONS WITH ARCHITECTURAL AND MECHANICAL DRAWINGS PRIOR TO INSTALLATION.
- 11. INSTALL ALL LIGHTING LUMINAIRES CONDUIT, HEAT DETECTORS ETC., IN MECHANICAL ROOMS, BOILER ROOMS, FAN ROOMS AND MACHINE ROOM AFTER MECHANICAL EQUIPMENT, DUCTS, PIPES, ETC., ARE IN PLACE. LOCATE LUMINAIRE WITH CHAIN HANGERS TO BEST POSSIBLE ADVANTAGE.
- 12. VERIFY EXACT LOCATION OF ALL FLOOR OUTLETS BEFORE INSTALLATION OF CONDUIT
- 13. WHERE SITE CONDITIONS INDICATE CONFLICT BETWEEN THE INSTALLATION OF ELECTRICAL EQUIPMENT AND/OR MECHANICAL EQUIPMENT OR STRUC—TURAL MEMBERS, PREPARE COMPLETE INTERFERENCE DRAWINGS FOR DISCUSSION WITH RESPECTIVE CONSULTANTS.
- 14. REFER TO ARCHITECTURAL REFLECTED CEILING PLANS AND ELEVATIONS FOR EXACT LOCATIONS OF LUMINAIRES, SPEAKER, DETECTORS AND CEILING MOUNTED RECEPTACLES.
- 15. CO-ORDINATE EXACT LOCATION AND RATING OF ALL MOTORS AND STARTERS WITH MECHANICAL TRADE CONTRACTOR PRIOR INSTALLATION OF CONDUIT AND WIRING.
- 16. DIV.26 TO COORDINATE WITH DIV.15 ON SITE FOR THE EXACT LOCATIONS AND INSTALLATION DETAILS FOR ALL DUCT SMOKE DETECTORS PRIOR TO INSTALLATION.
- 17. RECEPTACLES SHALL BE MOUNTED DIRECTLY BELOW PULLSTATION AT EXITS (WHERE SHOWN TOGETHER) AND DIRECTLY BELOW SWITCHES AT ROOM ENTRANCES.
- 18. ALL ELECTRICAL OPENINGS SHOWN ARE MINIMUM SIZE ONLY. ELECTRICAL CONTRACTOR TO DETERMINE, VERIFY AND SUBMIT SCALED ROUGH—IN DRAWINGS FOR ALL ELECTRICAL OPENINGS TO CONSULTANTS FOR REVIEW PRIOR TO CONSTRUCTION.
- 19. AT ALL FLOOR/WALL OPENINGS AND SLEEVES FOR ELECTRICAL USE, DIV. 16 SHALL PROVIDE PROPER RE-ENTRY TYPE FIRE SEALANT/BARRIER MATERIAL AS DEFINED AND SPECIFIED.

# 20. CONDUIT ROUTES ARE DIAGRAMMATIC ONLY. AT EXPOSED PRECAST SLAB RUN CONCEALED IN THE WALLS. DIV. 16 TO REFER TO MECHANICAL DRAWINGS OR CONTRACTOR FOR EXACT LOCATION OF ALL MECHANICAL EQUIPMENT & DEVICES PRIOR TO ELECTRICAL ROUGHING—IN.

- 21. UNLESS NOTED OTHERWISE, FAN CONTROLS ARE SUPPLIED BY DIVISION 25 AND INSTALLED BY DIVISION 26.
  DIVISION 26 TO SUPPLY AND INSTALL ALL 120V CONTROLLERS UNLESS OTHERWISE NOTED. DIVISION 25 IS
- RESPONSIBLE FOR STARTUP AND VERIFICATION OF ALL FAN AND CONTROLS.

  22. MOUNTING HEIGHTS OF RECEPTACLES, SWITCHES, AND THERMOSTATS ARE TO THE CENTERLINE OF DEVICES.

  23. ELECTRICAL CONTRACTOR TO COORDINATE WITH MECHANICAL CONTRACTOR REGARDING THE LOCATIONS OF ZONE

DAMPERS AND TO PROVIDE POWER FROM THE NEAREST CIRCUIT / JUNCTION BOX.

- 24. ALL MOTOR STARTERS ARE BY DIV. 15. DIV. 16 TO COORDINATE ON SITE FOR EXACT LOCATION OF ALL MOTOR STARTER LOCATION AND RUN POWER WIRING FROM ELECTRICAL PANEL TO STARTER/MAIN DISCONNECT SWITCH & WIRE BACK TO MOTOR (EXHAUST FANS) LOCATION AS REQUIRED TO SUIT. PUMP STARTERS ARE BY DIV. 15. REFER TO DETAILS FOR POWER WIRING REQUIREMENTS TO SUIT.
- 25. DIV. 16 TO ENSURE ALL BRANCH FEEDER TO HAVE NOT MORE THAN 3% VOLTAGE DROP. DO NOT LOOP WIRING AND PROVIDE APPROPRIATE NUMBER OF BRANCH FEEDERS AS REQUIRED TO MEET CODE REQUIREMENT. DIV. 16 TO PROVIDE RAMP SNOW MELTING & C/W REQUIRED CABLE, SUB 14, SENSOR, CONTROLLER, PANEL, CONTACTOR, THERMOSTAT GFI SYSTEM, STRAP, POWER CONNECTION, END SEAL, ETC FOR A COMPLETE INSTALLATION & OPERATION TO SUIT. RAYCHEM, TYCO CONTROLS. DIV. 15 TO SUPPLY AND INSTALL PIPE TRACING SYSTEM (XL TRACE TYPE) AND INSTALLATION C/W ALL REQUIRED APPURTENANCES. DIV. 16 TO PROVIDE PROPER ELECTRICAL
- 26. DIV. 16 TO REFER TO ELECTRICAL RISERS & DETAILS DRAWINGS OF ELECTRICAL/MECHANICAL DEVICES INFORMATION FOR INSTALLATION INTENT & PURPOSES.
- 27. DIV. 16 TO PROVIDE COMPLETE SYSTEM C/W WIRING, CABLING AND ALL ACCESSORIES FOR A COMPLETE INSTALLATION AND OPERATION FOR RAMP SNOW MELTING.
- 28. DIV. 16 TO PROVIDE REQUIRED JUNCTION BOXES, CONDUIT, POWER WIRING & CONTROL WIRING C/W PUSHBUTTON FOR HANDICAP AND OVERHEAD DOOR OPERATOR. DIV. 16 SHALL PIPE TRACE THE MECHANICAL PIPES PASSING THROUGHOUT THE UNCONDITIONED SPACE. COORDINATE WITH MECHANICAL DRAWINGS/CONTRACTOR ON SITE FOR EXACT STARTING AND TERMINATION POINTS.
- 29. DIV. 16 TO PROVIDE NECESSARY EMERGENCY LTG. RELAY CONTACTOR /CONTROL UNIT IN ALL EMERGENCY LTG. CIRCUITS IN ORDER TO BYPASS SENSOR SWITCH IN AN EMERGENCY SITUATION. CONNECT RELAY CONTACTOR TO NEAREST RECEPTACLE 120V NORMAL CIRCUIT OR NORMAL LIGHTING CIRCUIT AND OR FIRE ALARM CONTROL PANEL EMERGENCY RELAY CONTACTOR SHALL BE PROVIDED AS PER CODE REQUIREMENTS.
- 30. DIV. 16 TO PROVIDE ELECTRICAL CONNECTION FROM ELECTRICAL PANEL/CONTROL PANEL TO VARIABLE FREQUENCY DRIVE (VFD) LOCATION. EXACT MOUNTING LOCATION TO BE COORDINATED ON SITE WITH MECHANICAL CONTRACTOR.
- 31. DIV. 16 TO PROVIDE CONTROL WIRING C/W PROPER CONDUIT, WIRING, PUSHBUTTONS, JUNCTION BOXES FROM DOOR OPERATOR TO PUSHBUTTON LOCATION OF ALL EXIT DOOR SYSTEM. REFER TO DRAWING FLOOR PLAN FOR EXACT LOCATION AND QUANTITY.
- 32. DIV. 16 TO COORDINATE WITH MECHANICAL DRAWINGS FOR EXACT LOCATION OF ALL MECHANICAL EQUIPMENT AND PROVIDE NECESSARY ELECTRICAL CONNECTION REQUIREMENT FOR A COMPLETE OPERATION/INSTALLATION AS PER MECHANICAL SCHEDULE.
- 33. DIV. 16 TO COORDINATE WITH ALL ELECTRICAL EQUIPMENT SUPPLIER FOR POWER, PLUG, CONNECTION, BREAKER AND CONTROL WIRING REQUIREMENT AND PROVIDE AS REQUIRED FOR A COMPLETE OPERATION AND INSTALLATION.
- 34. DIV. 16 TO PROVIDE SHUNT RELAY FOR ALL EMERGENCY LIGHTING FIXTURES THAT ARE CONTROLLED BY A SWITCH/SENSOR AND SHALL BE AN APPROVED TYPE, ULC 120/347V, 1P, 15A.

DRAWINGS ARE NOT TO BE SCALED FOR DIMENSIONS.

SITE CONDITIONS. REPORT ANY DISCREPANCIES TO THE CONSULTANT BEFORE PROCEEDING WITH THE WORK.



A - Drawing/detail number

B - Sheet number where called

C - Sheet number where drawn

O ISSUES/REVISIONS A					
No.	Date	Date Description By			
1	2024/04/12	ISSUED FOR PERMIT	BV		
2	2024/07/30	ISSUED FOR TENDER	BV		

#### PRIOR TO PROJECT CONSTRUCTION COMPLETION!!!!

GENERAL CONTRACTOR - MANDATORY DELIVERABLES (WHERE APPLICABLE):

THORITY HAVING JURISDICTION FOR THIS BUILDIN

-ALL OPERATION AND MAINTENANCE MANUALS.
-ALL PRODUCT DATA THAT PERTAINS TO ALL FIRESTOPPING MATERIALS


-VERIFICATION LETTER BY A CERTIFIED AND LICENSED SPRINKLER AND LIFE SAFETY SYSTEMSCONTRACTOR. LETTER TO VERIFY INSTALLATION AND/OR MODIFICATIONS AND TESTING PERFORMED AND COMPLETED IN ACCORDANCE WITH NFPA 13


-ALL ESA REPORTS, FINAL SIGN OFF AND PERMITS
-VERIFICATION LETTER BY A CERTIFIED AND LICENSED EMERGENCY

-CERTIFICATES OF FIRE ALARM VERIFICATION
-HYDRO INSPECTION CERTIFICATES
-EMERGENCY LIGHTING TEST REPORT.
-TESTING, AIR BALANCING, ADJUSTING REPORTS FOR ALL HVAC SYSTEMS
-ALL STRUCTURAL STEEL SHOP DRAWINGS AND ENGINEERING REVIEWS
-ALL SITE VISIT REPORTS PROVIDED BY PROFESSIONAL DISCIPLINES.
-OCCUPANCY AND COMPLIANCE LETTERS FROM ALL PROFESSIONAL
DISCIPLINES.

LIGHTING ANF LIFE SAFETY SYSTEMS CONTRACTOR.



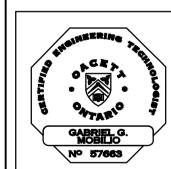

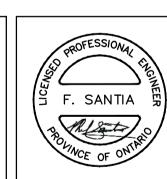

Project Title

ELECTRICAL DRAWING LIST

DWG No. | DESCRIPTION

DWG No.

E-002

E-102

E-300

E-500

E-600

E-900B

E-900C

E-902

E-903

DESCRIPTION

ELECTRICAL SITE PLAN

ELECTRICAL SPECIFICATIONS

ELECTRICAL SITE PLAN DETAILS

ELECTRICAL SITE PLAN LIGHTING DETAILS

ELECTRICAL GROUND FLOOR LIGHTING PLAN

ELECTRICAL SECOND FLOOR LIGHTING PLAN

ELECTRICAL THIRD FLOOR LIGHTING PLAN

ELECTRICAL FIRE DETAILS AND SCHEDULE

SECURITY AND COMMUNICATION DETAILS

ELECTRICAL ROOF FLOOR PLAN

ELECTRICAL PANEL SCHEDULES

ELECTRICAL PANEL SCHEDULES

ELECTRICAL PANEL SCHEDULES

ELECTRICAL DETAILS AND SCHEDULE

SINGLE LINE DIAGRAM

SECURITY DETAILS

ELECTRICAL DETAILS

ELECTRICAL DETAILS

ELECTRICAL LEGEND, GENERAL NOTES & DRAWING LIST

ELECTRICAL GROUND FLOOR POWER & SYSTEMS PLAN

ELECTRICAL SECOND FLOOR POWER & SYSTEMS PLAN

ELECTRICAL THIRD FLOOR POWER & SYSTEMS PLAN

32 UNIT AFFORDABLE HOUSING APARTMENT BUILDING 20 SOUTH STREET, TRENTON, ON

City of Quinte West

ELECTRICAL LEGEND, DRAWING LIST AND GENERAL NOTES

Drawn DD/MU	Checked <b>BV</b>		
Date June 2023	Scale N.T.S		
Project Number	Sheet Number		
07 010			

23-019

E-001

CODES & STANDARDS

1.1 COMPLETE THE INSTALLATION OF THE WORK IN ACCORDANCE WITH THE LATEST EDITIONS OF THE ONTARIO BUILDING CODE, ONTARIO ELECTRICAL SAFETY CODE, C.S.A. STANDARDS, U.L.C., N.F.P.A., O.H.S.A. AND OTHER CODES, AS REQUIRED. COMPLY WITH ELECTRICAL AND BUILDING CODE BULLETINS IN FORCE AT TIME OF BID SUBMISSION. WHILE NOT IDENTIFIED AND SPECIFIED BY NUMBER IN THIS DIVISION, THEY ARE TO BE CONSIDERED AS FORMING PART OF RELATED STANDARDS. ALSO, ALL ELECTRICAL WORK SHALL COMPLY WITH LANDLORD'S REQUIREMENTS AND BASE BUILDING STANDARDS. 2. <u>DEFINITIONS</u>

2.1 WHEREVER THE WORDS "PROVIDE" OR "SUPPLY AND INSTALL", ARE USED, IT SHALL BE UNDERSTOOD TO MEAN "PROVIDE AND INSTALL, INCLUSIVE OF ALL LABOUR, MATERIALS, INSTALLATION, TESTING, AND CONNECTIONS" FOR THE ITEM TO WHICH IT REFERENCES. 2.2 WHEREVER THE WORDS "EQUAL", "APPROVED", OR " APPROVED EQUAL" ARE USED, IT SHALL BE UNDERSTOOD TO MEAN "EQUAL", "APPROVED", OR "APPROVED EQUAL" IN THE OPINION OF THE CONSULTANT ONLY.

3. <u>MATERIALS AND EQUIPMENT</u>
3.1 ALL MATERIALS AND EQUIPMENT SHALL BE NEW, C.S.A. CERTIFIED AND MANUFACTURED TO THE STANDARDS SPECIFIED. WHERE THERE IS NO ALTERNATIVE TO SUPPLYING EQUIPMENT WHICH IS NOT C.S.A. CERTIFIED, OBTAIN SPECIAL APPROVAL FROM THE ELECTRICAL SAFETY AUTHORITY.

4. <u>PERMITS AND FEES</u> 4.1 THE ELECTRICAL CONTRACTOR SHALL ACT AS THE OWNER'S AGENT IN ACCORDANCE WITH SECTION 2 OF THE O.E.S.C. AND SHALL IMMEDIATELY UPON AWARD OF CONTRACT, SUBMIT TO THE LOCAL ELECTRICAL INSPECTION DEPARTMENT, THE NECESSARY NUMBER OF DOCUMENTS FOR EXAMINATION, SPECIAL INSPECTION AND APPROVAL, PRIOR TO THE COMMENCEMENT OF THE WORK, AND PAY ALL COSTS AND ASSOCIATED FEES. IF REQUIRED, PREPARE ANY ADDITIONAL DRAWINGS/DOCUMENTS REQUIRED BY THE AUTHORITY.

4.2 THE CONSULTANT WILL PROVIDE UPON REQUEST, AT THE CONTRACTOR'S COST, THE REQUIRED QUANTITY OF DRAWINGS. 4.3 PROVIDE CERTIFICATE(S) OF ACCEPTANCE FROM THE AUTHORITIES INSPECTION DEPARTMENT, UPON COMPLETION OF WORK.

5. <u>INSURANCE</u>
5.1 PROVIDE AND MAINTAIN INSURANCE TO PROTECT THE OWNER AND TRADES FROM ALL POSSIBLE CLAIMS. SUBMIT WITH BID FOR AN AMOUNT ACCEPTABLE TO OWNER.

6. CONTRACT DOCUMENTS
6.1 THE DRAWINGS FOR THE ELECTRICAL WORK ARE DIAGRAMMATIC PERFORMANCE DRAWINGS ONLY, INTENDED TO CONVEY THE SCOPE OF WORK AND INDICATE THE GENERAL ARRANGEMENT AND APPROXIMATE SIZE AND LOCATION OF ELECTRICAL EQUIPMENT. THE DRAWINGS DO NOT INTEND TO SHOW ARCHITECTURAL, INTERIOR DESIGN, MECHANICAL, STRUCTURAL OR BASE BUILDING DETAILS. BE RESPONSIBLE FOR A THOROUGH KNOWLEDGE OF SAME BEFORE PROCEEDING WITH THE WORK. 6.2 DO NOT SCALE OR MEASURE DRAWINGS, BUT OBTAIN INFORMATION REGARDING ACCURATE DIMENSIONS FROM THE DIMENSIONS SHOWN

ON THE DESIGN CONSULTANT'S/ARCHITECT'S DRAWINGS, OR BY SITE REQUIREMENTS. 6.3 ANY DISCREPANCIES BETWEEN DRAWINGS AND/OR SPECIFICATIONS MUST BE REFERRED TO THE DESIGN CONSULTANT/ARCHITECT

6.4 COOPERATE AND COORDINATE WITH OTHER CONTRACTORS IN LAYING OUT OF WORK SO AS NOT TO CONFLICT WITH THE WORK OF OTHER CONTRACTORS. CARRY OUT WORK PROMPTLY AS PER CONSTRUCTION SCHEDULE AND COORDINATE WITH WORK OF OTHER

6.5 MAKE, AT NO ADDITIONAL COST, ANY CHANGES OR ADDITIONS TO MATERIALS AND EQUIPMENT NECESSARY TO ACCOMMODATE STRUCTURAL CONDITIONS (OFFSETS AROUND BEAMS, COLUMN, ETC.)

7. INTENT
7.1 IT IS THE INTENT OF THESE DRAWINGS AND SPECIFICATIONS THAT THE CONTRACTOR PROVIDES COMPLETE AND OPERATIONAL SYSTEMS
AS REQUIRED, WHERE DIFFERENCES OCCUR, THE MAXIMUM CONDITION SHALL GOVERN.

\*\*REQUIRED\*\* TO SECRIFICATION OF THE OPERATION OPERATION OF THE OPERATION OPE 7.2 ANY MISCELLANEOUS ITEMS, HARDWARE, DEVICES, WIRING, ETC., NOT SPECIFICALLY DESCRIBED, BUT REQUIRED FOR THE OPERATION OF THE SYSTEM, MUST BE PROVIDED AND INCLUDED AS PART OF THE BID.

8.1 SUBMIT FOUR (4) COPIES OF SHOP DRAWINGS OF ALL SPECIFIED EQUIPMENT FOR REVIEW AND RECORDS BEFORE COMMENCEMENT OF

8.2 CHANGES MADE TO THE SHOP DRAWINGS BY THE CONSULTANT WILL NOT AFFECT THE CONTRACT PRICE.

9. <u>INSERTS, HANGERS AND SLEEVES</u>
9.1 PROVIDE HANGERS, INSERTS, SLEEVES AND SUPPORTS AS REQUIRED.

9.2 INSERTS ARE TO BE OF A LEAD SHIELD TYPE. HANGERS MUST NOT BE WELDED TO STRUCTURAL STEEL MEMBERS AND BURNING OF HOLES IN STRUCTURAL STEEL IS PROHIBITED. 9.4 SLEEVES ARE TO BE OF A TYPE SUITABLE FOR THE APPLICATION AND BE SEALED AND MADE WATERTIGHT. SLEEVES THROUGH CONCRETE SHALL BE SCHEDULE 40 STEEL PIPES, SIZED FOR FREE PASSAGE OF CONDUIT AND INSTALLED FLUSH WITH UNDERSIZE OF CONCRETE SLAB AND EXTEND 100MM (4") ABOVE FINISHED FLOOR UNLESS OTHERWISE NOTED.

9.5 DO NOT USE ANY BUILDING SUPPORTS OR EQUIPMENT, INCLUDING CEILING SUPPORT SYSTEM.

10. <u>CUTTING AND PATCHING</u> 10.1 ALL CUTTING AND PATCHING REQUIRED TO THE BUILDING STRUCTURE FOR THE WORK SHALL BE INCLUDED UNDER THIS CONTRACT AND RE ACCEPTABLE TO THE OWNER 10.2 WHERE CONDUITS PASS THROUGH FIRE RATED WALLS OR FLOORS, PROVIDE FIRE STOPPING MATERIAL LISTED WITH, AND BEAR LABEL

PADS (TYPE MWP) WHEN FLOOR MOUNTED.

11.1 REFER TO DESIGN CONSULTANT'S/ARCHITECT'S DRAWINGS FOR EXACT LOCATIONS OF ALL LIGHTING FIXTURES AND WIRING DEVICES. 11.2 CHANGE LOCATION OF OUTLETS AT NO COST OR CREDIT, PROVIDING DISTANCE DOES NOT EXCEED 3M (10'-0") AND INFORMATION IS 11.3 ALL OUTLETS TO BE MARKED ON JOB SITE FOR APPROVAL BY DESIGN CONSULTANT/ARCHITECT PRIOR TO INSTALLATION.

OF CSA AND ULC, AND MAINTAIN SAME FIRE RATING OF BUILDING COMPONENT PENETRATION.

12.1 PROVIDE ALL PLYWOOD BACKBOARDS REQUIRED FOR THE WORK OF THIS DIVISION. PLYWOOD BACKBOARDS SHALL BE 21MM (3/4") THICK, OF HIGHEST QUALITY FIRE RETARDANT FIR. REFER TO DRAWINGS FOR SIZE. PRIME AND PAINT BACKBOARDS WITH FIRE RETARDANT PAINT EQUAL TO CGSB SPEC. #1-GP-151M, OF A COLOUR AS SELECTED BY THE DESIGN CONSULTANT/ARCHITECT

13. <u>ACCESS DOORS</u>
13.1 WHEREVER ANY ELECTRICAL EQUIPMENT REQUIRES ACCESSIBILITY, MAINTENANCE OR ADJUSTMENT, PROVIDE ACCESS DOORS APPROVED BY DESIGN CONSULTANT/ARCHITECT AND OWNER. ARRANGE FOR ITS INSTALLATION BY THE DIVISION IN WHOSE WORK IT OCCURS.

14. <u>CORE\_DRILLING</u>
14.1 BEFORE CORE DRILLING FLOOR SLAB OR STRUCTURAL WALLS, X—RAY SLAB OR WALLS AND HAVE THE LOCATIONS ACCEPTED BY THE 14.2 ANY BUILDING SERVICE DAMAGED BY CORE DRILLING MUST BE REPAIRED IMMEDIATELY AT NO COST TO THE OWNER. 14.3 FLOOR DRILLING TO BE CARRIED OUT AT A TIME ACCEPTABLE TO THE OWNER AND ALLOWANCES FOR THIS WORK SHALL BE INCLUDED

15. <u>NOISE AND VIBRATION</u>
15.1 ELECTRICAL EQUIPMENT IS TO OPERATE WITHOUT OBJECTIONABLE NOISE OR VIBRATION. IF, IN THE OPINION OF THE CONSULTANT, THE EQUIPMENT OPERATES WITH EXCESSIVE NOISE OR VIBRATION. THEN THE EQUIPMENT MUST BE REPLACED OR NOISE OR VIBRATION

15.2 CONNECTIONS TO NOISE-PRODUCING AND VIBRATING EQUIPMENT MUST BE MADE WITH FLEXIBLE CONDUIT. THIS INCLUDES TRANSFORMERS, DIMMING EQUIPMENT RACKS, AND MOTORS. USE A MINIMUM OF 1M (3 FT) OF FLEXIBLE CABLE WITH SLACK AT EACH 15.3 VIBRATION ISOLATORS ARE TO BE PROVIDED WHERE INDICATED OR REQUIRED. TRANSFORMERS TO BE ISOLATED FROM THE STRUCTURE. WITH SPRING AND RUBBER ISOLATORS WHEN WALL MOUNTED OR SUSPENDED AND 12MM (1/2") HIGH DENSITY NEOPRENE SANDWICH

16. <u>IDENTIFICATION</u>
16.1 PROVIDE LAMACOID NAMEPLATES ON ALL PANELS; DISCONNECT SWITCHES, SPLITTERS, ETC., NAMEPLATES SHALL BE MECHANICALLY ATTACHED TO EQUIPMENT BY MEANS OF RIVETS OR SELF TAPPING SCREWS.

16.2 PROVIDE TYPEWRITTEN DIRECTORIES FOR ALL PANELS. CLEARLY MARK ALL EXPOSED CONDUIT, PULLBOXES, JUNCTION BOXES, ETC., TO INDICATE THE NATURE OF THE SERVICE TO MATCH BASE BUILDING STANDARDS.

17. <u>VALUATION OF CHANGES</u>
17.1 PROVIDE COMPLETE BREAKDOWN OF MATERIAL, LABOUR, OVERHEAD, PROFIT, ETC., WHEN SUBMITTING QUOTATIONS FOR CHANGE 17.2 THE HOURLY LABOUR RATE SHALL BE INCLUSIVE OF ALL CHARGES FOR SUPERVISION, VARIABLE LABOUR FACTORS, HAND TOOLS,

PAYROLL BURDENS, HEIGHT FACTORS, WARRANTIES, STORAGE, RENTALS, ADDITIONAL BONDING, PARKING, CLEAN-UP, AS-BUILT DRAWINGS, HOISTING, FREIGHT AND DELIVERY, BUT EXCLUSIVE OF OVERHEAD AND PROFIT. 17.3 THE LABOUR HOURS SHALL BE BASED ON THE LATEST ISSUE OF THE NATIONAL ELECTRICAL CONTRACTORS ASSOCIATION (NECA) LABOUR UNITS, COLUMN ONE NORMAL FOR THE DURATION OF THIS CONTRACT. 17.4 THE MATERIAL PRICES SHALL BE BASED ON THE CURRENT NATIONAL PRICES SYSTEM (NPS) CATALOGUE LESS APPLICABLE TRADE

18. ENGINEERS FINAL INSPECTION

18.1 FINAL INSPECTION IS IMPERATIVE. PRIOR TO CLOSING OF CEILINGS, THIS CONTRACTOR SHALL CONTACT E-LUMEN INTERNATIONAL INC. (905) 417-6881 AND THE OWNER'S REPRESENTATIVE TO PERFORM A FINAL INSPECTION WHEN CEILING TILES HAVE BEEN INSTALLED IT WILL BE NECESSARY FOR THE CONTRACTOR TO REMOVE PORTIONS FOR INSPECTION.

19. <u>COMPLETION OF CONTRACT</u>
19.1 ALL EQUIPMENT MUST BE CLEANED AND TESTED BEFORE FINAL ACCEPTANCE BY CONSULTANT.

19.2 FROM THE DATE OF ISSUANCE OF A "CERTIFICATE OF SUBSTANTIAL PERFORMANCE", PROVIDE A WRITTEN GUARANTEE FOR ONE YEAR COVERING ALL EQUIPMENT, MATERIALS AND WORKMANSHIP, OTHER THAN LAMPS. INSERT IN OPERATIONS AND MAINTENANCE MANUAL.

19.3 DEFECTS AND DEFICIENCIES WHICH ORIGINATE OR BECOME EVIDENT DURING THE WARRANTY PERIOD MUST BE REPAIRED OR REPLACED,

19.4 REPLACE, AT NO COST, ALL INCANDESCENT LAMPS BURNED-OUT DURING A THIRTY (30) DAY PERIOD AND ALL BURNED-OUT

FLUORESCENT AND HID LAMPS FOR A PERIOD OF NINETY (90) DAYS AFTER DATE OF ISSUANCE OF CERTIFICATE OF "SUBSTANTIAL

PERFORMANCE" FOR THE CONTRACT FOR THE WORK 19.5 IF, DURING THE WARRANTY PERIOD, TRANSFORMERS, BALLASTS OR OTHER NOISE AND VIBRATION PRODUCING EQUIPMENT ARE CONSIDERED BY THE CONSULTANT TO EXCEED ACCEPTABLE STANDARDS, THEN THESE MUST BE REPLACED WITHOUT DELAY OR ADDITIONAL COST TO THE OWNER. ALL WORK RELATING TO THE REPLACEMENT OF DEFECTIVE ITEMS, MUST BE CARRIED OUT AFTER NORMAL WORKING HOURS AND AT A TIME WHICH IS ACCEPTABLE TO THE OWNER.

20. <u>AS-BUILT DRAWINGS</u>
20.1 AT THE COMPLETION OF WORK AND BEFORE FINAL ACCEPTANCE, PROVIDE AS-BUILT DRAWINGS OF THE INSTALLATION IN AUTOCAD RELEASE 2013 FORMAT. AN ELECTRONIC COPY (AUTOCAD FORMAT) OF ALL DRAWINGS WILL BE PROVIDED TO THE ELECTRICAL CONTRACTOR BY THE CONSULTANT AT NO COST. THE DRAWINGS WILL REFLECT THE TENDER AND/OR CONSTRUCTION SET OF DRAWINGS. SHOULD THE CONTRACTOR REQUIRE ADDITIONAL ELECTRONIC COPIES DURING CONSTRUCTION, A COST OF \$100.00 PER DRAWING (PLUS HST) WILL BE CHARGED BY THE CONSULTANT.

20.2 INCORPORATE ALL CHANGES AND DEVIATIONS FROM TENDER DRAWINGS, UTILIZING NORMAL RECOGNIZED DRAFTING PROCEDURES THAT MATCH THE ORIGINAL DRAFTING METHODOLOGY. 20.3 ALL MAIN BRANCH CONDUIT RUNS, JUNCTION BOX LOCATIONS, CONDUIT RUNS FOR ALL FLOOR OUTLETS, ETC., MUST BE

REFLECTED ON THE DRAWINGS. 20.4 REMOVE THE ELECTRICAL ENGINEER'S STAMP AND COMPANY NAME FROM ALL DRAWINGS. 20.5 CLEARLY INDICATE THE WORDS "AS-BUILT" IN THE TITLE BLOCK COLUMN OF THE DRAWINGS AS WELL AS THE ELECTRICAL

CONTRACTOR'S NAME AND ADDRESS. 20.6 SUBMIT A PRINT TO CONSULTANT FOR REVIEW. WHEN FOUND ACCEPTABLE BY THE CONSULTANT, SUBMIT THREE (3) SETS OF PRINTS TOGETHER WITH THE CAD-DISK FOR PRESENTATION TO THE OWNER.

21. OPERATION AND MAINTENANCE MANUALS 21.1 PROVIDE 2 (TWO) SETS OF OPERATION AND MAINTENANCE MANUALS SUBMITTED IN HARD COVER 3-RING BINDERS. INCLUDE THE FOLLOWING INFORMATION IN THE OPERATIONS AND MAINTENANCE MANUALS:

1.1.1. NAMES AND ADDRESS OF LOCAL SUPPLIERS FOR THE ITEMS INCLUDED. 1.1.2. TECHNICAL DATA, PRODUCT DATA, SUPPLEMENTED BY BULLETINS, COMPONENT ILLUSTRATIONS, EXPLODED VIEWS, TECHNICAL DESCRIPTIONS OF ITEMS, AND PARTS LISTS. ADVERTISING OR SALES LITERATURE IS NOT ACCEPTABLE.

1.1.3. THE CONSULTANT'S REVIEWED SHOP DRAWINGS. 1.1.4. CERTIFICATE(S) OF ACCEPTANCE FROM THE AUTHORITIES INSPECTION DEPARTMENT.

1.1.5. VERIFICATION REPORTS AND CERTIFICATE(S) FOR FIRE ALARM SYSTEMS AND MISCELLANEOUS SYSTEMS (I.E. SECURITY, LIGHTING CONTROL, DIGITAL METERING). LOAD BALANCE REPORT.

1.1.7. WRITTEN GUARANTEE. 21.2 REVIEW INFORMATION PROVIDED IN THE MAINTENANCE INSTRUCTIONS AND MANUALS WITH THE OWNER'S OPERATING PERSONNEL. TO ENSURE A COMPLETE UNDERSTANDING OF THE ELECTRICAL EQUIPMENT AND SYSTEMS AND THEIR

MATERIALS AND METHODS

CONDUITS AND CONDUIT FITTINGS
 PROVIDE ALL CONDUIT UP TO AND INCLUDING 103MM (4") SIZE, AS EMT THIN WALL WITH STEEL SET SCREW TYPE FITTINGS AND WEATHERPROOF CONNECTORS WITH "0" RINGS IN SPRINKLERED BUILDINGS. BUSHINGS AND CONNECTORS TO BE C/W

PROVIDE FLEXIBLE METAL CONDUIT FOR CONNECTION TO MOTORS. INSTALL CONDUITS TO CONSERVE HEADROOM, PARALLEL AND PERPENDICULAR TO BUILDING LINES. DO NOT CADDIE CLIP CONDUITS TO CEILING HANGERS.

1.4 ALL EMPTY CONDUITS SHALL BE COMPLETE WITH NYLON FISH WIRE. 1.5 RUN TWO (2) 27MM (1") SPARE CONDUITS UP TO CEILING SPACE FOR EACH RECESSED PANELBOARD. TERMINATE THESE

CONDUITS IN A 155MMX155MMX103MM (6"X6"X4") COVERED JUNCTION BOX IN CEILING SPACE. ALL COMMUNICATIONS CONDUIT SHALL BE REAMED AND INSTALLED COMPLETE WITH INSULATED BUSHINGS AT EACH END. CONTRACTOR SHALL INFORM THE CONSULTANT OF ANY COMMUNICATIONS CONDUIT LENGTHS IN EXCESS OF 70M (230 FT.)

ALL COMMUNICATIONS CONDUIT SHALL BE REAMED AND INSTALLED COMPLETE WITH INSULATED BUSHINGS AT EACH END. CONTRACTOR SHALL INFORM THE CONSULTANT OF ANY COMMUNICATIONS CONDUIT LENGTHS IN EXCESS OF 70M (230 FT.)

SPLITTERS, JUNCTION BOXES AND PULL BOXES

1 SPLITTERS SHALL HAVE SHEET STEEL ENCLOSURE, WITH WELDED CORNERS AND FORMED HINGED COVER SUITABLE FOR LOCKING IN CLOSED POSITION. CONNECTION BARS ARE TO MATCH REQUIRED SIZE AND NUMBER OF INCOMING AND

OUTGOING CONDUCTORS AS INDICATED. 2.2 JUNCTION BOXES AND PULLBOXES SHALL BE SUITABLE FOR SURFACE MOUNTING AND BE OF WELDED STEEL CONSTRUCTION WITH SCREW-ON FLAT COVERS. FOR FLUSH-MOUNTED PULL AND JUNCTION BOXES, PROVIDE COVERS WITH 27MM (1") MINIMUM EXTENSION ALL AROUND.

2.4 INSTALL JUNCTION AND PULL BOXES IN INCONSPICUOUS BUT ACCESSIBLE LOCATIONS. 2.5 A MINIMUM OF ONE PULL BOX SHALL BE INSTALLED FOR EVERY 100 FT. (30M) OF CONDUIT. (NOTE: EACH 90 DEG. BEND SHALL EQUATE TO A 30 FT. (9M) LENGTH OF CONDUIT).

2.6 NO MORE THAN TWO (2) - 90 DEG. BENDS SHALL BE INSTALLED BETWEEN ANY TWO ADJACENT PULL BOXES.

UNLESS OTHERWISE NOTED.

5.4 ALL HOME RUNS TO BE IN CONDUIT

. <u>OUTLET BOXES</u> .1 OUTLET BOXES SHALL BE ELECTRO—GALVANIZED STEEL, SIZED AS REQUIRED BY CODE. 3.2 PROVIDE EACH LIGHT SWITCH, RECEPTACLE, COMMUNICATION AND OTHER OUTLET WITH AN OUTLET BOX. INSTALL PLUMB AND TRUE. PROVIDE 78MM (3") DEEP 1004 BOXES FOR DIMMING SWITCHES.

3.3 ADAPT ALL OUTLET BOXÉS TO THEIR RESPECTIVE LOCATIONS AND SUPPORT INDEPENDENTLY OF THE CONDUIT. DO NOT CADDLE CLIP TO CEILING HANGERS.

PROVIDE BLANK COVERPLATES FOR BOXES WITHOUT WIRING DEVICES.

DO NOT INSTALL OUTLET BOXES BACK TO BACK IN PARTITIONS, STAGGER TO PREVENT SOUND TRANSFER. TWO OR MORE OUTLET BOXES THAT OCCUR AT THE SAME LOCATION SHALL BE GANGED TOGETHER IN THE SAME

4. <u>Grounding</u> 4.1 Ground all equipment in accordance with latest edition of the electrical safety code. Provide separate SPLITTERS, DISCONNECT SWITCHES, ETC.).

. <u>Wire and Cable</u> .1 — All wire and cable shall be copper, minimum 12 gauge, no. 12 and no. 10 solid, no. 8 and larger stranded,

WITH RW90 (75°C) INSULATION, 600VOLT RATING.
5.2 BX#12 MAY BE USED IN CEILING SPACE FROM CEILING DISTRIBUTION BOX DOWN TO RECEPTACLES IN PARTITIONS. BX RUNS IN CEILING SPACE NOT TO EXCEED 3048MM(10'-0") IN LENGTH. DO NOT RUN BX CABLES INTO PANELBOARDS.
5.3 SIZE ALL WIRE FOR MAXIMUM 2% VOLTAGE DROP.

6. <u>LOCAL SWITCHES</u>
6.1 PROVIDE SPECIFICATION GRADE LOCAL 20A. 120 VOLT SWITCHES, A.C. TYPE WHITE WITH WHITE MATCHING COVERPLATES:
- P&S #2621 SERIES C/W SCREWLESS FACEPLATES - HUBBELL #HBL2121 SERIES C/W SCREWLESS FACEPLATES - LUTRON CLARO SERIES C/W SCREWLESS FACEPLATES

6.2 REFER TO LEGEND FOR OTHER TYPES.

7.1 PROVIDE SPECIFICATION GRADE 15A. 120 VOLT, "U" GROUND RECEPTACLES, DUPLEX TYPE WHITE WITH WHITE MATCHING COVERPLATES: - P&S #26252 SERIES C/W SCREWLESS FACEPLATES - HUBBELL #HBL2152 SERIES C/W SCREWLESS FACEPLATES

LUTRON CLARO SERIES REFER TO LEGEND FOR OTHER TYPES.

RECEPTACLES ON SEPARATE CIRCUITS ARE TO HAVE CIRCUIT NUMBER IDENTIFIED ON THE WALL PLATE AND FURTHER IDENTIFIED WITH THE EXACT LOCATION LISTED IN THE PANEL DIRECTORY.

8. MECHANICAL TRADE WIRING

8.1 UNLESS OTHERWISE NOTED, ALL STARTERS AND CONTROL WIRING TO BE PROVIDED BY DIVISION 15. DIVISION 16 TO RECEIVE, INSTALL STARTERS AND PROVIDE ALL POWER WIRING AND REQUIRED ISOLATING DISCONNECT SWITCHES.

8.2 CONFIRM ELECTRICAL REQUIREMENTS AND EXACT LOCATIONS OF ALL MECHANICAL EQUIPMENT WITH DIVISION 15 PRIOR TO

LUMINAIRES

I PROVIDE ALL LUMINAIRES AS SHOWN ON THE DRAWINGS AND AS SPECIFIED IN THE LUMINAIRE SCHEDULE

ACCESSORIES AND MOUNTING APPLIE 9.2 ALL LUMINAIRES SHALL BE COMPLETE WITH NEW LAMPS, BALLASTS, ACCESSORIES AND MOUNTING APPURTENANCES. 9.3 ALL LUMINAIRES TO BE CSA APPROVED.

9.4 AIM AND ADJUST ALL LUMINAIRES IN PRESENCE OF CONSULTANT. 9.5 ALL NEW DOWNLIGHTS AND FLUORESCENT LUMINAIRES INSTALLED ON DRYWALL OR T-BAR BUILDING CEILINGS SHALL BE INDEPENDENTLY SUPPORTED FROM BUILDING STRUCTURE WITH TENSO CHAINS UNLESS OTHERWISE NOTED. 9.6 COOPERATE WITH ALL OTHER TRADES FOR THE PROPER INSTALLATION OF ALL LUMINAIRES.

10. MEGGERING AND BALANCING
10.1 MEGGER ALL POWER CIRCUIT FEEDERS. IF GROUND RESISTANCE ON ANY CIRCUIT IS LESS THAN THAT REQUIRED BY CSA OR OTHER GOVERNING REGULATIONS, SUCH CIRCUITS ARE TO BE CONSIDERED DEFECTIVE AND MUST BE REPLACED.

10.2 MEASURE PHASE CURRENT TO PANELBOARDS WITH NORMAL LOADS OPERATING AT TIME OF ACCEPTANCE. ADJUST BRANCH CIRCUIT CONNECTIONS AS REQUIRED TO OBTAIN BEST BALANCE (NOT MORE THAN 10%) OF CURRENT BETWEEN PHASES AND

SUBMIT A REPORT FOR INSERTION INTO MANUALS. 11. <u>SERVICE EQUIPMENT</u>
11.1 ALL PANELBOARDS SHALL BE WITH COPPER LUGS, DISCONNECT SWITCHES, ETC., TO BE OF ONE MANUFACTURE, UNLESS

OTHERWISE NOTED. MOLDED CASE CIRCUIT BREAKERS TO BE BOLT-ON TYPE. MANUFACTURERS: SCHNEIDER,

CUTLER-HAMMER AND SIEMENS. 11.2 DRY TYPE TRANSFORMERS SHALL BE WITH A K FACTOR OF 13 AND WITH ELECTROSTATICALLY SHIELDED COPPER WINDINGS. PROVIDE DOUBLE LUGS ON TRANSFORMER NEUTRALS FOR CONNECTION OF CABLES. MANUFACTURER OF TRANSFORMERS MUST

BE: SCHNEIDER DELTA HAMMOND ATLAS

11.3 CEILING MOUNT TRANSFORMERS UP TO 45 KVA WITH SUSPENSION RODS AND SPRING ISOLATORS, TRANSFORMERS 75 KVA AND LARGER TO BE FLOOR MOUNTED ON KORFUND ISOLATION PADS UNLESS OTHERWISE NOTED.

11.4 PROVIDE SHORT CIRCUIT PROTECTION AND COORDINATION STUDY OF THE ENTIRE DISTRIBUTION SYSTEM. ENSURE PROPER INFORMATION IS OBTAINED INCLUDING HYDRO TRANSFORMER RATINGS. COORDINATION STUDY SHALL BE SUBMITTED TO CONSULTANT PRIOR TO SHOP DRAWINGS APPROVAL. NO EXTRA CHARGE WILL BE GRANTED FOR ADJUSTMENT TO BREAKER RATINGS OR FEEDER SIZES.

12. LIFE SAFETY SYSTEM

12.1 PROVIDE VERIFICATION AND TESTING OF THE F.A SYSTEM COMPONENTS. AND PROVIDE VERIFICATION CERTIFICATE TO OWNER. 12.2 PROVIDE A COMPLETE AND OPERATIONAL SYSTEM TO SUIT.

12.3 PROVIDE COMPLETE SHOP DRAWINGS AND RISER DIAGRAM ILLUSTRATING THE SYSTEM INSTALLATION.

SITE CONDITIONS. REPORT ANY DISCREPANCIES TO THE CONSULTANT BEFORE PROCEEDING WITH THE WORK. DRAWINGS ARE NOT TO BE SCALED FOR DIMENSIONS.



A - Drawing/detail number B - Sheet number where called C - Sheet number where drawn

SSUES/REVISIONS A				
No.	Date	Description By		
1	2024/04/12	ISSUED FOR PERMIT BV		
2	2024/07/30	ISSUED FOR TENDER BV		

#### PRIOR TO PROJECT CONSTRUCTION COMPLETION!!!!

GENERAL CONTRACTOR - MANDATORY DELIVERABLES (WHERE APPLICABLE):


-ALL OPERATION AND MAINTENANCE MANUALS. -ALL PRODUCT DATA THAT PERTAINS TO ALL FIRESTOPPING MATERIALS


-VERIFICATION LETTER BY A CERTIFIED AND LICENSED SPRINKLER AND LIFE SAFETY SYSTEMSCONTRACTOR. LETTER TO VERIFY INSTALLATION AND/OR MODIFICATIONS AND TESTING PERFORMED AND COMPLETED IN ACCORDANCE WITH NEPA 13 -ALL ESA REPORTS, FINAL SIGN OFF AND PERMITS

-VERIFICATION LETTER BY A CERTIFIED AND LICENSED EMERGENCY LIGHTING ANF LIFE SAFETY SYSTEMS CONTRACTOR. -CERTIFICATES OF FIRE ALARM VERIFICATION HYDRO INSPECTION CERTIFICATES -EMERGENCY LIGHTING TEST REPORT -TESTING, AIR BALANCING, ADJUSTING REPORTS FOR ALL HVAC SYSTEMS -ALL STRUCTURAL STEEL SHOP DRAWINGS AND ENGINEERING REVIEWS -ALL SITE VISIT REPORTS PROVIDED BY PROFESSIONAL DISCIPLINES. -OCCUPANCY AND COMPLIANCE LETTERS FROM ALL PROFESSIONAL DISCIPLINES.



**CONSULTING ENGINEERS** LIGHTING - ELECTRICAL 595 CITYVIEW BLVD, SUITE 204/205 VAUGHAN, ONTARIO, CANADA L4H 3M7 Tel:(905)417-6881 Fax:(905)417-6882

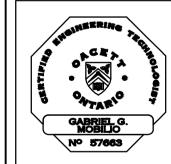

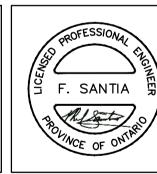

32 UNIT AFFORDABLE HOUSING APARTMENT BUILDING 20 SOUTH STREET, TRENTON, ON City of Quinte West


ELECTRICAL

**SPECIFICATION** 

DD/MU	Checked <b>BV</b>
Date June 2023	Scale N.T.S
Project Number	Sheet Number

23-019

E - 002

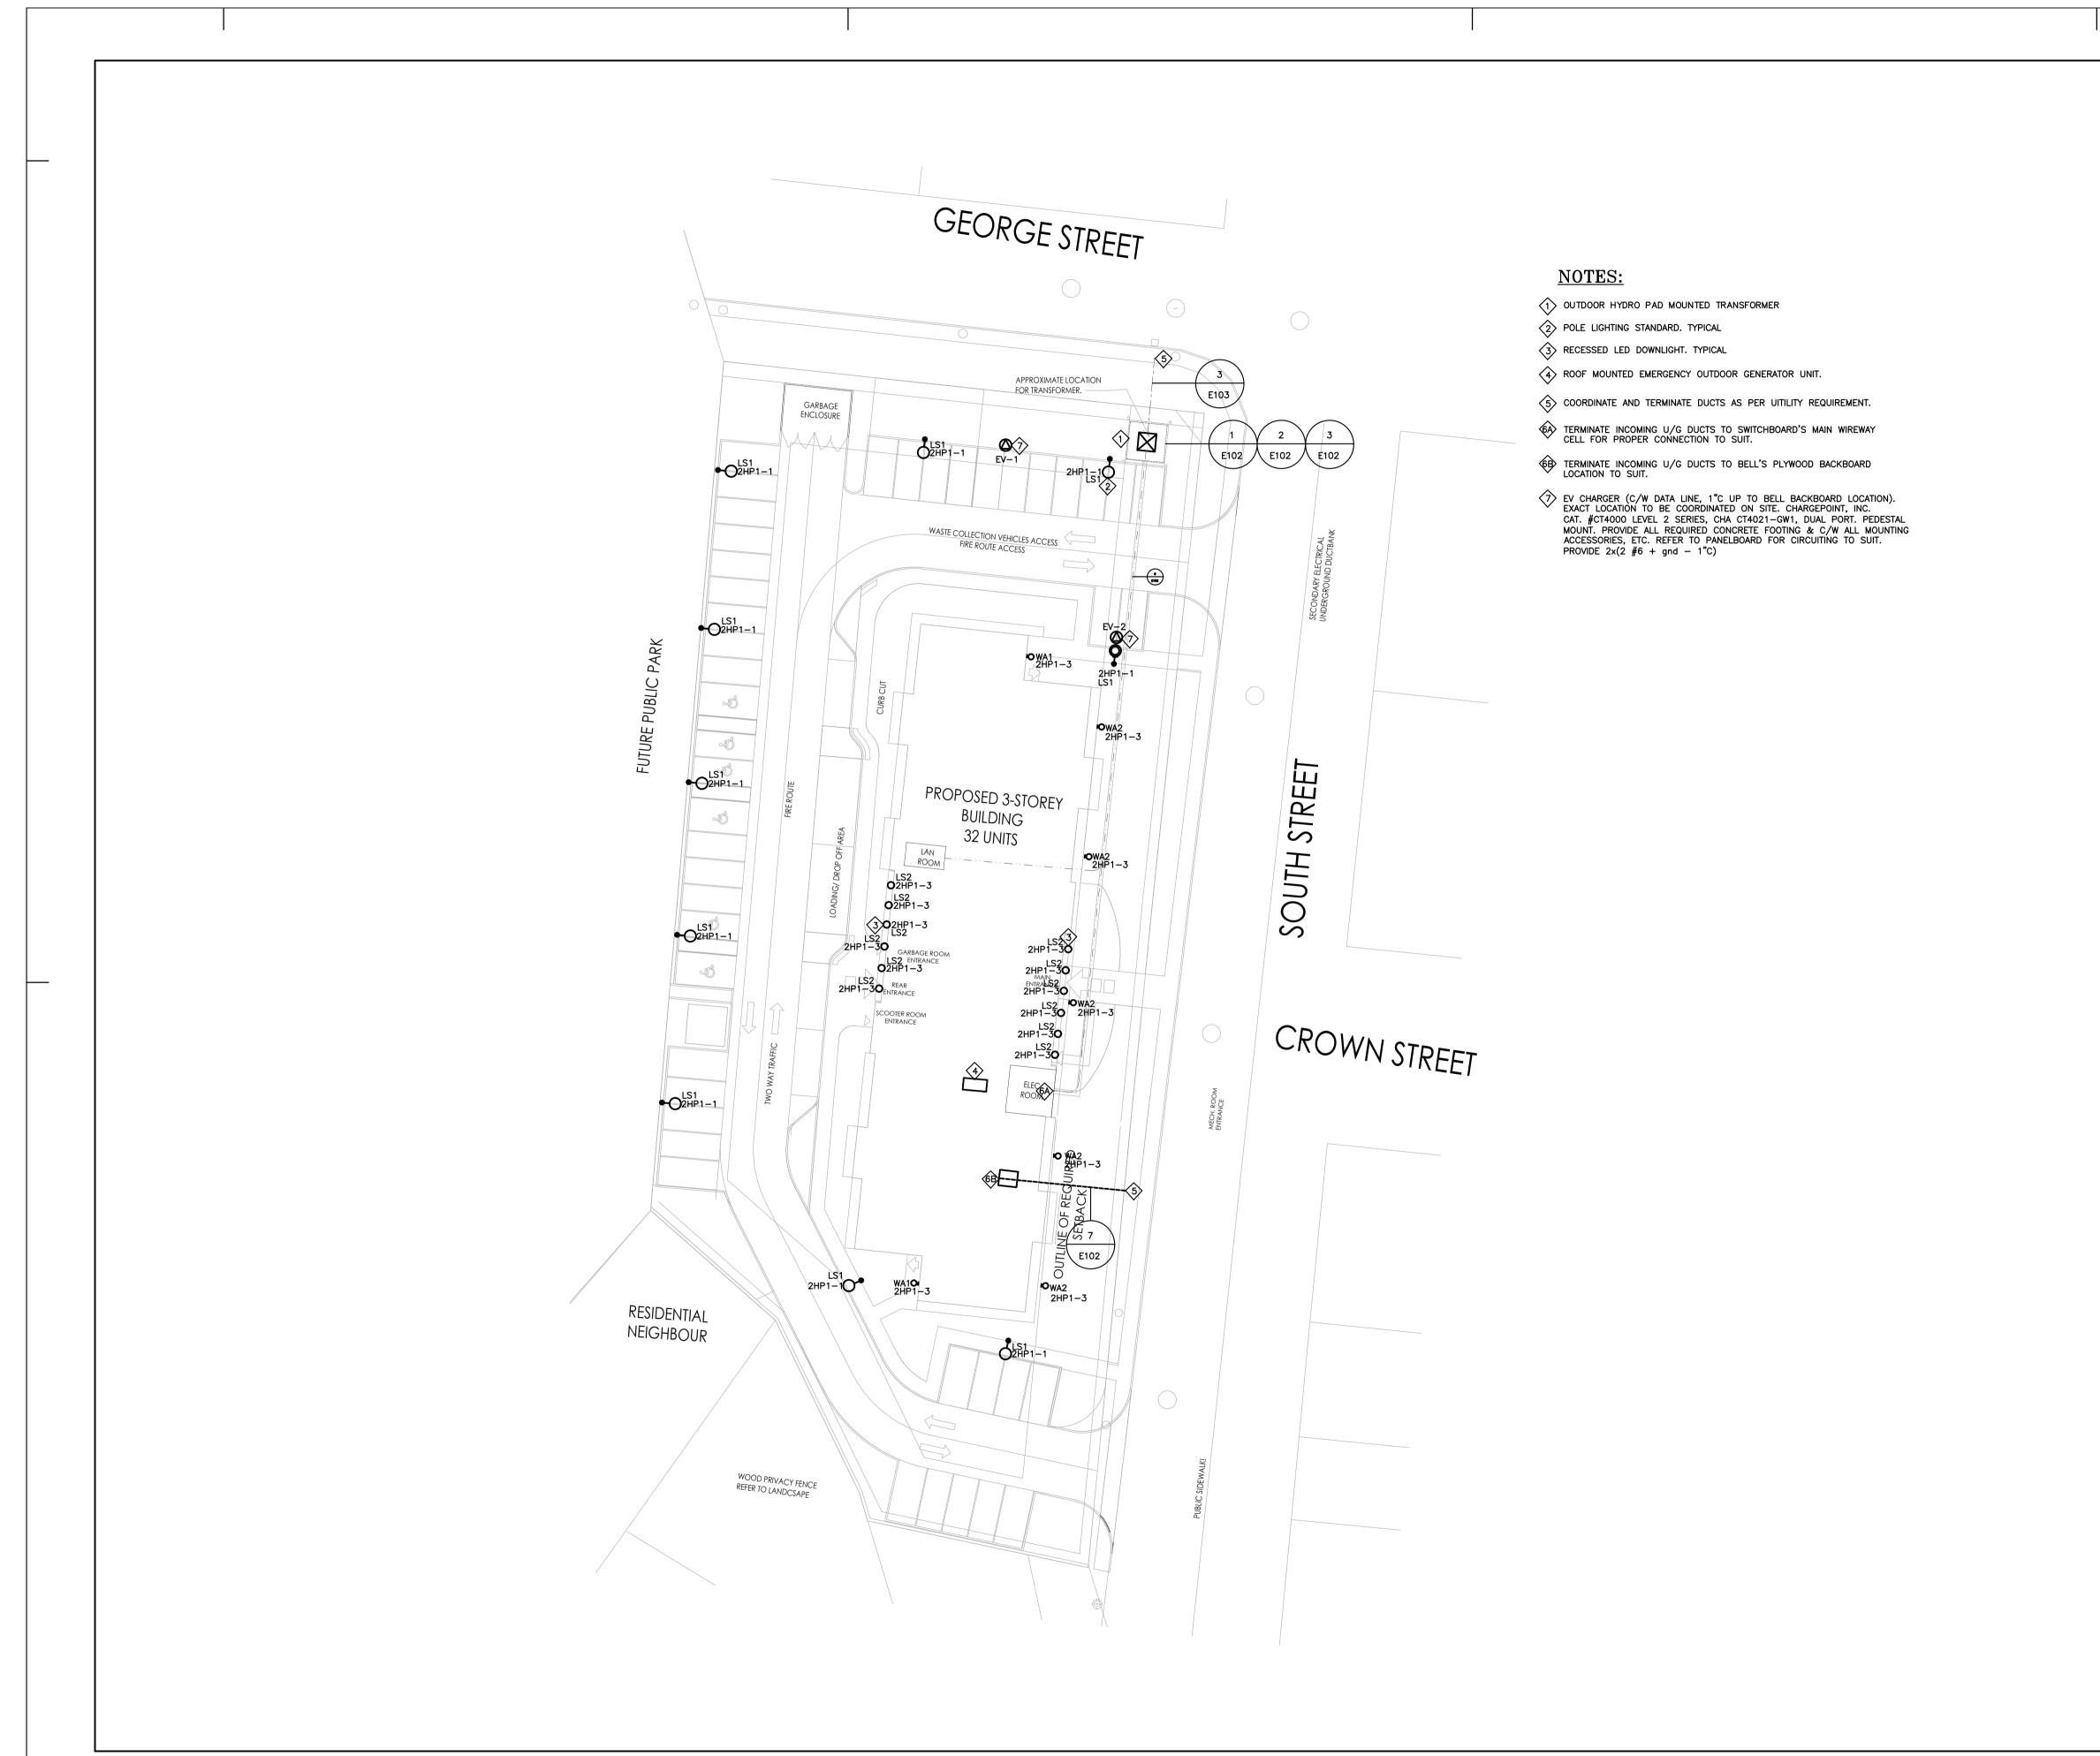



A - Drawing/detail number B - Sheet number where called C - Sheet number where drawn

SSUES/REVISIONS A				
No.	Date	Description By		
1	2024/04/12	ISSUED FOR PERMIT	BV	
2	2024/07/30	ISSUED FOR TENDER	BV	

#### PRIOR TO PROJECT CONSTRUCTION COMPLETION!!!!

GENERAL CONTRACTOR - MANDATORY DELIVERABLES (WHERE APPLICABLE):

ALL ITEMS LISTED BELOW ARE TO BE DELIVERED TO THE APPROPRIATE AUTHORITY HAVING JURISDICTION FOR THIS BUILDING PERMIT

## -ALL OPERATION AND MAINTENANCE MANUALS. -ALL PRODUCT DATA THAT PERTAINS TO ALL FIRESTOPPING MATERIALS

USED
-VERIFICATION LETTER BY A CERTIFIED AND LICENSED SPRINKLER AND LIFE SAFETY SYSTEMSCONTRACTOR. LETTER TO VERIFY INSTALLATION AND/OR MODIFICATIONS AND TESTING PERFORMED AND COMPLETED IN ACCORDANCE WITH NFPA 13
-ALL ESA REPORTS, FINAL SIGN OFF AND PERMITS


-VERIFICATION LETTER BY A CERTIFIED AND LICENSED EMERGENCY LIGHTING ANF LIFE SAFETY SYSTEMS CONTRACTOR. -CERTIFICATES OF FIRE ALARM VERIFICATION -HYDRO INSPECTION CERTIFICATES -EMERGENCY LIGHTING TEST REPORT.
-TESTING, AIR BALANCING, ADJUSTING REPORTS FOR ALL HVAC SYSTEMS -ALL STRUCTURAL STEEL SHOP DRAWINGS AND ENGINEERING REVIEWS

-ALL SITE VISIT REPORTS PROVIDED BY PROFESSIONAL DISCIPLINES. -OCCUPANCY AND COMPLIANCE LETTERS FROM ALL PROFESSIONAL DISCIPLINES.



CONSULTING ENGINEERS LIGHTING - ELECTRICAL 595 CITYVIEW BLVD, SUITE 204/205 VAUGHAN, ONTARIO, CANADA 14H 3M7 Tel:(905)417-6881 Fax:(905)417-6882 www.e-lumen.ca



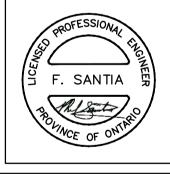

32 UNIT AFFORDABLE HOUSING APARTMENT BUILDING 20 SOUTH STREET, TRENTON, ON


City of Quinte West

ELECTRICAL SITE PLAN


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DD/MU	BV
Date June 2023	Scale 1:300
Project Number	Sheet Number
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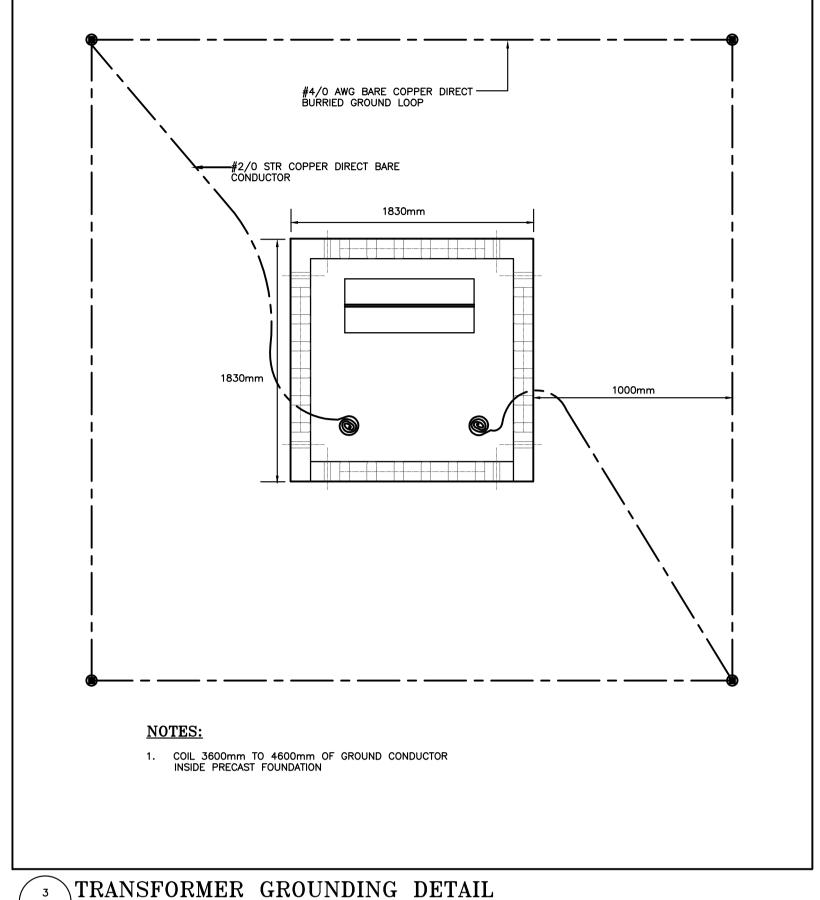
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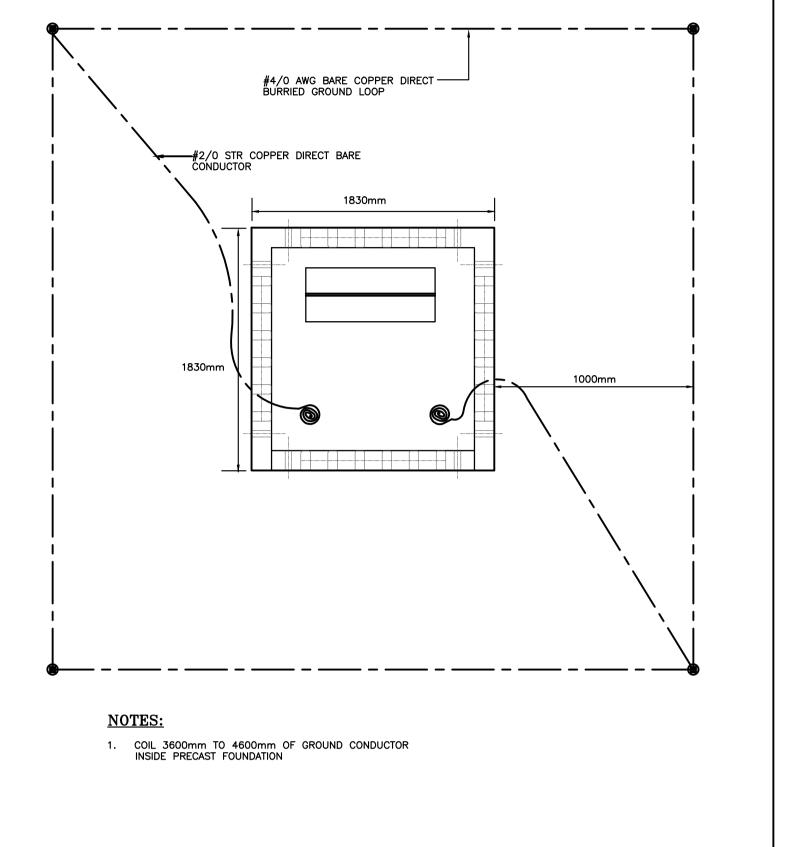
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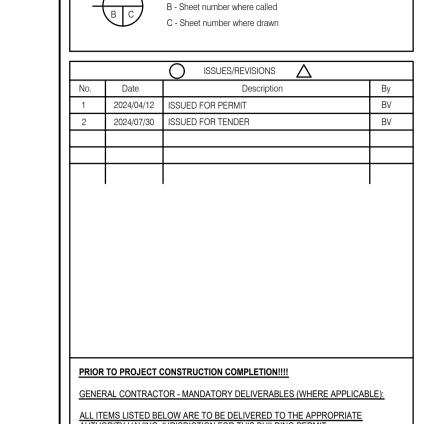


AND 19mm (1.9cm) CLEAR STONE.



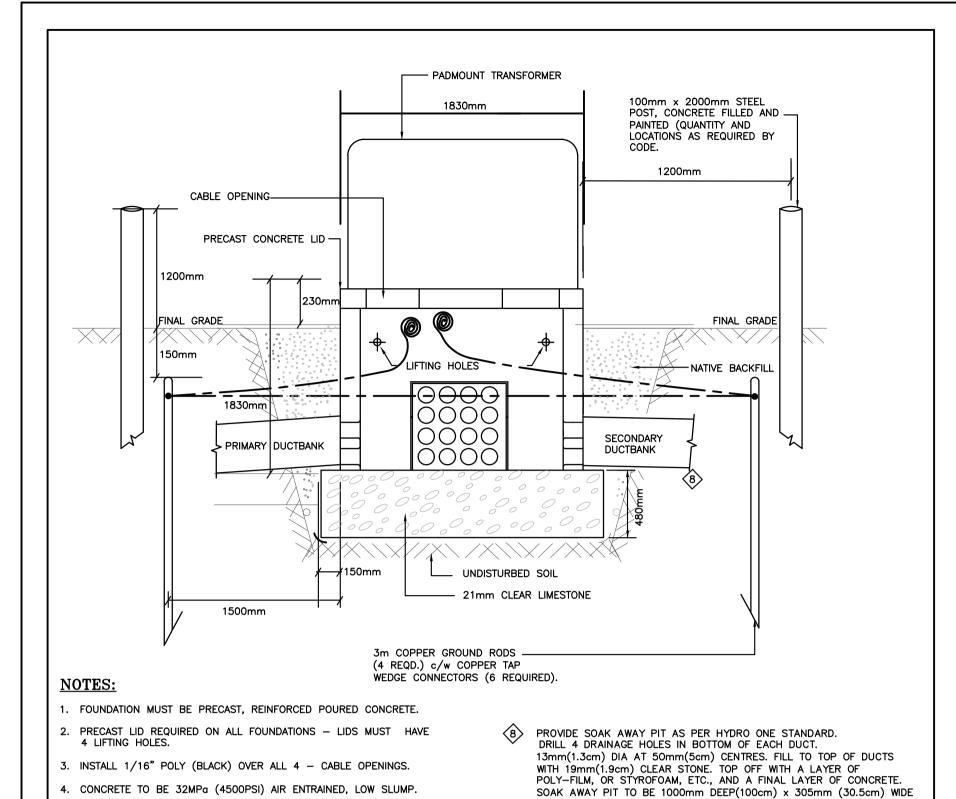



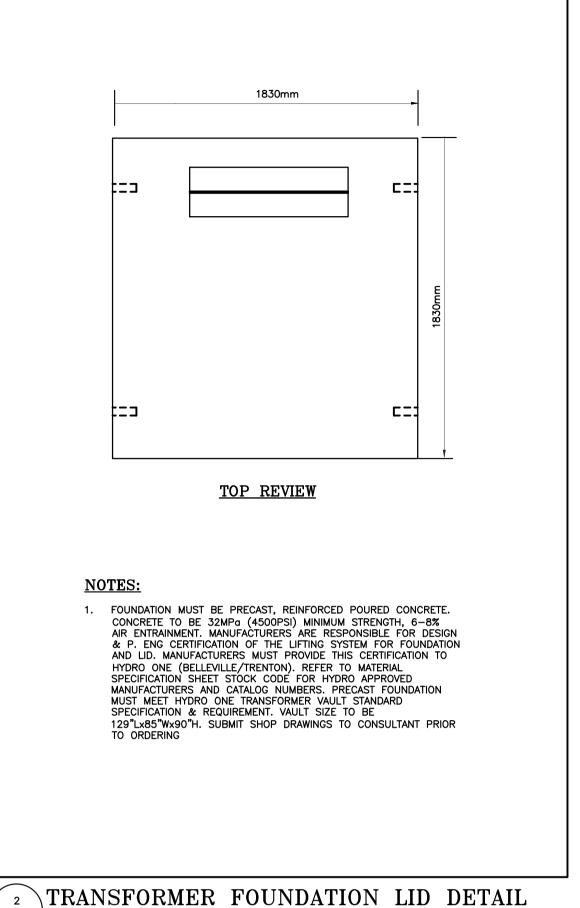

CONTRACTOR TO CHECK AND VERIFY ALL DIMENSIONS AND SITE CONDITIONS. REPORT ANY DISCREPANCIES TO THE CONSULTANT BEFORE PROCEEDING WITH THE WORK. DRAWINGS ARE NOT TO BE SCALED FOR DIMENSIONS.

A - Drawing/detail number

-ALL OPERATION AND MAINTENANCE MANUALS. -ALL PRODUCT DATA THAT PERTAINS TO ALL FIRESTOPPING MATERIALS -VERIFICATION LETTER BY A CERTIFIED AND LICENSED SPRINKLER AND LIFE

SAFETY SYSTEMSCONTRACTOR. LETTER TO VERIFY INSTALLATION AND/OR MODIFICATIONS AND TESTING PERFORMED AND COMPLETED IN ACCORDANCE WITH NEPA 13 -ALL ESA REPORTS, FINAL SIGN OFF AND PERMITS -VERIFICATION LETTER BY A CERTIFIED AND LICENSED EMERGENCY LIGHTING ANF LIFE SAFETY SYSTEMS CONTRACTOR. -CERTIFICATES OF FIRE ALARM VERIFICATION

-HYDRO INSPECTION CERTIFICATES -EMERGENCY LIGHTING TEST REPORT. -TESTING, AIR BALANCING, ADJUSTING REPORTS FOR ALL HVAC SYSTEMS -ALL STRUCTURAL STEEL SHOP DRAWINGS AND ENGINEERING REVIEWS -ALL SITE VISIT REPORTS PROVIDED BY PROFESSIONAL DISCIPLINES. -OCCUPANCY AND COMPLIANCE LETTERS FROM ALL PROFESSIONAL DISCIPLINES.

## \PAD MOUNTED TRANSFORMER DETAIL E-102 SCALE: N.T.S.

5. REINFORCED WITH No. 6 (21mm) HI-BOND REINFORCING STEEL


. MANUFACTURES AND SUPPLIERS OF FOUNDATION FOR THREE PHASE TRANSFORMER PAD APPROVED BY HYDRO ONE (TRENTON):


CONSULTANT FOR REVIEW PRIOR TO INSTALLATION.

SUBMIT TRANSFORMER FOUNDATION AND LID SHOP DRAWINGS TO


ARMTEC BROOKLIN CONCRETE

E-102 SCALE: N.T.S.

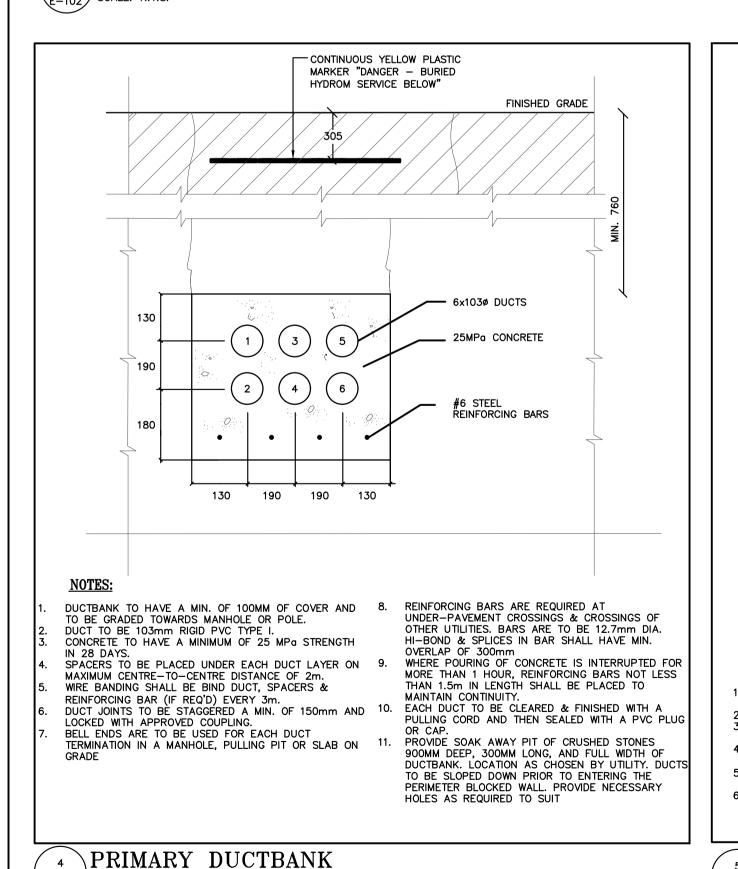


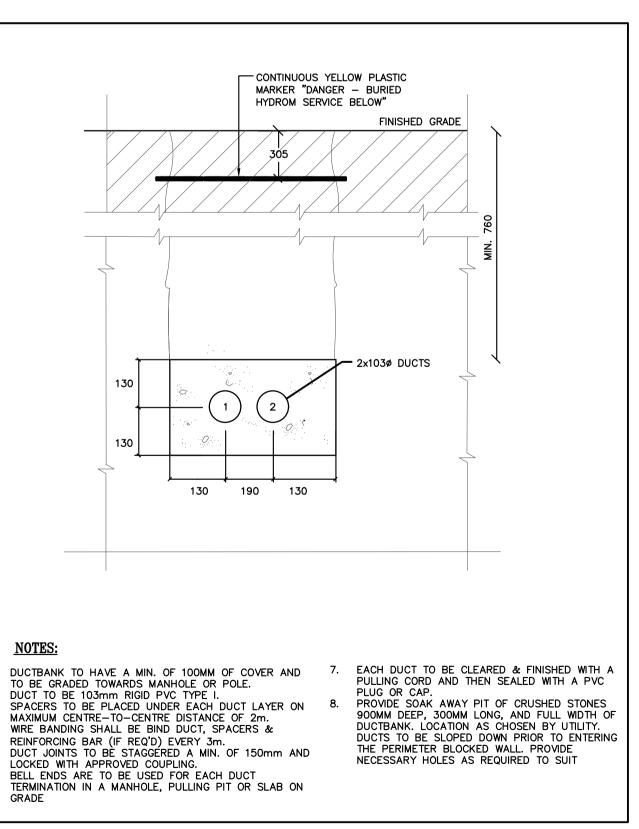



E-102 SCALE: N.T.S.

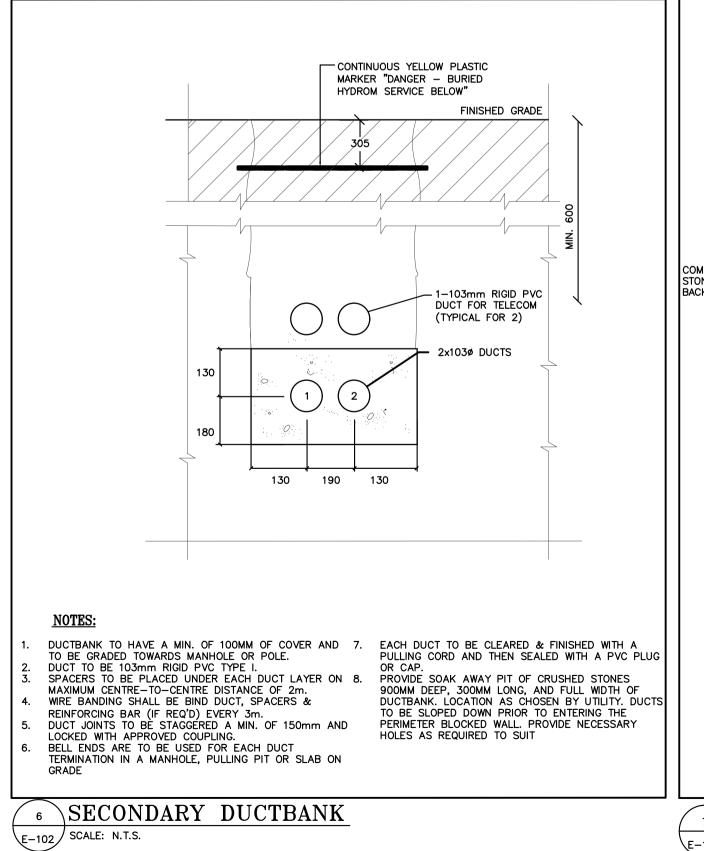

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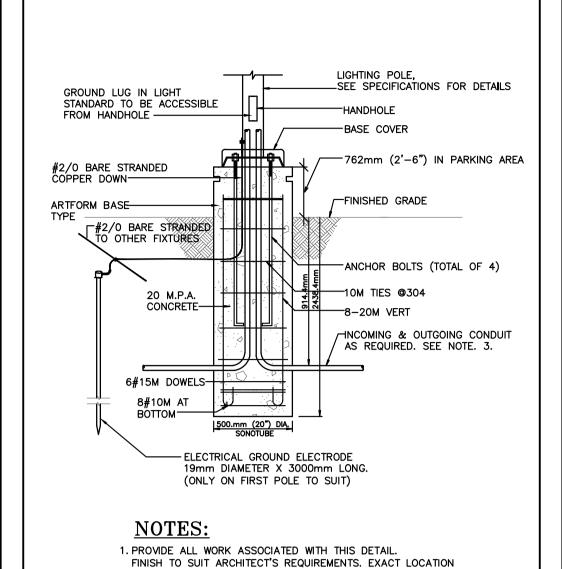

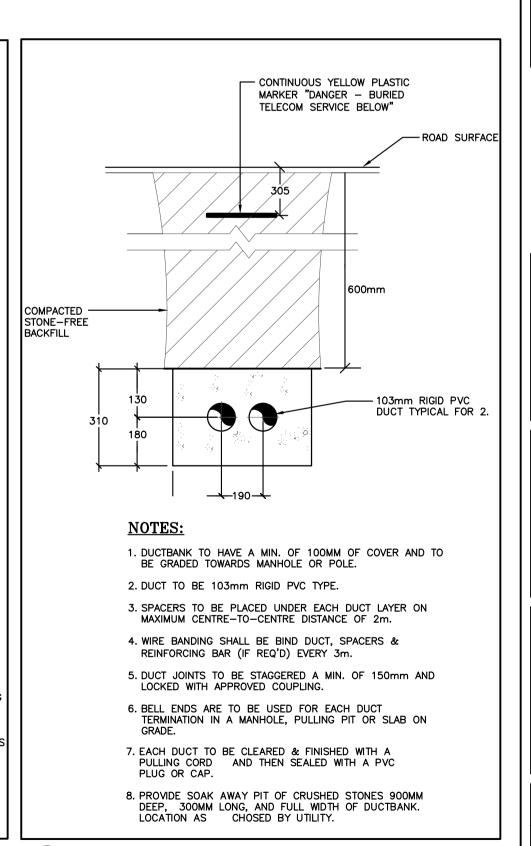
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7 COMMUNICATION DUCTBANK E-102 SCALE: N.T.S.

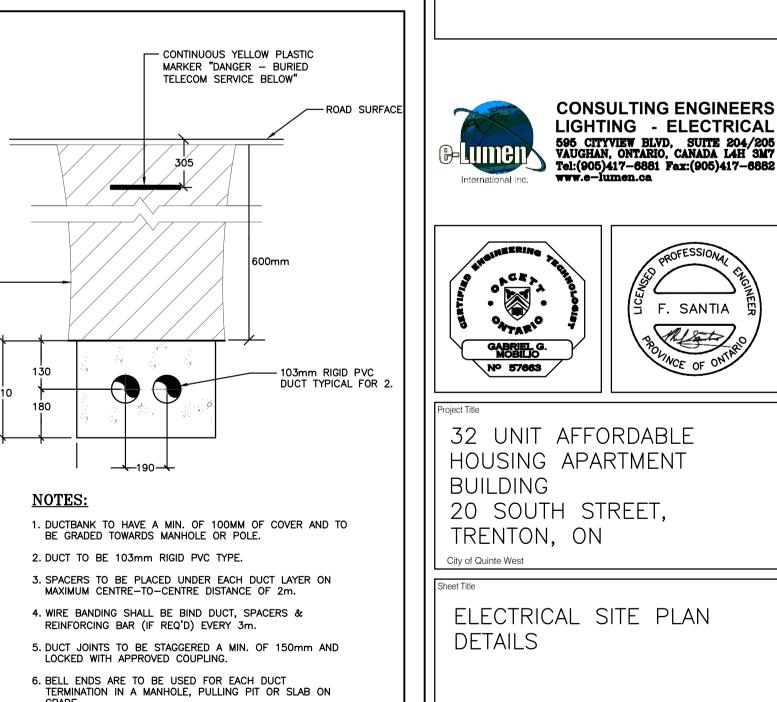5 SECONDARY DUCTBANK E-102 SCALE: N.T.S.

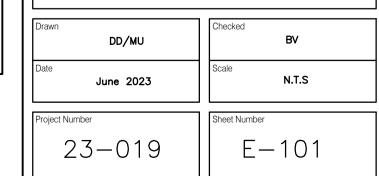


OF POLE MOUNTED LUMINAIRES TO BE COORDINATED WITH ARCHITECTURAL SITE PLAN.

GENERAL CONTRACTOR AND DIVISION 3.

OF WIRING 2#10+GND IN 1"C.

3. ELECTRICAL CONTRACTOR TO PROVIDE MINIMUM SIZE

2. REFER TO STRUCTURAL CONSULTANT FOR DETAILS OF BASE.
THE BASE SHALL BE PROVIDED BY DIVISION 16 IN ACCORDANCE
WITH SHOP DRAWINGS, DETAILS AND COORDINATION WITH

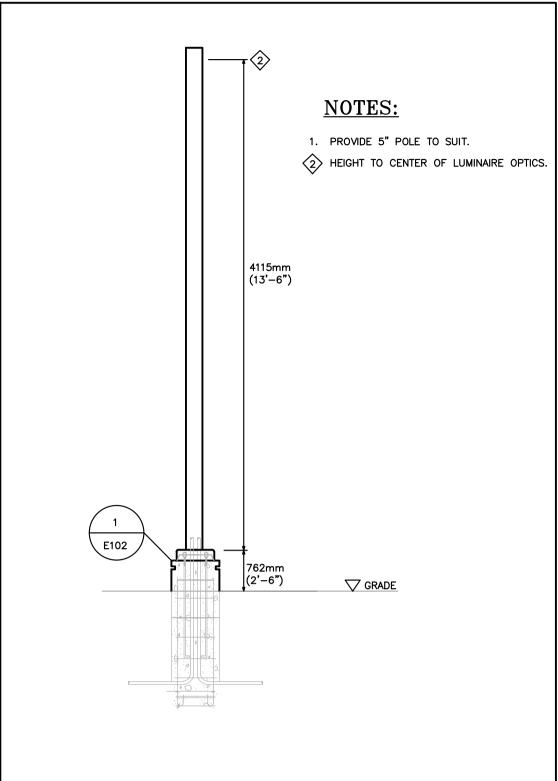





LIGHTING POLE BASE DETAIL E102 SCALE: N.T.S.

POLE DETAIL E102 SCALE: N.T.S.

POLE MOUNTED LUMINAIRE 'LA1'

SCALE: N.T.S.

LUMINAIRE TYPE 'LC1' E102 SCALE: N.T.S.

CONTRACTOR TO CHECK AND VERIFY ALL DIMENSIONS AND SITE CONDITIONS. REPORT ANY DISCREPANCIES TO THE CONSULTANT BEFORE PROCEEDING WITH THE WORK. DRAWINGS ARE NOT TO BE SCALED FOR DIMENSIONS.

A - Drawing/detail number B - Sheet number where called C - Sheet number where drawn

	ISSUES/REVISIONS $\triangle$	
Date	Description	Ву
2024/04/12	ISSUED FOR PERMIT	BV
2024/07/30	ISSUED FOR TENDER	BV
	2024/04/12	Date Description 2024/04/12 ISSUED FOR PERMIT

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-ALL PRODUCT DATA THAT PERTAINS TO ALL FIRESTOPPING MATERIALS

-VERIFICATION LETTER BY A CERTIFIED AND LICENSED SPRINKLER AND LIFE SAFETY SYSTEMSCONTRACTOR. LETTER TO VERIFY INSTALLATION AND/OR MODIFICATIONS AND TESTING PERFORMED AND COMPLETED IN ACCORDANCE WITH NFPA 13
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**CONSULTING ENGINEERS** LIGHTING - ELECTRICAL 595 CITYVIEW BLVD, SUITE 204/205 VAUGHAN, ONTARIO, CANADA L4H 3M7 Tel:(905)417-6881 Fax:(905)417-6882 www.e-lumen.ca





32 UNIT AFFORDABLE HOUSING APARTMENT BUILDING 20 SOUTH STREET, TRENTON, ON


City of Quinte West

ELECTRICAL SITE PLAN LIGHTING DETAILS

Drawn	Checked	
DD/MU	BV	
Date June 2023	Scale N.T.S	
Project Number	Sheet Number	
07 040		

23-019

E - 102

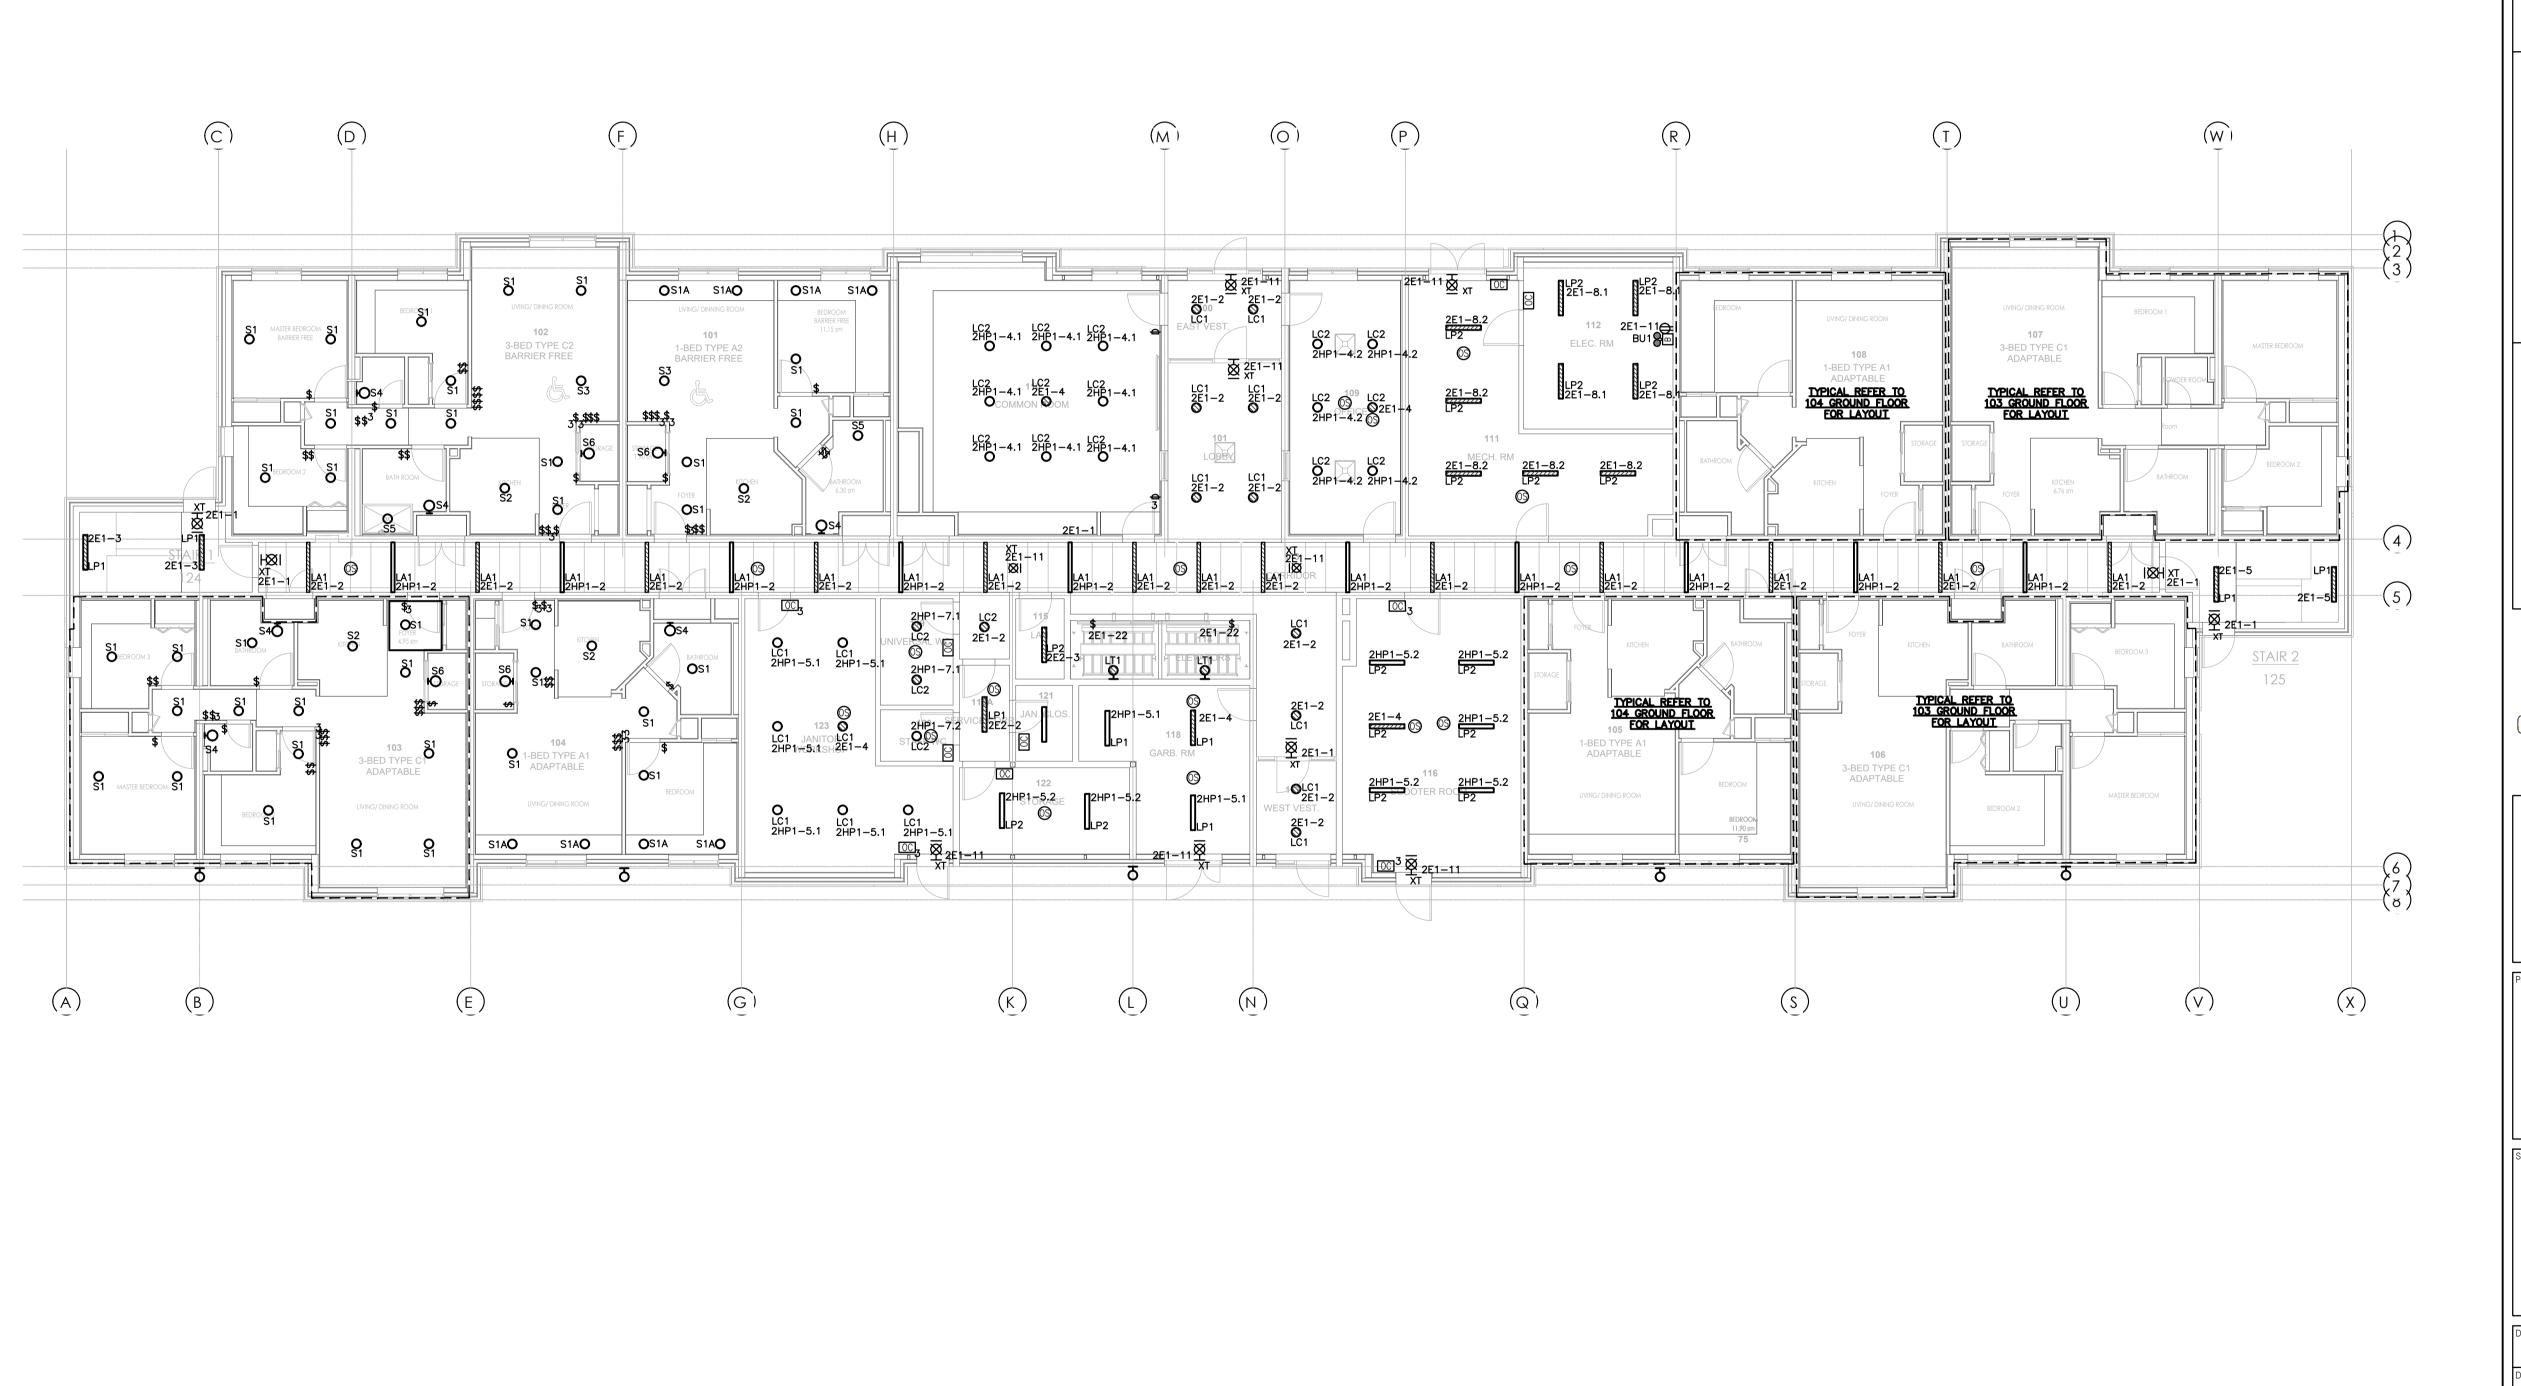



A - Drawing/detail number B - Sheet number where called C - Sheet number where drawn

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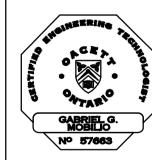
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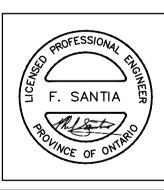
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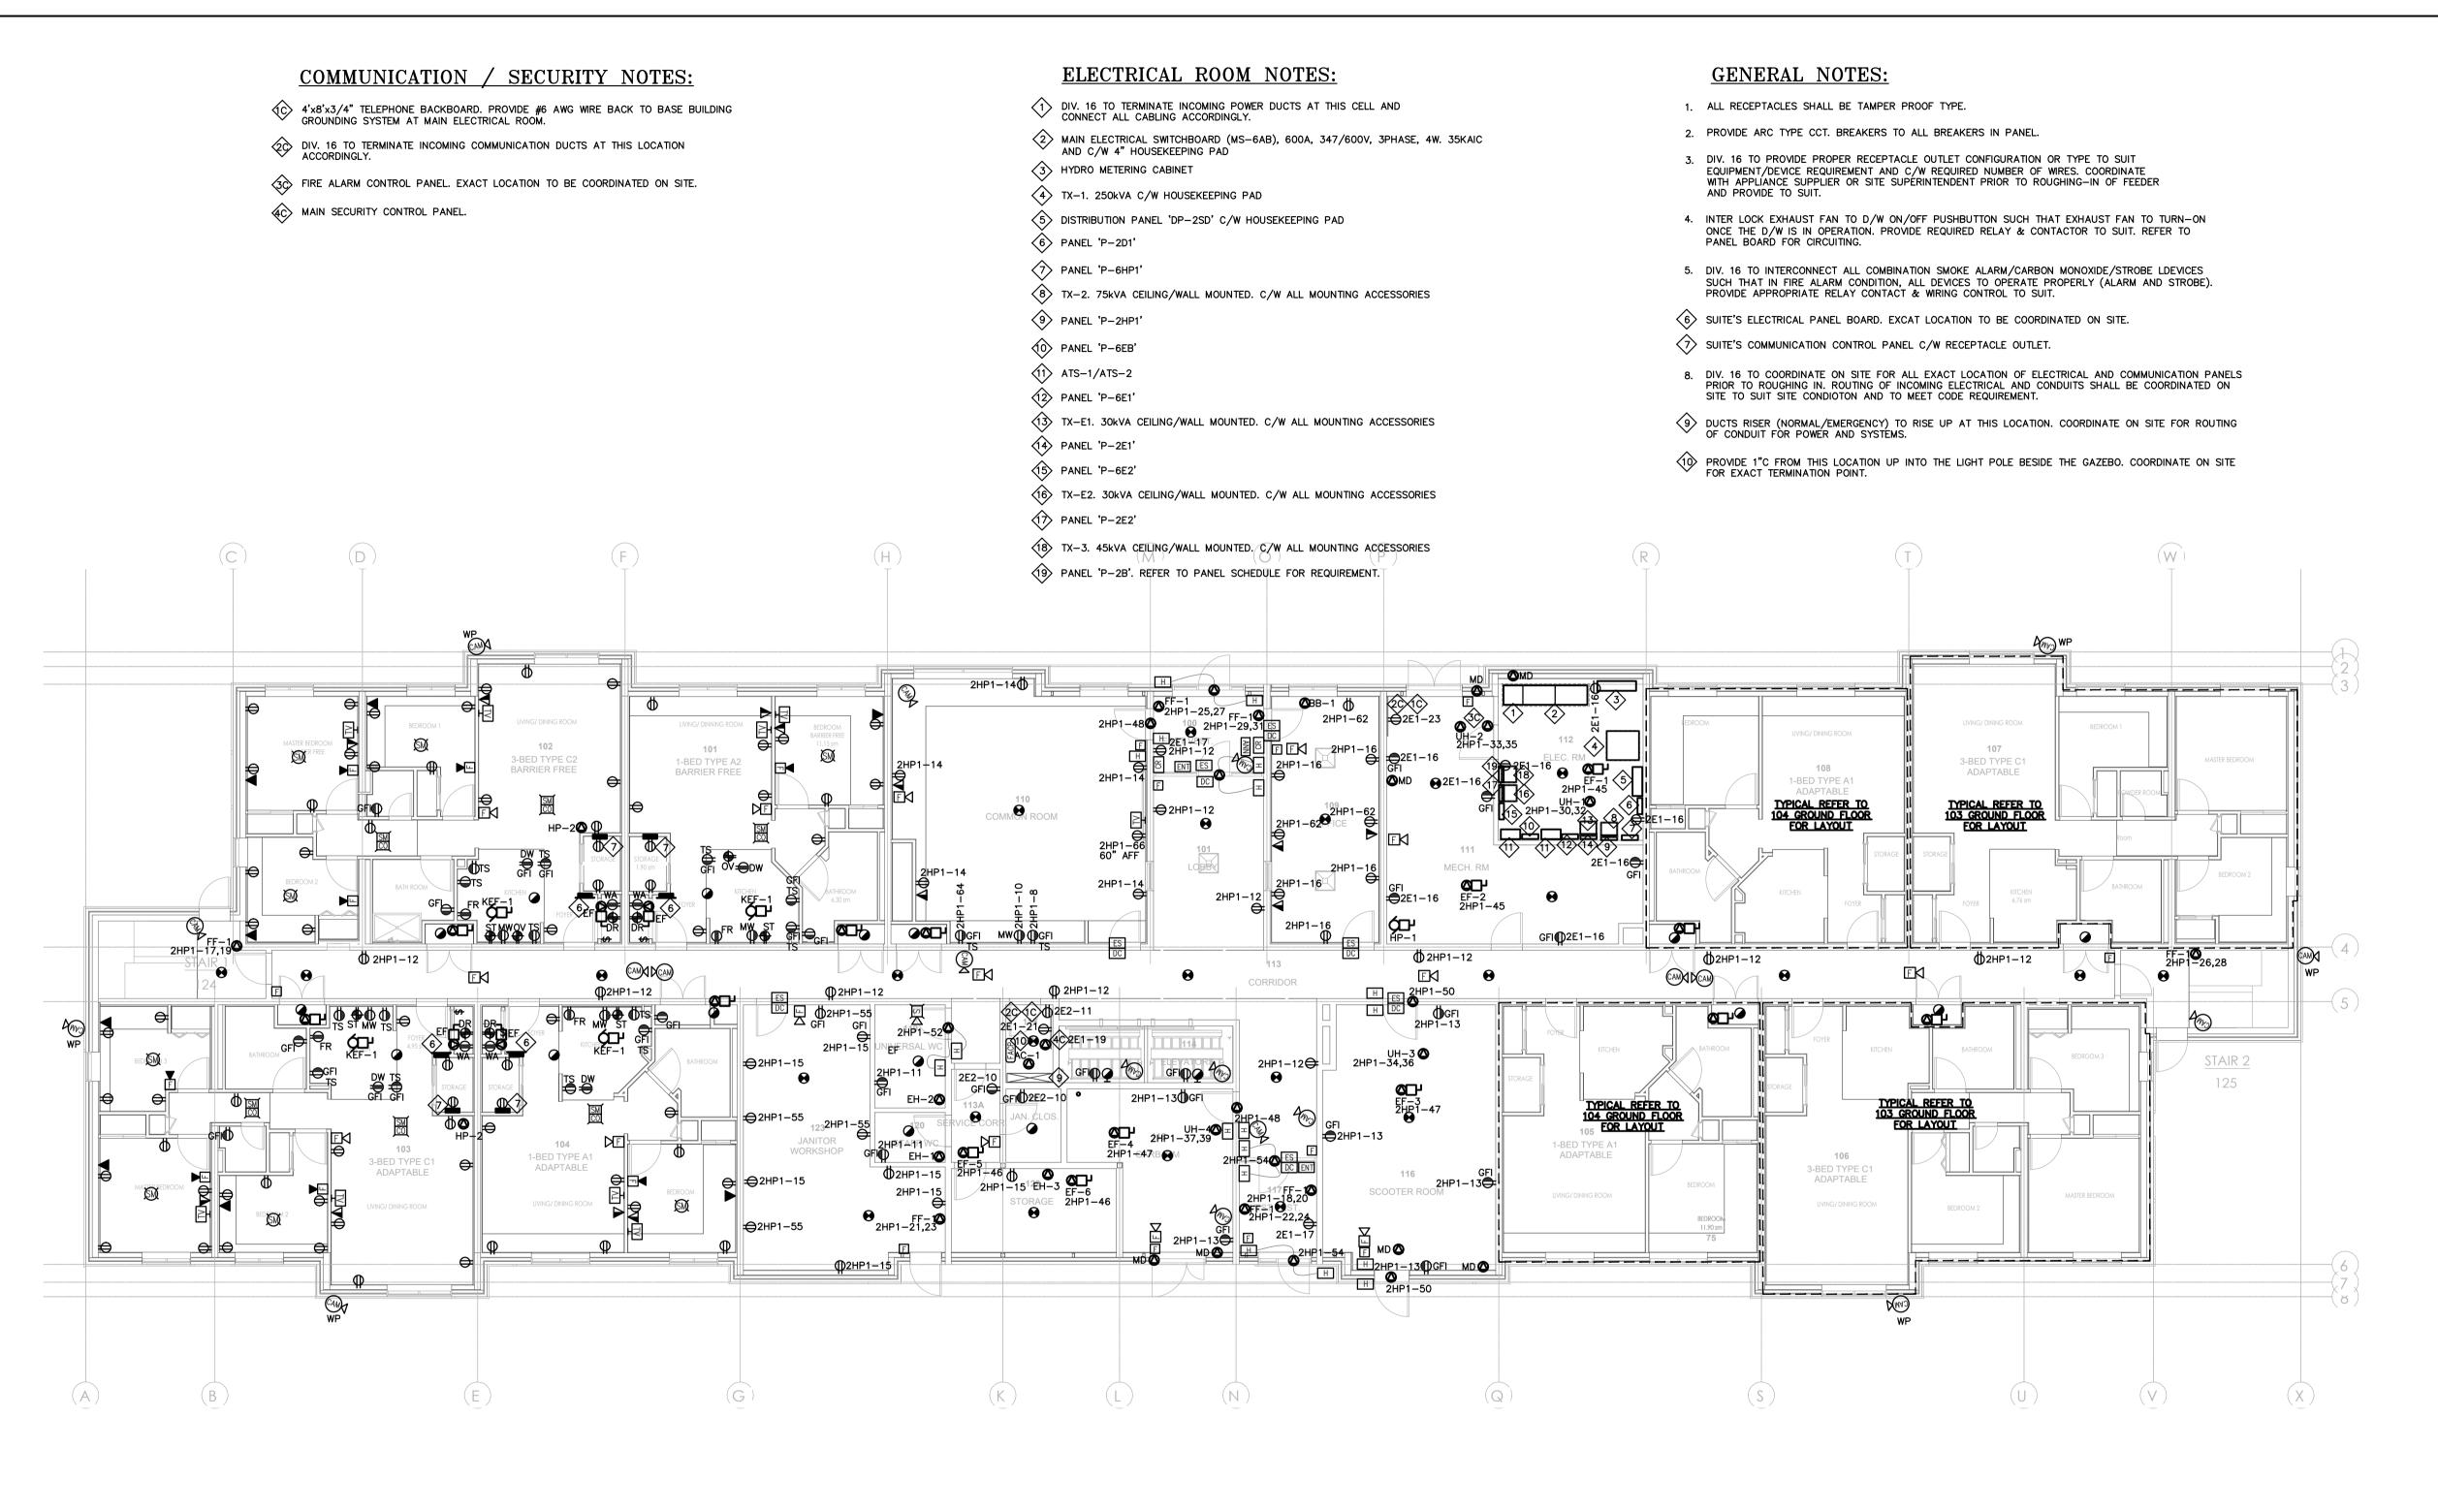


32 UNIT AFFORDABLE HOUSING APARTMENT BUILDING 20 SOUTH STREET, TRENTON, ON

City of Quinte West

ELECTRICAL GROUND FLOOR LIGHTING PLAN

Drawn DD/MU	Checked <b>BV</b>		
Date June 2023	Scale 1:100		
Project Number	Sheet Number		
23-019	E-200		





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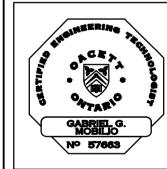
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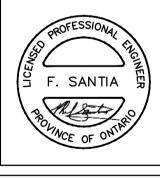
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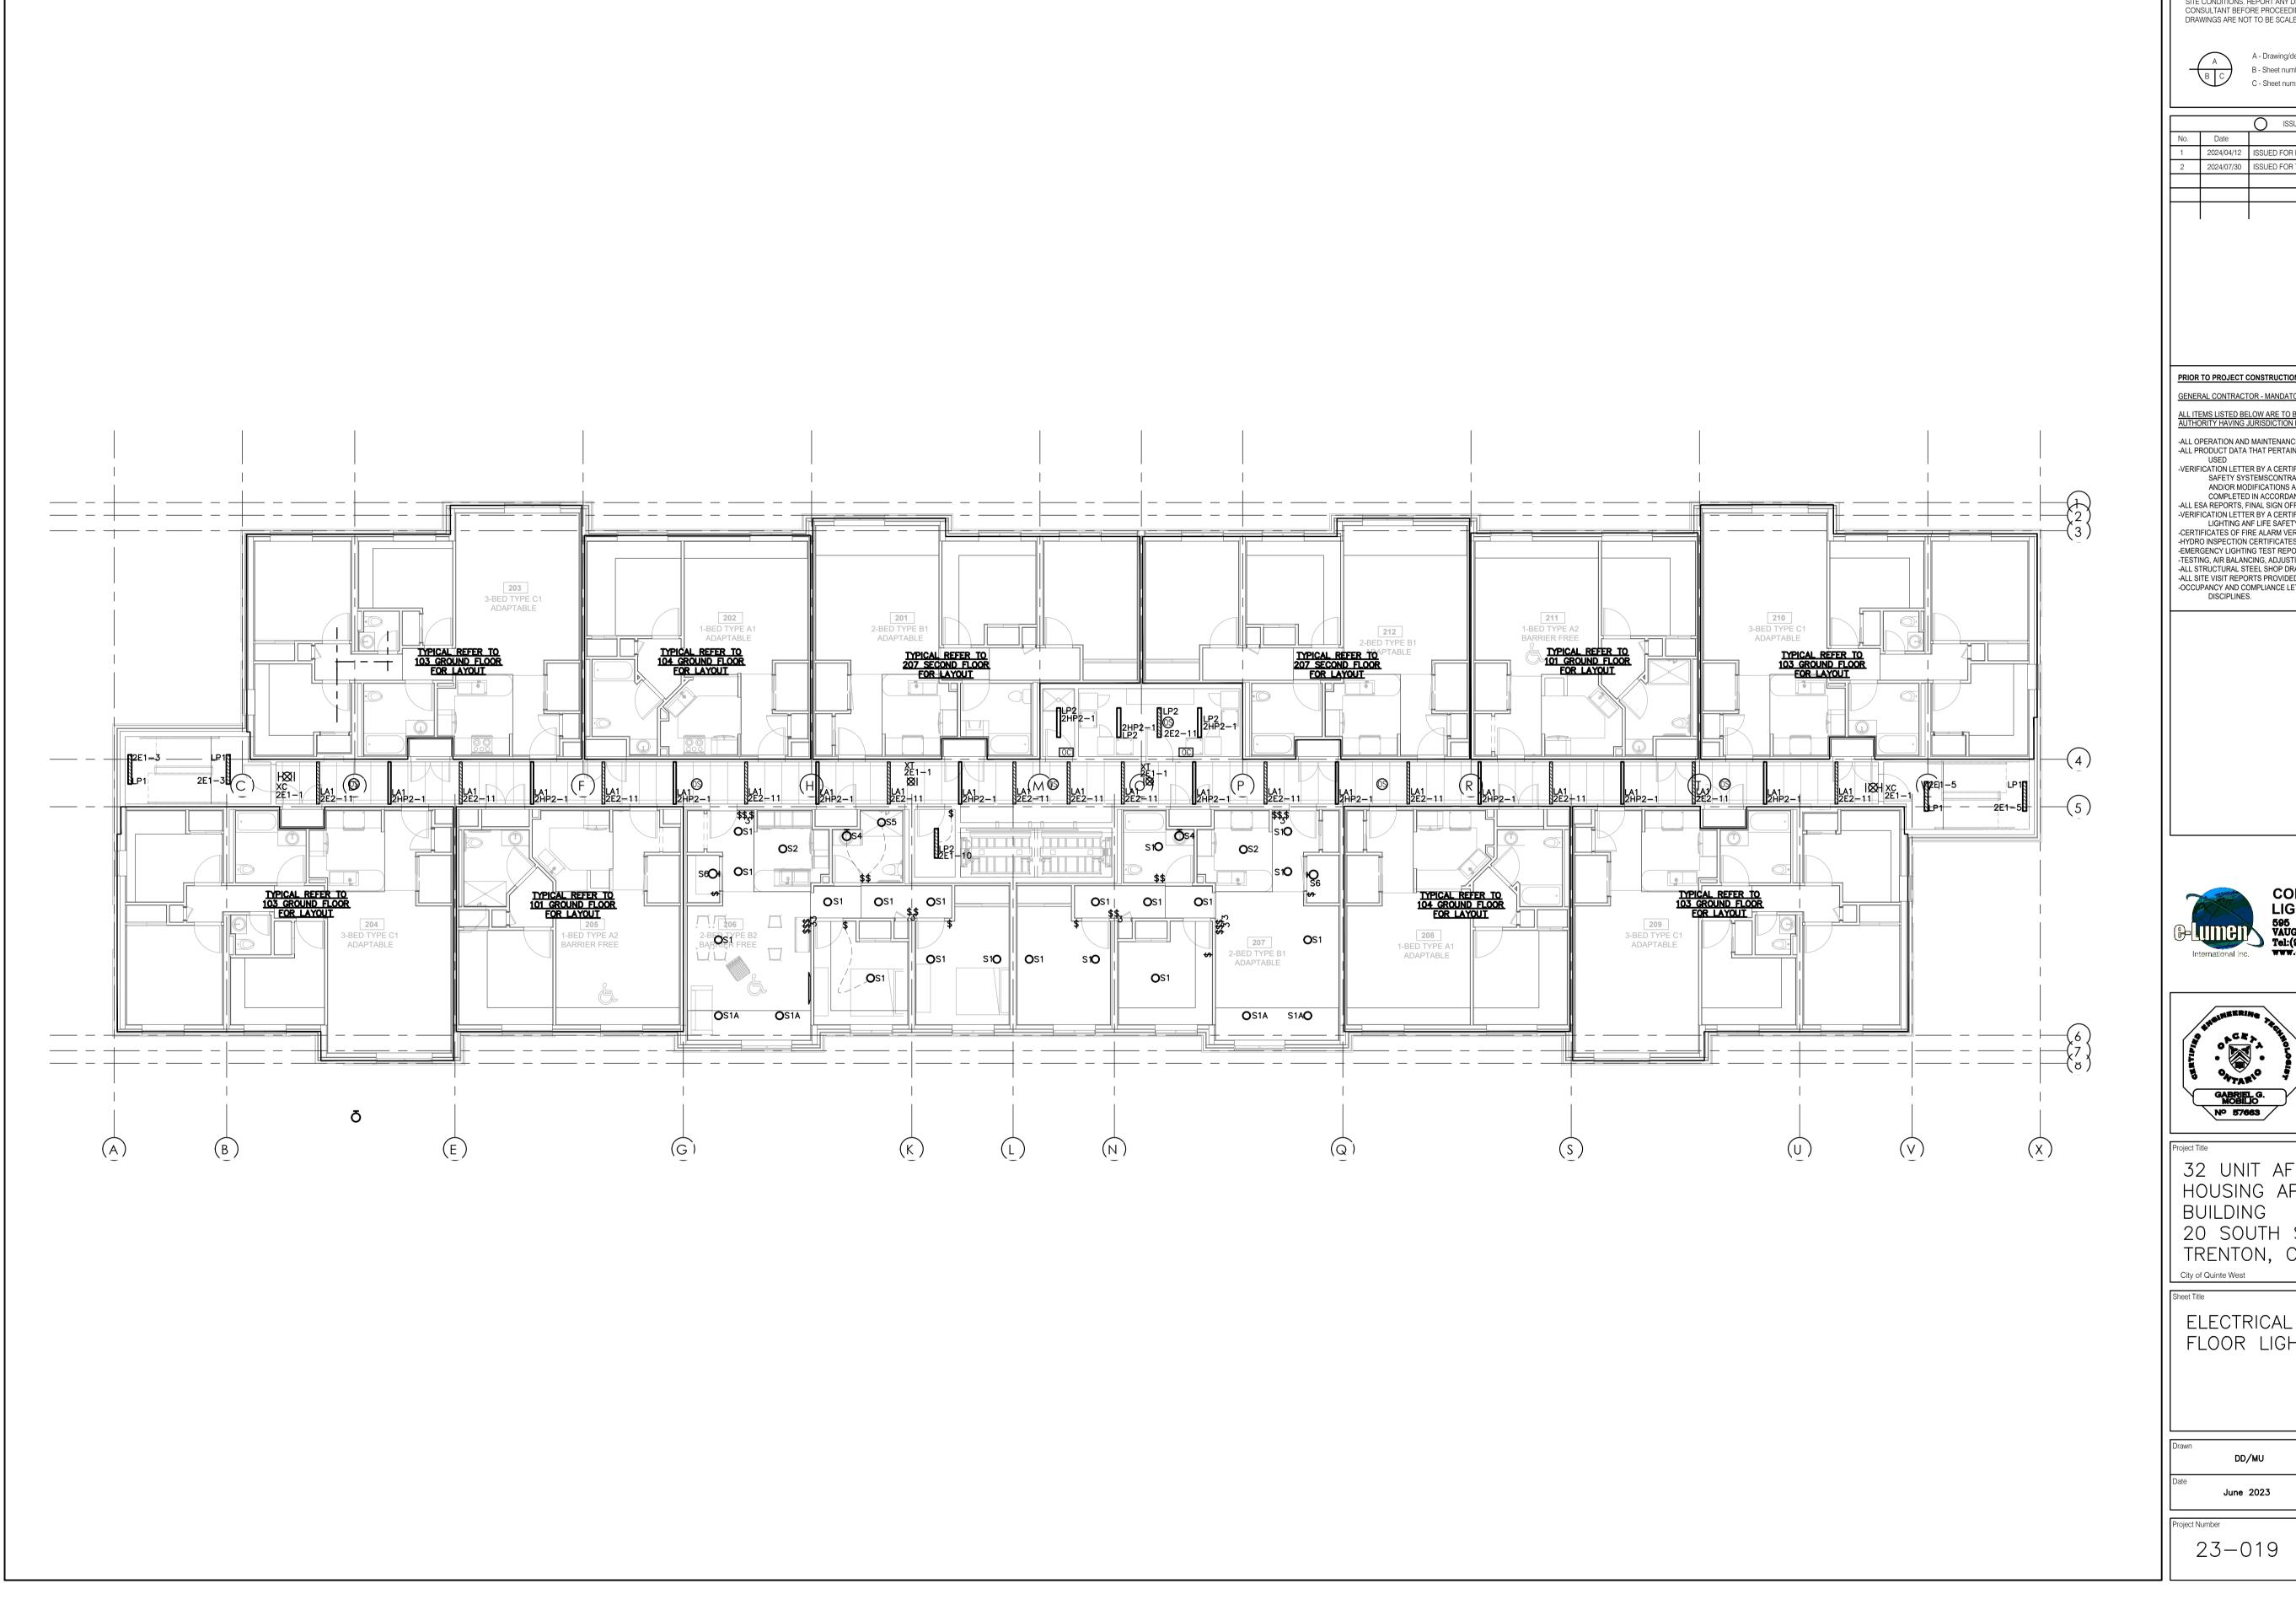
32 UNIT AFFORDABLE HOUSING APARTMENT BUILDING 20 SOUTH STREET, TRENTON, ON

City of Quinte West

Sheet Title

ELECTRICAL GROUND FLOOR POWER AND SYSTEMS PLAN

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Date June 2023	Scale 1:100
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23-019	E-201





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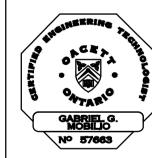
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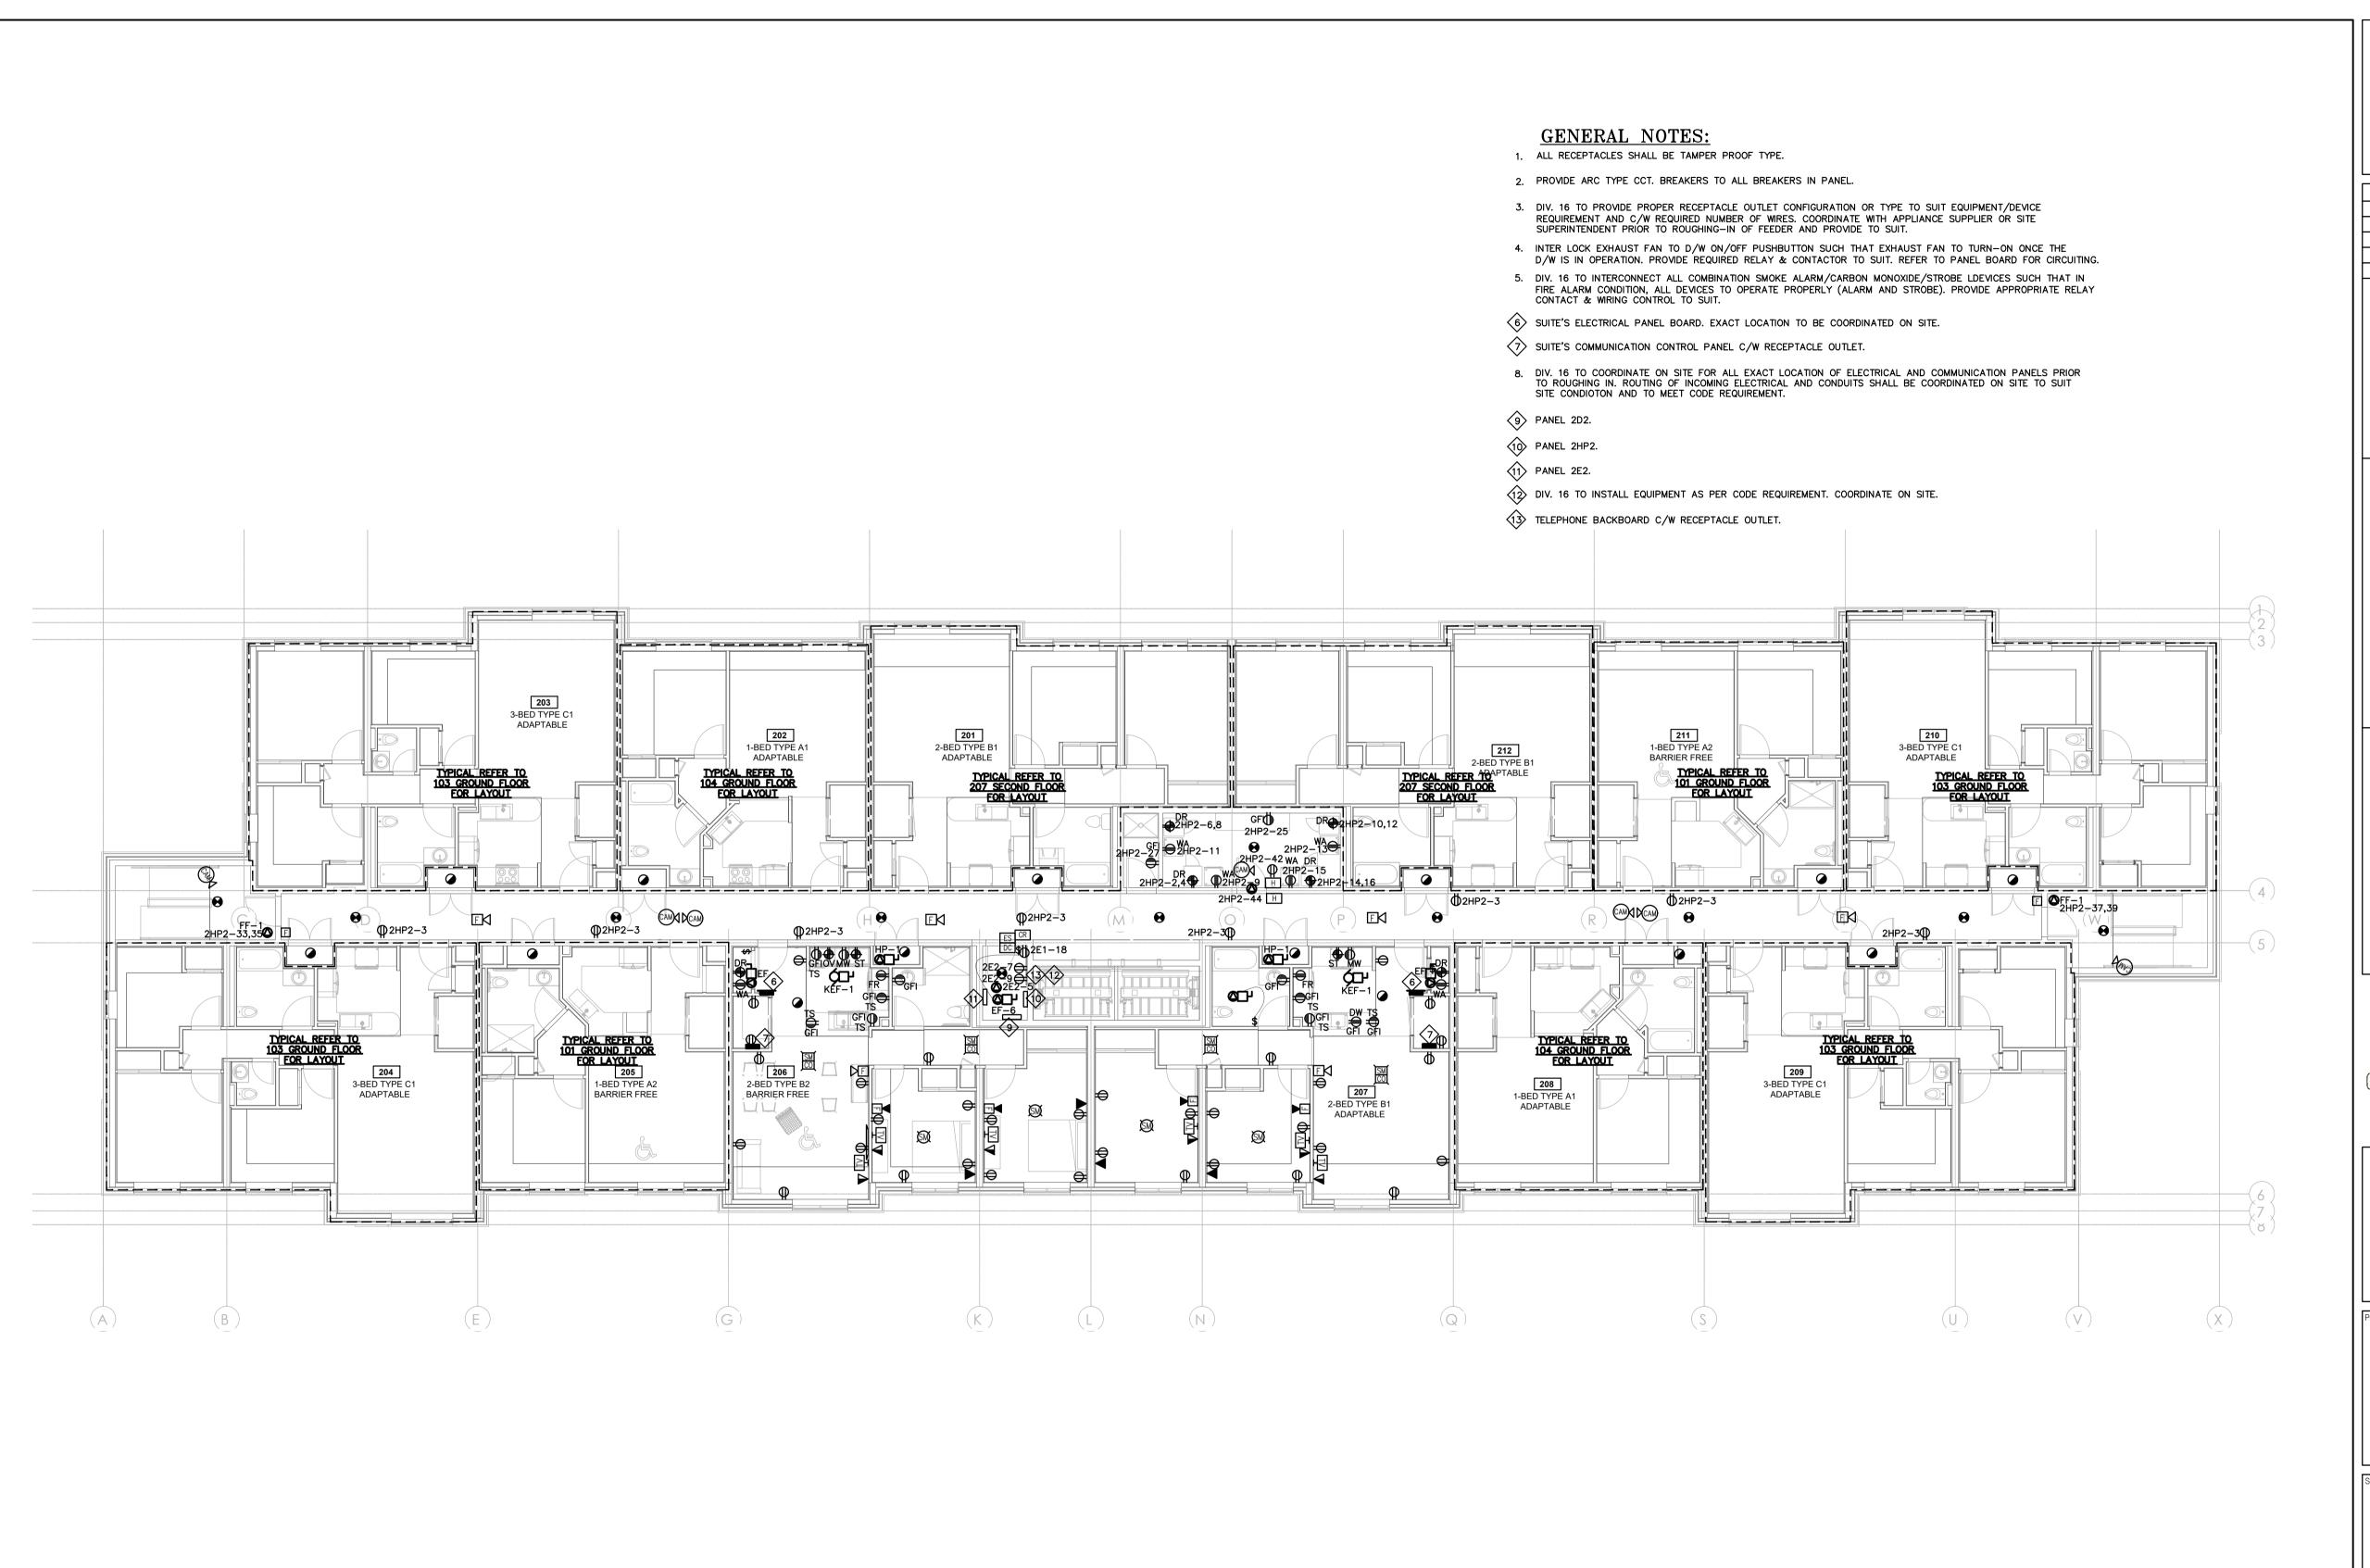


32 UNIT AFFORDABLE HOUSING APARTMENT BUILDING 20 SOUTH STREET, TRENTON, ON

City of Quinte West

ELECTRICAL SECOND FLOOR LIGHTING PLAN

Drawn DD/MU	Checked <b>BV</b>	
Date June 2023	Scale 1:100	
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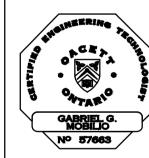
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32 UNIT AFFORDABLE HOUSING APARTMENT BUILDING 20 SOUTH STREET, TRENTON, ON

City of Quinte West


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ELECTRICAL SECOND FLOOR POWER AND SYSTEMS PLAN

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Date June 2023	Scale 1:100
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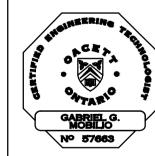
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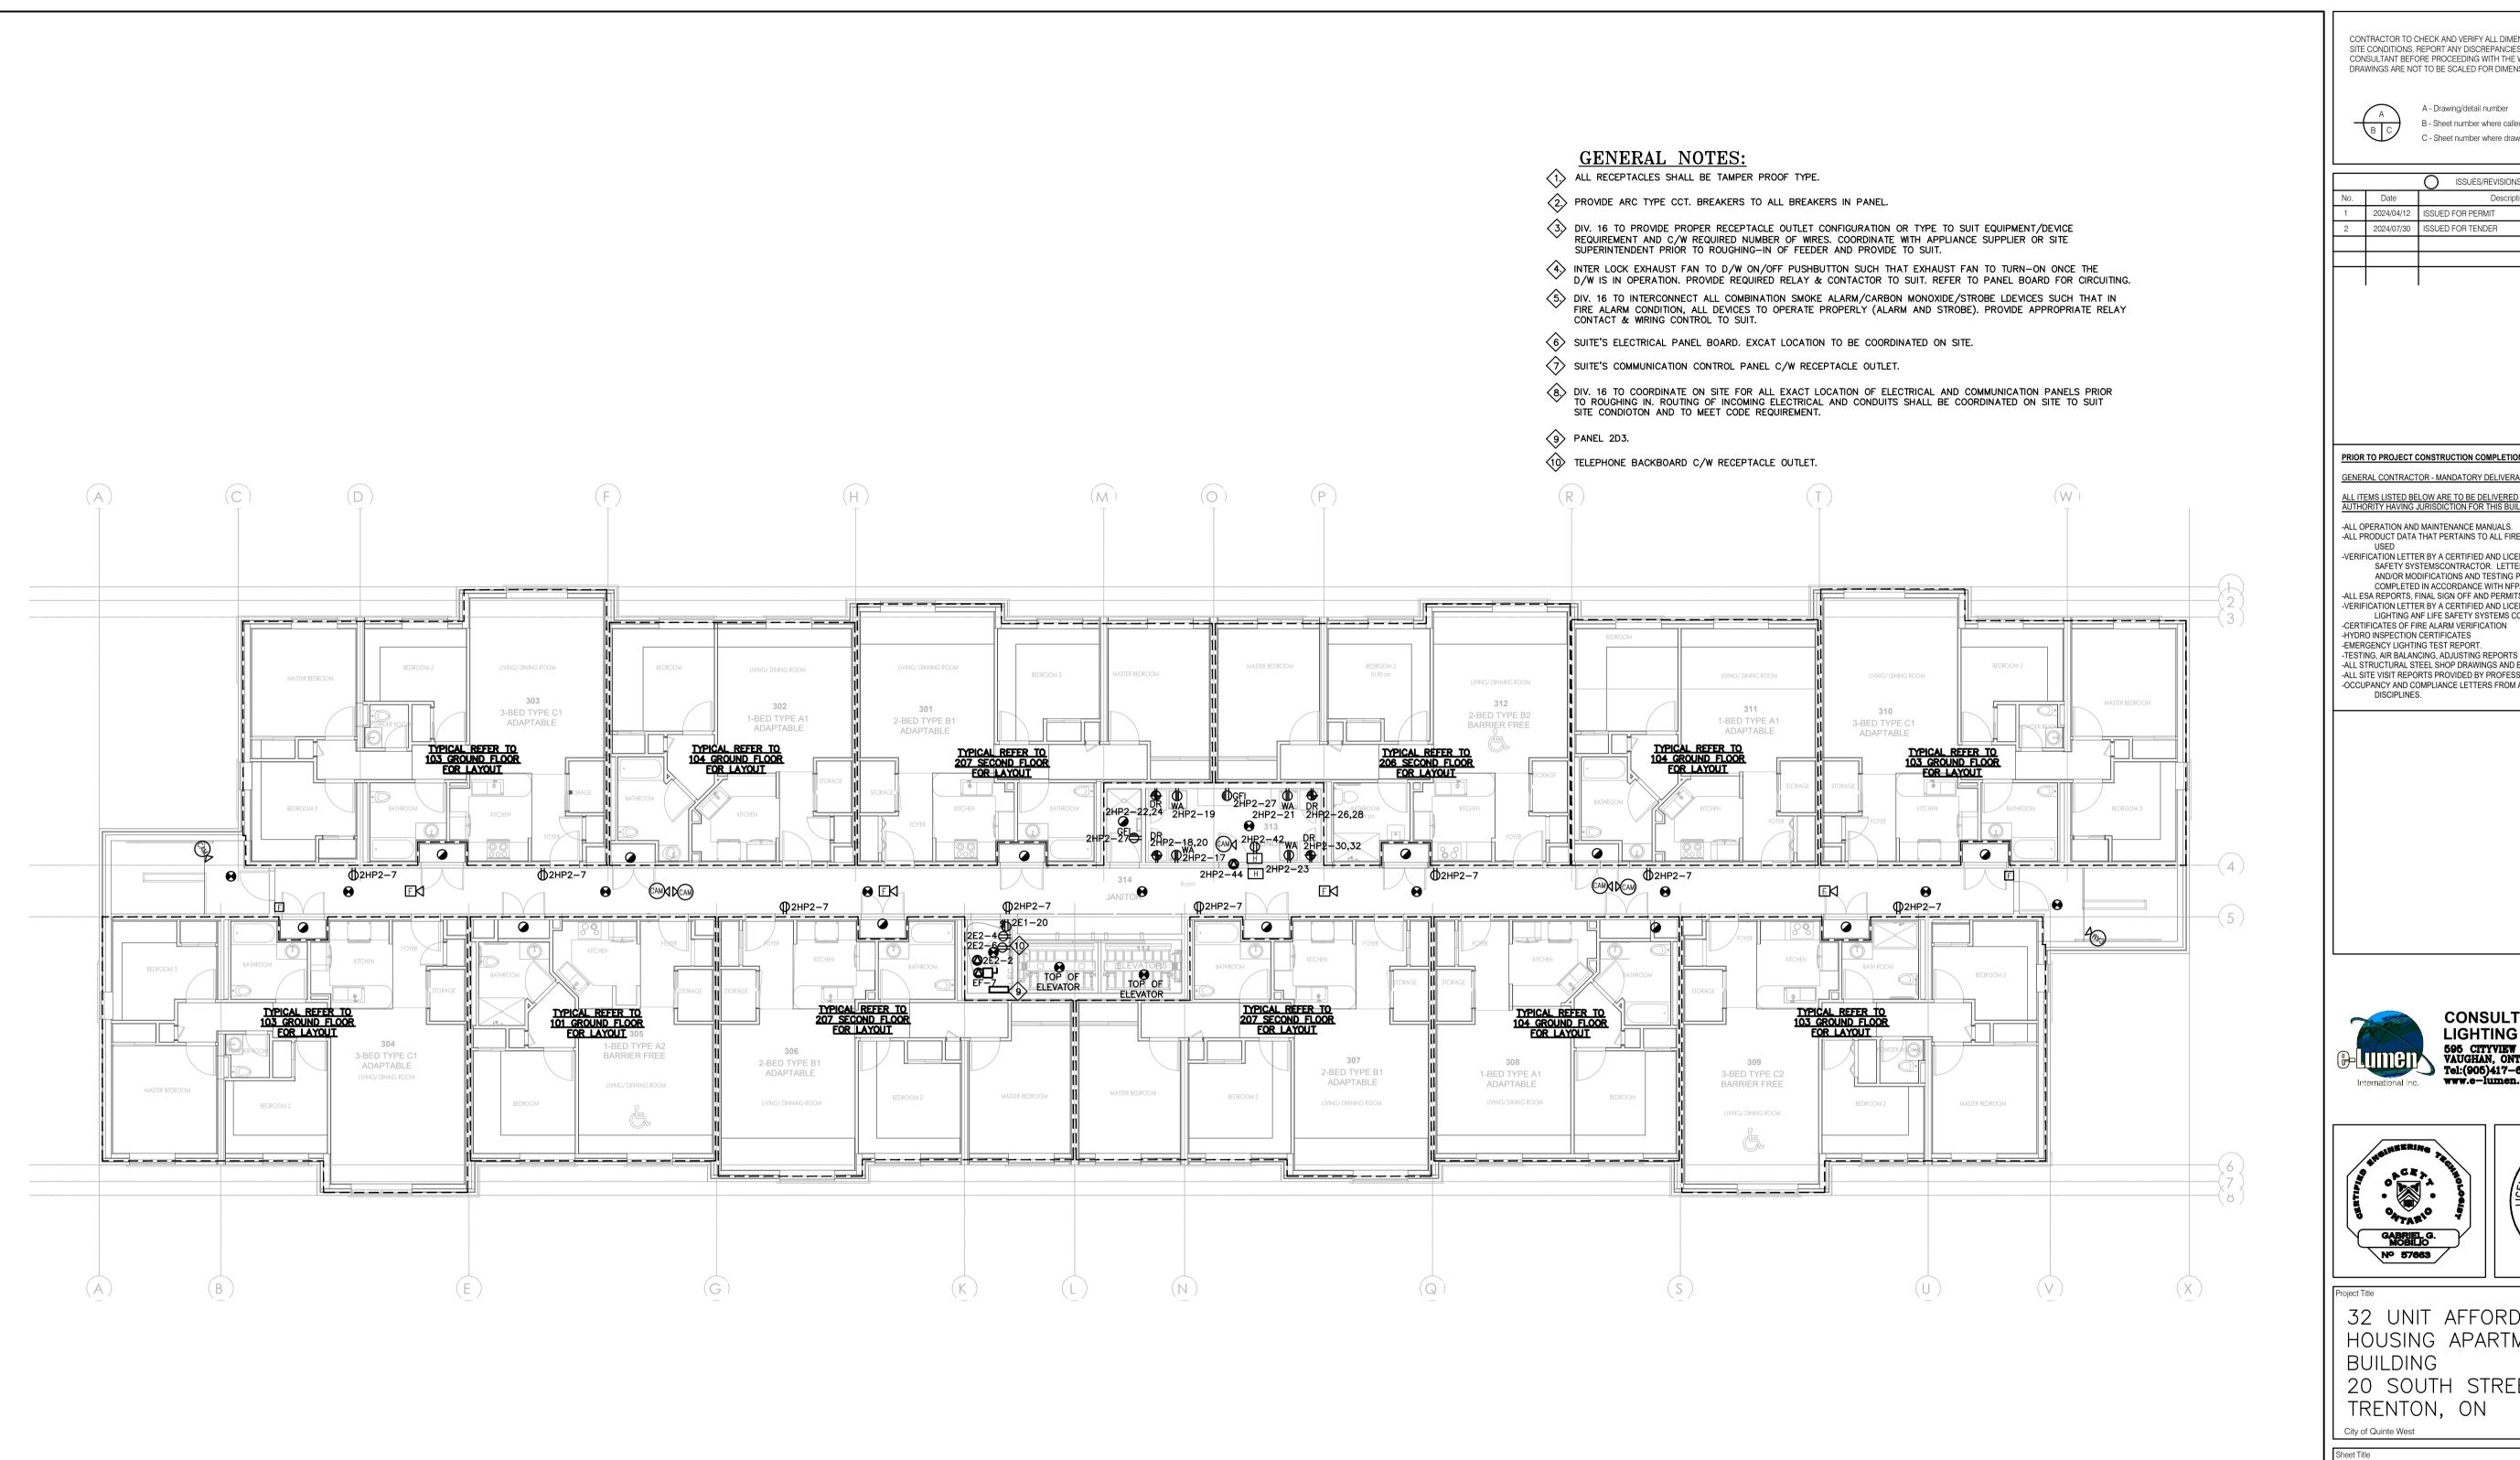


32 UNIT AFFORDABLE HOUSING APARTMENT BUILDING 20 SOUTH STREET, TRENTON, ON

City of Quinte West

ELECTRICAL THIRD FLOOR LIGHTING PLAN

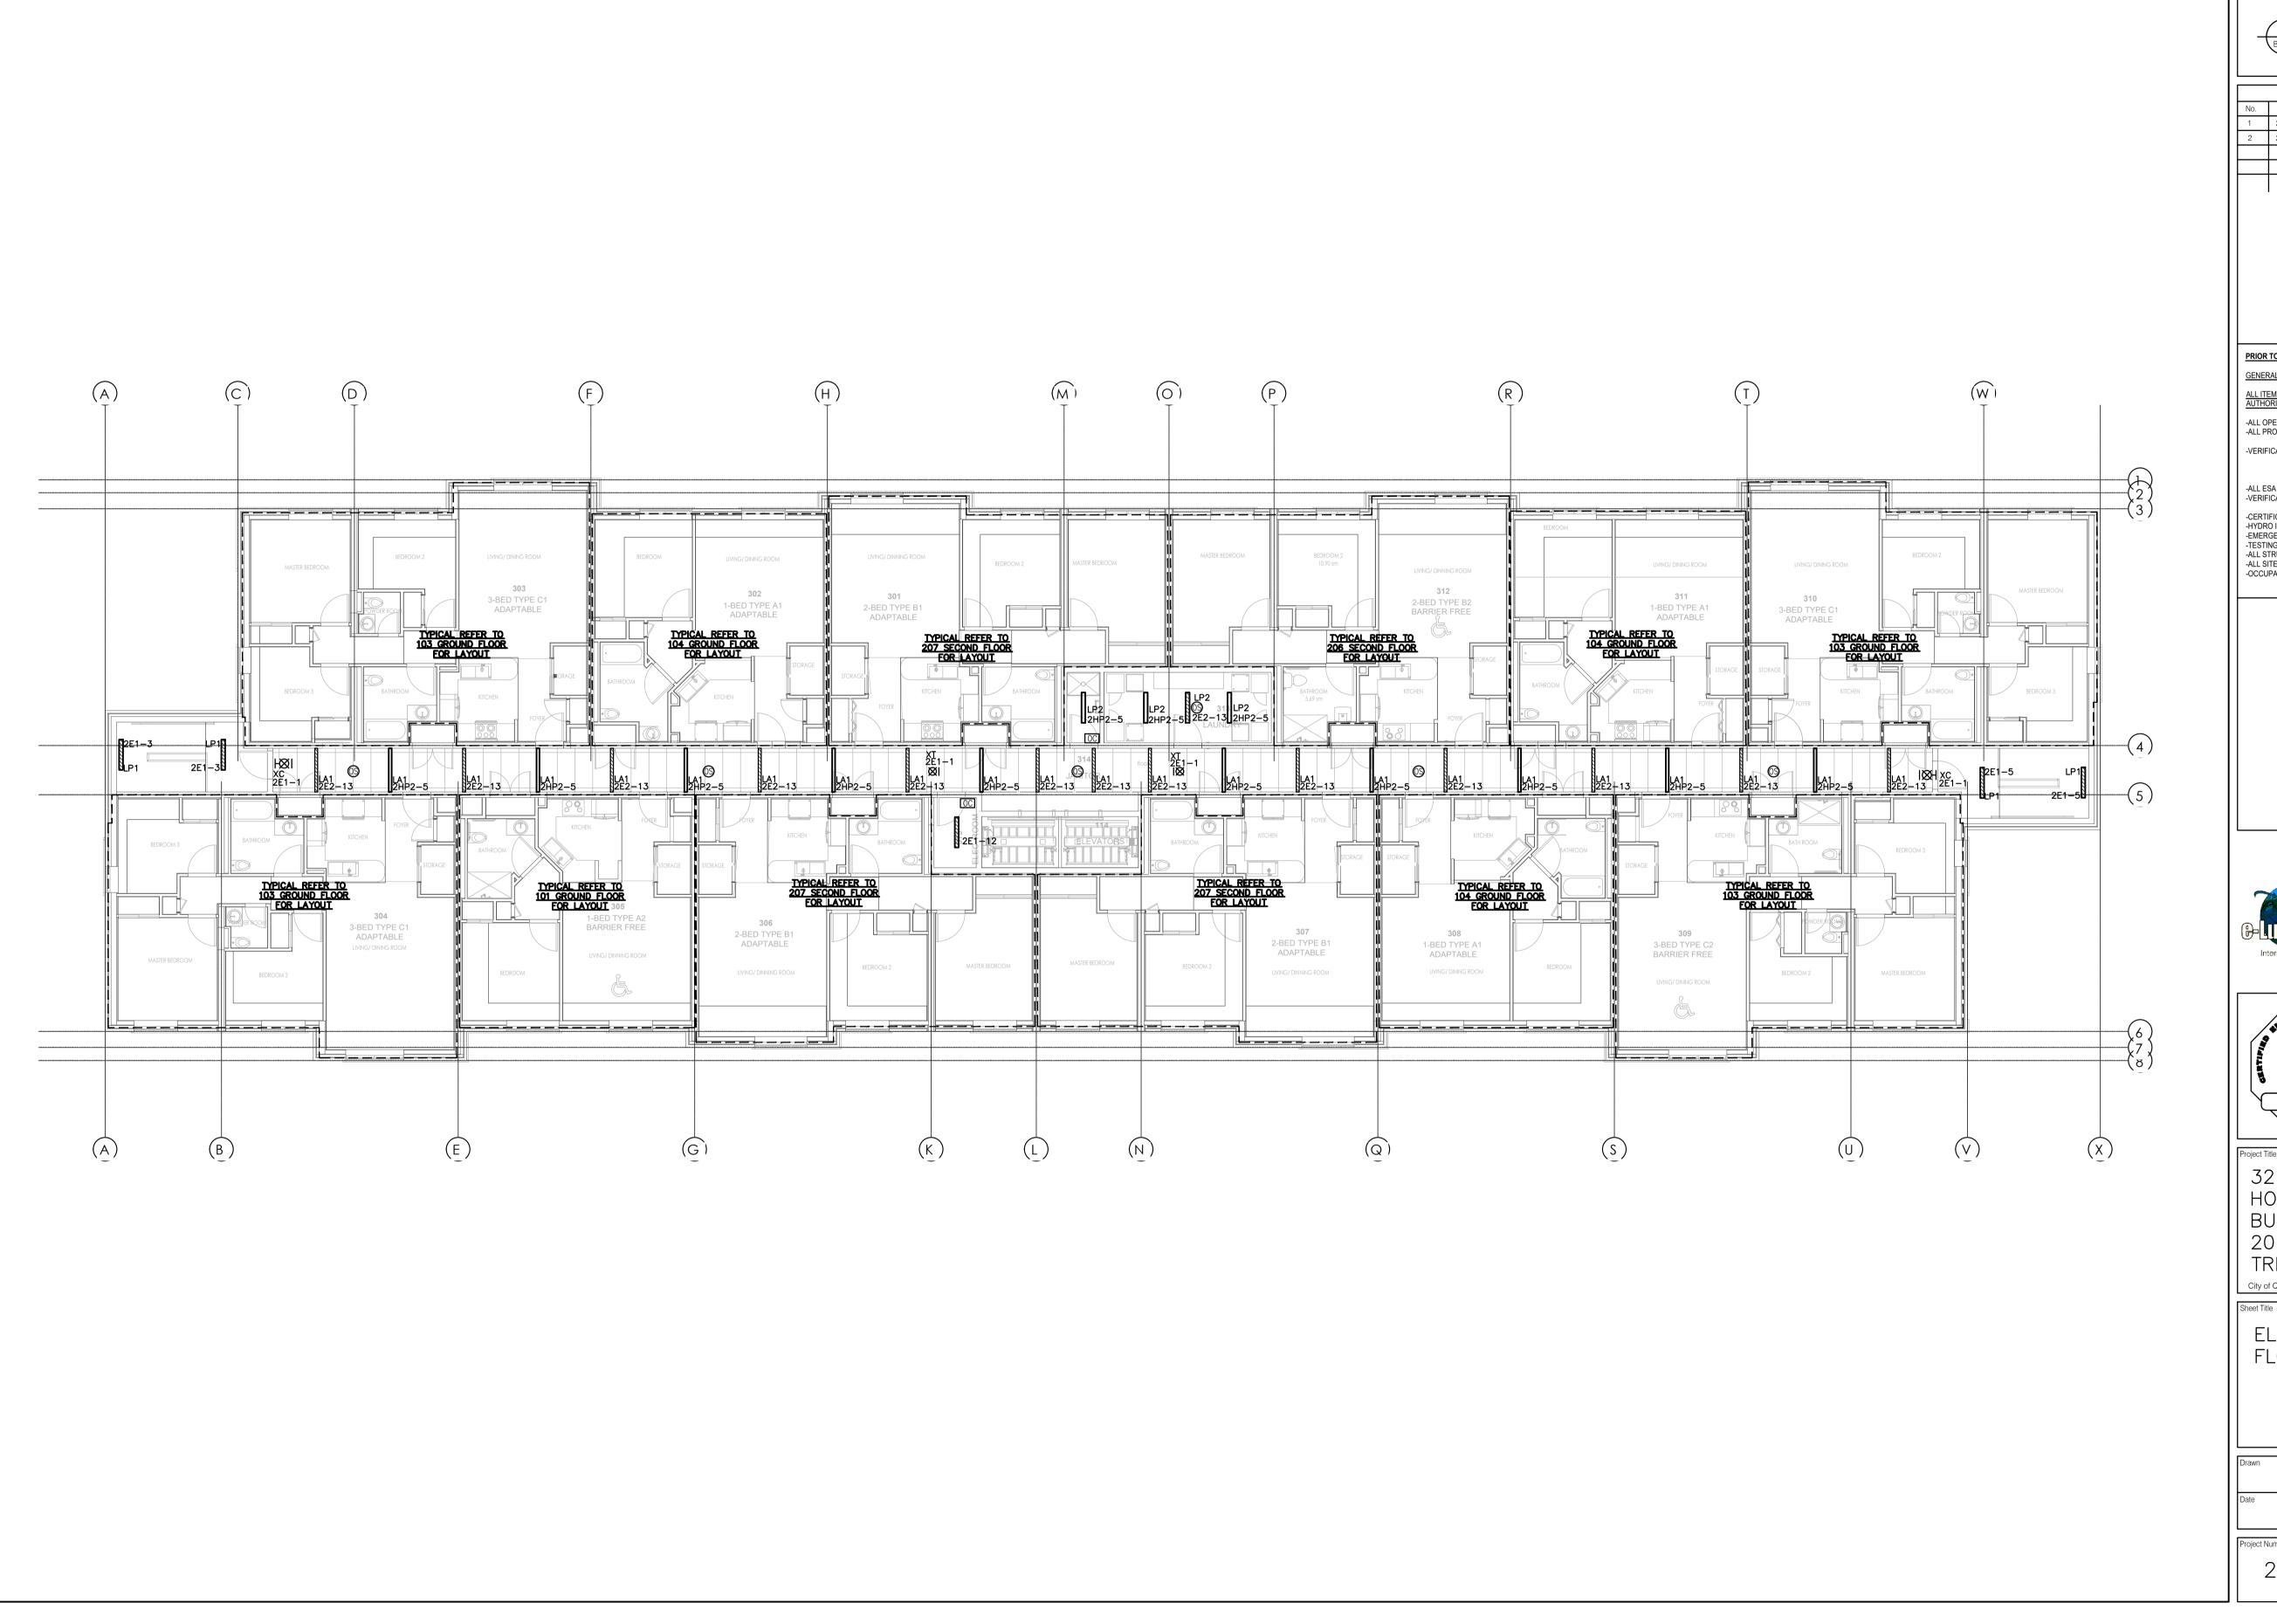Drawn DD/MU	Checked <b>BV</b>	
Date June 2023	Scale 1:100	
Project Number	Sheet Number	
23-019	E-400	



SITE CONDITIONS. REPORT ANY DISCREPANCIES TO THE CONSULTANT BEFORE PROCEEDING WITH THE WORK. DRAWINGS ARE NOT TO BE SCALED FOR DIMENSIONS.



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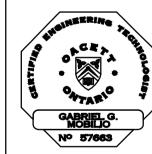
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32 UNIT AFFORDABLE HOUSING APARTMENT BUILDING 20 SOUTH STREET, TRENTON, ON

City of Quinte West

ELECTRICAL THIRD FLOOR POWER AND SYSTEMS PLAN


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Date June 2023	Scale 1:100
Project Number	Sheet Number
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- APPROXIMATE LOCATION OF ROOF MOUNTED EMERGENCY OUTDOOR GENERATOR UNIT. GENERATOR UNIT SHALL BE C/W VIBRATION ISOLATORS AND REQUIRED 6" HOUSEKEEPING PAD TO SUIT MANUFACTURER REQUIREMENTS. INSTALL GENERATOR TO SUIT SITE CONDITION AND TO MEET CODE REQUIREMENT.
- REFER TO SINGLE LINE AND PANELBOARD FOR ELECTRICAL REQUIREMENT AND CONNECTION.
- EXACT LOCATION TO BE COORDINATED ON SITE TO SUIT SITE CONDITION AND INSTALL ACCORDINGLY.
- TO BE CONTROLLED BY LIGHTING SWITCH LOCATED AT 3RD FLOOR ELECTRICAL FLOOR.





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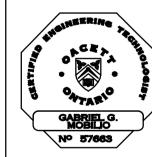
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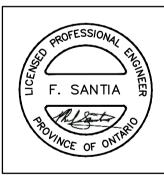
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Project Tit

32 UNIT AFFORDABLE
HOUSING APARTMENT
BUILDING
20 SOUTH STREET,
TRENTON, ON

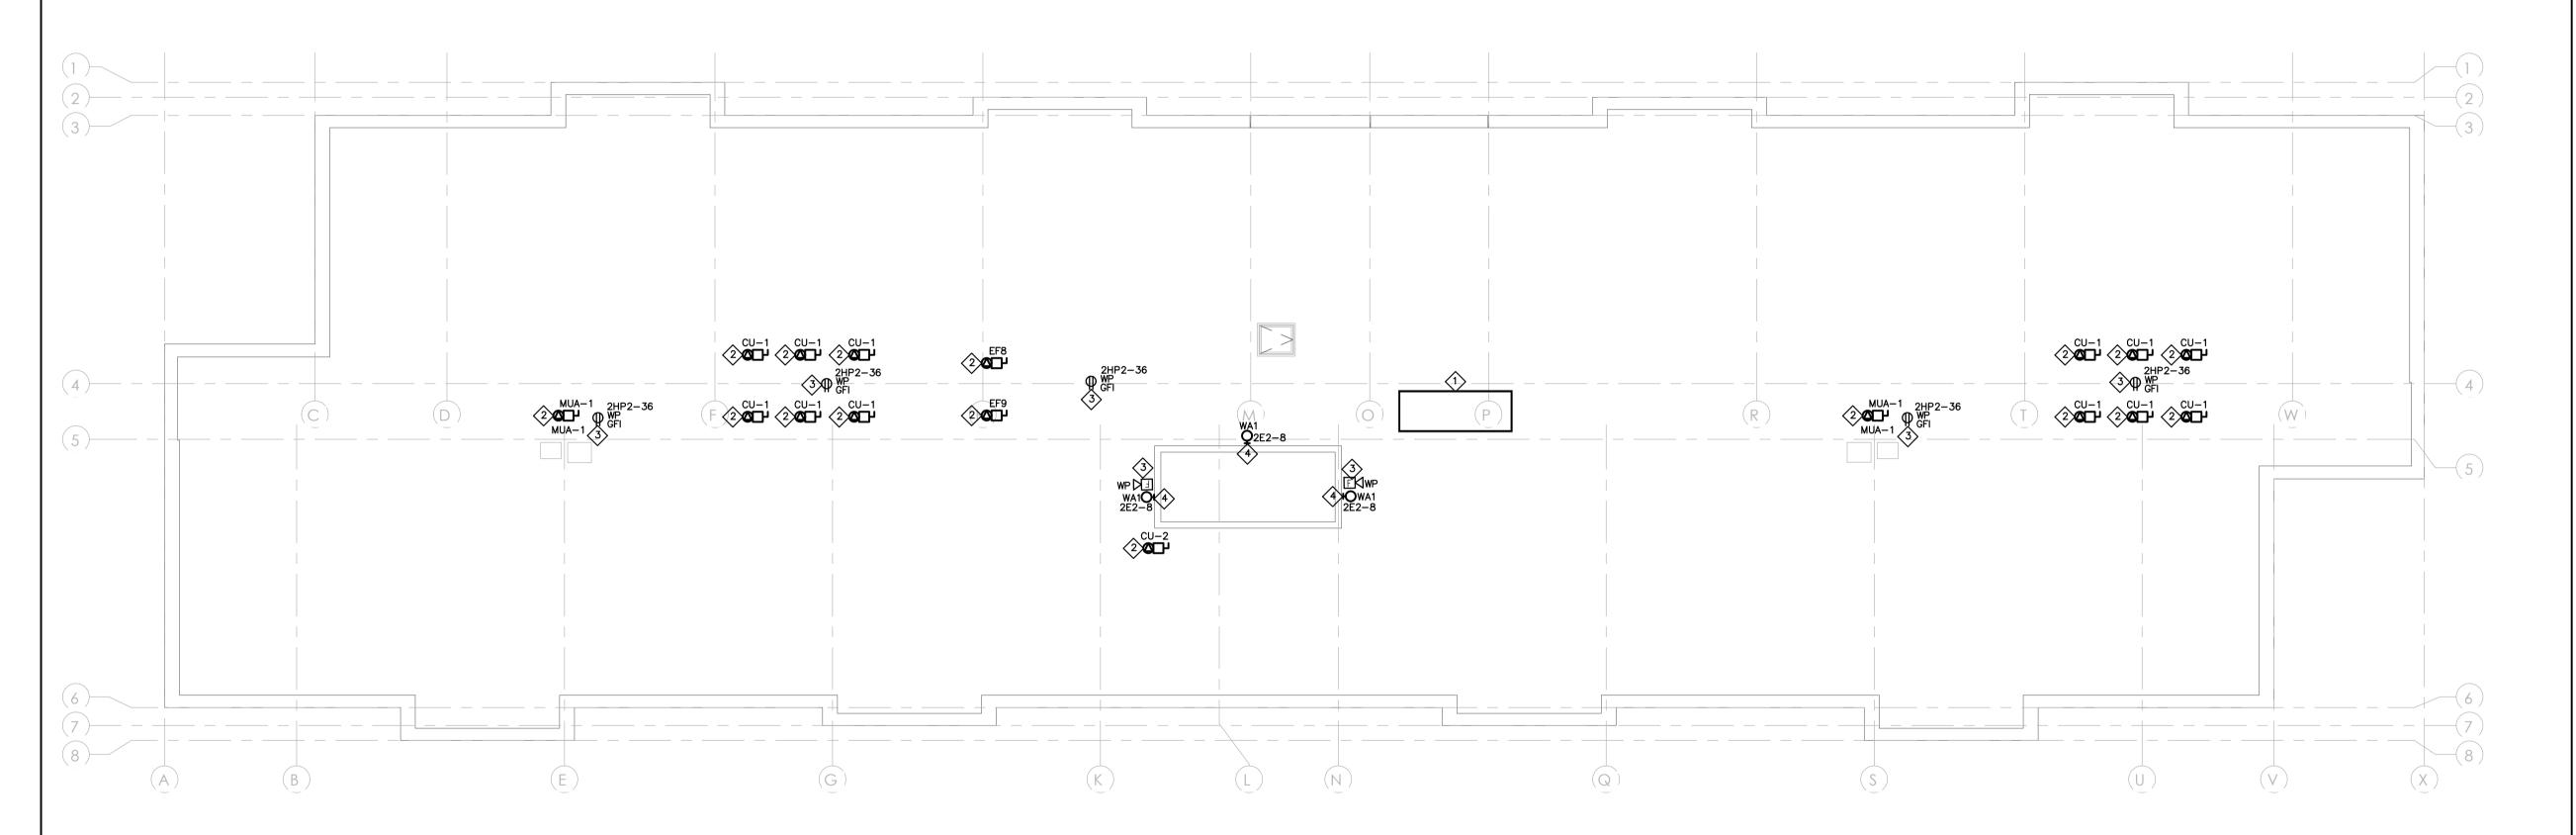City of Quinte West


Sheet Title

ELECTRICAL ROOF FLOOR PLAN

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Date June 2023	Scale	
Project Number	Sheet Number	
23-019	E-500	



- 100kW/125kVA OUTDOOR NATURAL GAS GENERATOR UNIT C/W 150A-3P (T.D. TYPE), 600V MAIN BREAKER. 347/600V, 4W, 3Ø C/W SOUND ATTENUATED WEATHERPROOF ENCLOSURE. DISTRIBUTION PANEL, 120/208V, 3W, SINGLE PHASE, 125A, 24 CIRCUITS CAPACITY AND C/W 70A-2P MAIN BREAKER. GENERATOR SHALL BE C/W CONTROL PANEL, BATTERY, HEATERS, 125A, 120/208V PANELBOARD, RECEPTACLE OUTLET, LIGHTING LUMINAIRE, VIBRATION ISOLATORS, ETC. PROVIDE 3 #4 + GND.-1"C AT THIS GENERATOR LOCATION UP TO REQUIRED DIST. PANEL LOCATION TO SUIT ELECTRICAL CONNECTION. PROVIDE ADDITIONAL 3-1"C UP TO ELECTRICAL ROOM and TO APPROPRIATE LOCATION TO SUIT CODE REQUIREMENT.
- 100A-3P, 3PHASE, 4W 600V, 3Ø TRANSFER SWITCH, C/W BY-PASS SWITCH TO SUIT CODE REQUIRTEMENT.

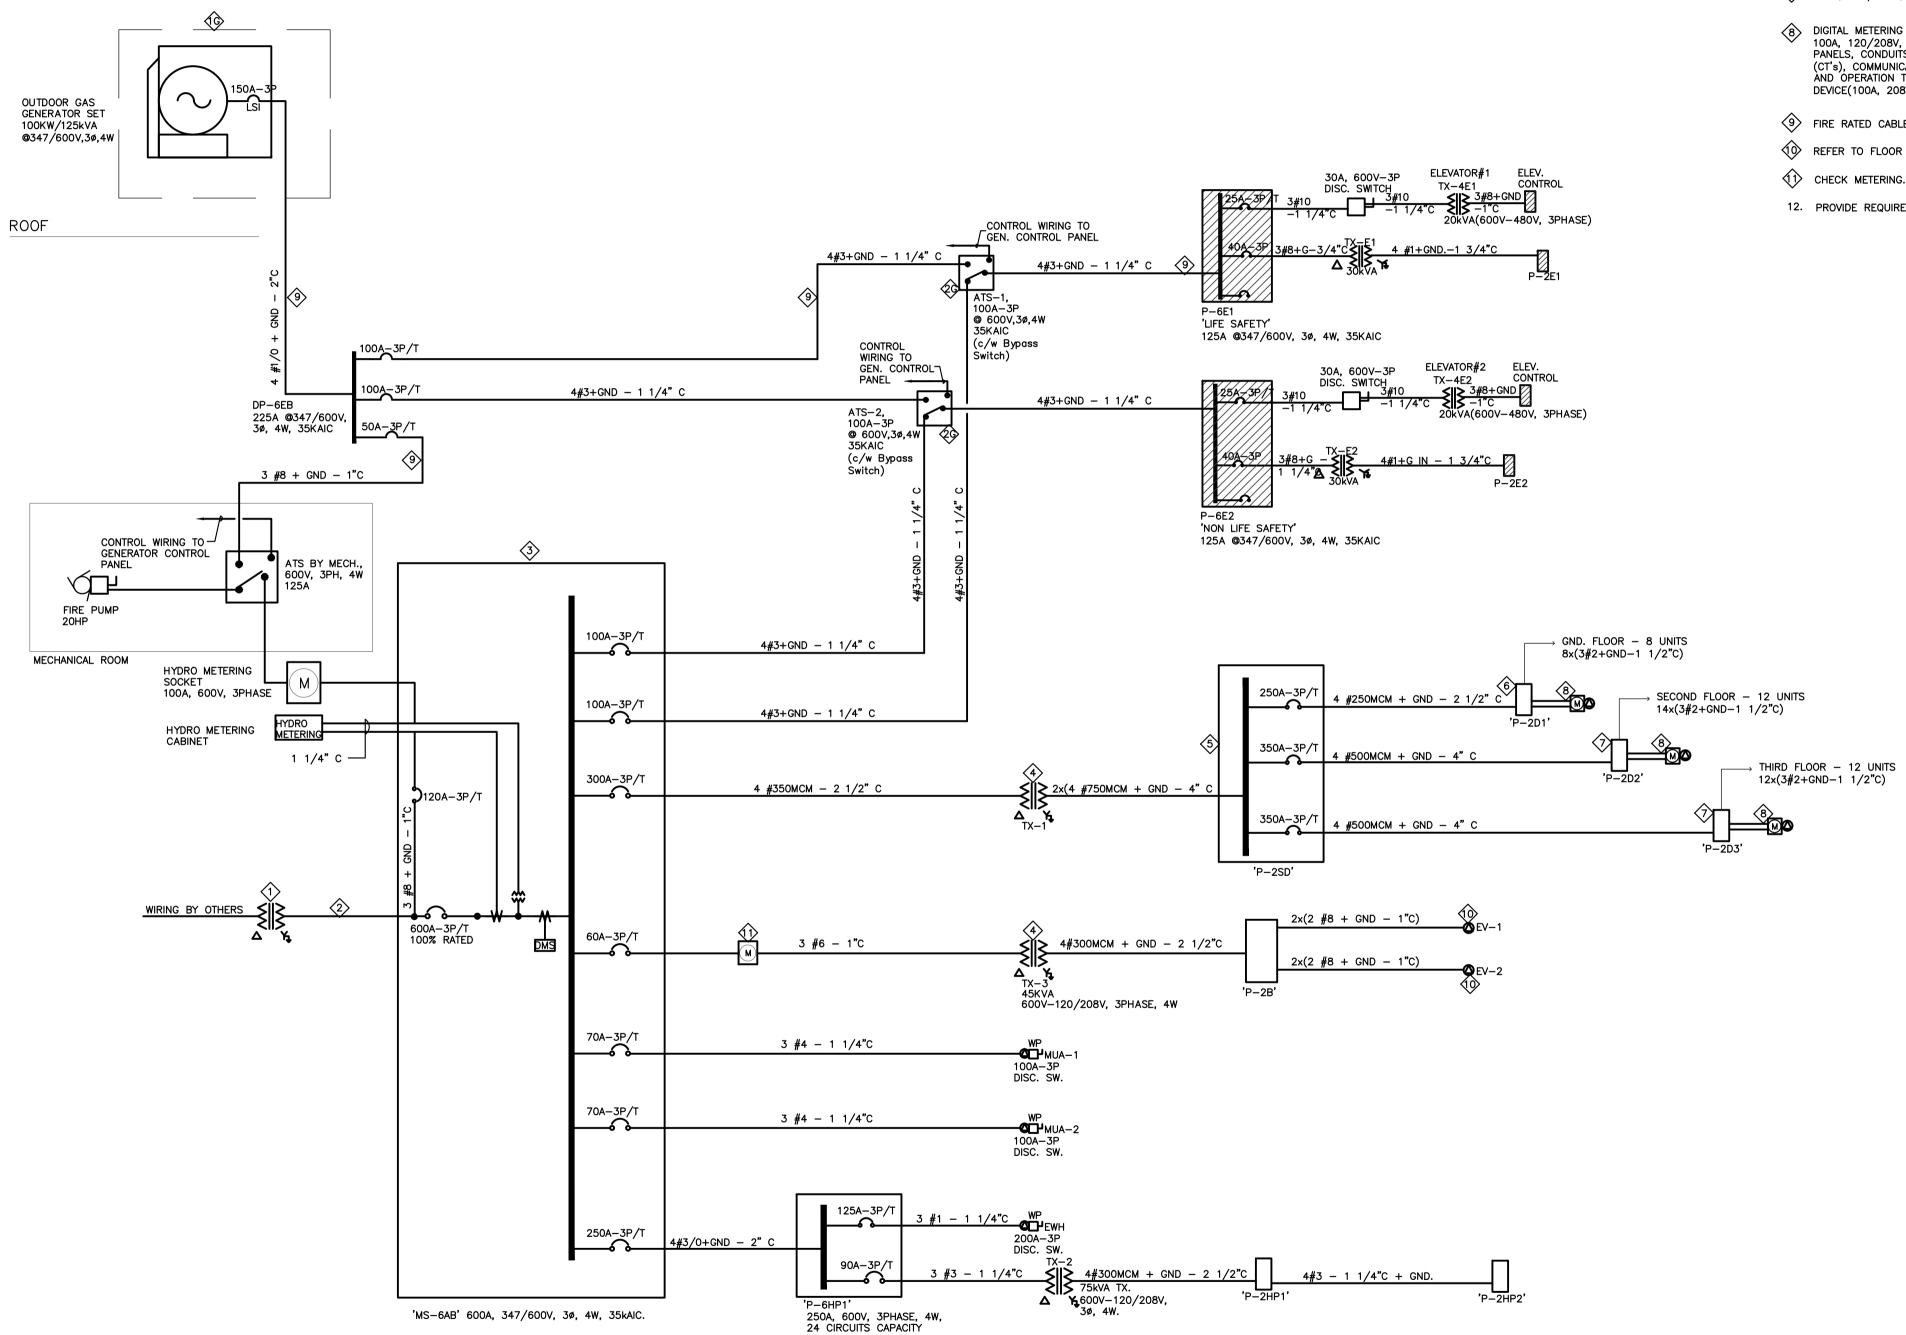

## DIAGRAM NOTES:

- HYDRO OUTDOOR PAD MOUNTED TRANSFORMER BY OTHERS. REFER TO SITE PLAN FOR DETAILS.
- $\langle 2 \rangle$  UNDERGROUND SECONDARY WIRING 2x(4#500MCM AL-4"C).
- MAIN SWITCHBOARD 'MS-6AB' 600A, 347/600V, 3ø, 4W, 35kAIC. REFER TO FLOOR PLAN FOR LAYOUTS.
- 4 TX-1, 250kVA TRANSFORMER 600-120/208V, 3ø, 4W.
- 5 SUITE'S MAIN DISTRIBUTION BOARD. 1000A, 120/208V, 3ø, 4W, 50kAIC.
- 6 250A, 120/208V, 3ø, 4W SUITE'S DISTRIBUTION PANELBOARD. 42 CIRCUITS CAPACITY.
- 400A, 120/208V, 3ø, 4W SUITE'S DISTRIBUTION PANELBOARD. 42 CIRCUITS CAPACITY.
- 8 DIGITAL METERING SYSTEM QUADLOGIC/CARMA PANEL CONTROL SYSTEM. 100A, 120/208V, 10, 3W SYSTEM. DIVISION 16 TO INSTALL C/W ALL REQUIRED PANELS, CONDUITS, CONTROL WIRING, AC CIRCUITS, CURRENT TRANSFORMERS (CT's), COMMUNICATION AND OTHER ACCESSORIES FOR A COMPLETE INSTALLATION AND OPERATION TO SUIT. ELECTRICAL CONTRACTOR TO PROVIDE REQUIRED AMMETER DEVICE(100A, 208V) SYSTEM WITHIN SUITES DISTRIBUTION BOARD.
- 9 FIRE RATED CABLE, AS PER CODE REQUIREMENT. I HR MIN.
- REFER TO FLOOR PLAN FOR LOCATION AND REQUIREMENT TO SUIT.
- The check metering. 600V, 100A, 3PHASE.
- 12. PROVIDE REQUIRED COORDINATION AND GROUNDING STUDIES.

CONTRACTOR TO CHECK AND VERIFY ALL DIMENSIONS AND SITE CONDITIONS. REPORT ANY DISCREPANCIES TO THE CONSULTANT BEFORE PROCEEDING WITH THE WORK. DRAWINGS ARE NOT TO BE SCALED FOR DIMENSIONS.



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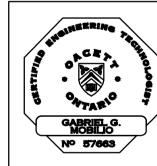
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**CONSULTING ENGINEERS LIGHTING - ELECTRICAL** 595 CITYVIEW BLVD, SUITE 204/205 VAUGHAN, ONTARIO, CANADA L4H 3M7 Tel:(905)417-6881 Fax:(905)417-6882 www.e-lumen.ca





32 UNIT AFFORDABLE HOUSING APARTMENT BUILDING 20 SOUTH STREET, TRENTON, ON

City of Quinte West

ELECTRICAL SINGLE LINE DIAGRAM

Drawn DD/MU	Checked <b>BV</b>
Date June 2023	Scale N.T.S
Project Number	Sheet Number
23-019	E-600

#### **NOTES**

- ALL ELECTRICAL CONDUCTORS FOR FIRE ALARM SYSTEM MUST BE PROTECTED TO MEET MINIMUM 2 HOURS FIRE—RESISTANCE RATING.
- 2. DRAWING ARE DIAGRAMATICALLY ONLY. REFER TO FLOOR PLANS FOR EXACT LOCATION & QUANTITY OF DEVICES.
- 3. PROVIDE LINE ISOLATOR BETWEEN FLOORS & WHEN PASSING FIRE RATED
- 4. DIV. 16 TO PROVIDE REQUIRED WIRING C/W CONDUIT AS PER MANUFACTURER
- DIV. 16 TO COORDINATE WITH MECHANICAL/SPRINKLER CONTRACTOR FOR EXACT LOCATION OF SPRINKLER DEVICES AND PROVIDE REQUIRED F.A. WIRING, DEVICES & CONNECTION
- 6. DIV. 16 TO REFER TO F.A. SCHEDULE FOR F.A CONNECTION & ZONING PROVIDE APPROPRIATE ZONES AS PER FIRE MARSHALL INSTRUCTION
- 7. PROVIDE SIGNAL TO FIRE DEPARTMENT
- 8 PROVIDE CLASS 'A' WIRING FOR ALARM CIRCUITS
- 9 PROVIDE CLASS 'A/B' WIRING FOR RESIDENTIAL SUITES SIGNAL CIRCUITS
- PROVIDE 2 SIGNAL CIRCUITS FOR EVERY FLOOR FOR RESIDENTIAL, 1 SIGNAL FOR CORRIDOR & 1 FOR SUITES

PROVIDE ALARM LOOPS FOR THE FOLLOWING;

- 1 LOOP FOR GROUND FLOOR 1 LOOP FOR 2ND FLOOR
- 1 LOOP FOR 3RD FLOOR PROVIDE REQUIRED SEPARATE LOOPS FOR SPRINKLER FIRE ALARM DEVICES AS PER MECHANICAL SCHEDULE AND CODE REQUIREMENTS.
- TWO STAGE TYPE SYSTEM C/W ALL WIRING, CONDUIT, DEVICES & ALL APPURTENANCES FOR A COMPLETE INSTALLATION & OPERATION. PROVIDE FAN SWITCHES CONTROLLING THE EXHAUST FANS AS NOTED ON DRAWING PLANS.
- 12. DIV. 16 TO PROVIDE FIRE ALARM CONNECTIONS AS PER ELECT. F.A SCHEDULE DEVICES AND MECH. FIRE SPRINKLER & STANDPIPES SYSTEMS SCHEDULE FOR FIRE PUMPS, VALVES, SWITCHES ETC FOR ALARM, SUPERVISED & AUXILLIARY ZONES SCHEDULE C/W REQUIRED WIRING AND CONDUIT FOR A COMPLETE INSTALLATION & OPERATION TO SUIT. REFER TO F.A SCHEDULE ON DRAWING E902 FOR REQUIRED MECHANICAL AND ELECTRICAL DRAWINGS FOR THE PROPER & EXACT CONNECTIONS OF FIRE SPRINKLER, STANDPIPES & FIRE PUMP DEVICES/SWITCHES. PROVIDE REQUIRED CONNECTIONS TO ALL DEVICES FOR ALARM, SUPERVISORY & AUXILLIARY ZONES. EXACT LOCATION OF ALL DEVICES TO BE COORDINATED ON SITE WITH THE REQUIRED MECHANICAL DRAWINGS & CONTRACTOR. DIV. 16 TO PROVIDE REQUIRED F.A. CONNECTIONS AS PER LATEST ARCHITECTURAL, MECHANICAL AND SPRINKLER DRAWINGS REQUIREMENT. DIV. 16 TO PROVIDE REQUIRED CONDUIT SYSTEM (CONDUIT, PULL BOX, JUNCTION BOX, ETC) ALONG CORRIDORS TO SUIT INSTALLATION REQUIREMENT C/W REQUIRED F.A. CONNECTIONS TO MEET CODE.

	OP OF EVATORS				ROOF
#1	#2	#ST	AIR #STAI	R	
•	•				
		0	0		3RD
				F F S S S S S S F F	2NC
		0	0	□ F F F	
				FACP ANN	
					GROUND
•	9				
Y	¥				PIT

			FA	CP				INI	ΓΙΑΤΙ	NG	DEV	/ICE	S			NO1 DEV	TIFIC	ATIC S	N		MON								
FIRE ALARM ZONE	CIRCUIT NUMBER	DESCRIPTION	CONTROL	ANNUCIATION	PULL STATION	SMOKE DETECTOR	HEAT DETECTOR	DUCT SMOKE DETECTOR	SPRINKLER FLOW SWITCH	SPRK. SUPERVISED VALVE	SYS. CHECK	DRY SPR. SYS. CHECK VALVE	LOW PRESSURE VALVE	SIGNAL TO FIRE DEPARTMENT	HORN/STROBE	STROBE	HORN		PRESSURE PUMP		EMERGENCY POWER	SMOKE DAMPER	FAN AUTOMATIC SHUT-DOWN	FAN AUTOMATIC START-UP	z	MUSIC EQUP. SHUT-DOWN	ELEVATOR RECALL	FIREMAN HANDSET SIGNAL TO FIRE DEPARTMENT	MISC
1	4 1			Α.			_														_				_		_		_
1 2	2	MAIN HYDRO ELECT./MECH. ROOM GROUND FLOOR, COMMON ROOMS		A	$\leq$	<b>~</b>									$\vee$										$\vdash$			<b>\</b>	
3	2	GROUND FLOOR (CORRIDOR)		A	\ ./	<b>\</b>									<b>Y</b>					_						-	<b>/</b>	<b>&gt;</b>	
4	3	GROUND FLOOR (SUITES)		A	ľ	~									<b>Y</b>					+			H				Ť	\ \ '	_
5	4	2ND FLOOR (ELECT. ROOM)		A		<b>✓</b>	_								ľ	<b>/</b>	<b>~</b>											\ \	
6	4	2ND FLOOR (LAUNDRY ROOM)		Α		Ž									<b>V</b>	_												Ž	_
7	4	2ND FLOOR (CORRIDOR)		Α	<b>/</b>	<b>✓</b>									/												<b>/</b>	V	
8	5	2ND FLOOR (SUITES)		Α	Ė		<b>/</b>								/		<b>✓</b>								П			~	·
9	6	3RD FLOOR (ELECT. ROOM)		Α		<b>✓</b>										<b>✓</b>												~	
10	6	3RD FLOOR (LAUNDRY ROOM)		Α		<b>✓</b>									<b>V</b>													~	
11	_	3RD FLOOR (CORRIDOR)		Α	<b>V</b>	<b>✓</b>									$\checkmark$												<b>/</b>	~	
12	_	3RD FLOOR (SUITES)		Α			<b>✓</b>								$\vee$		<b>✓</b>											<b>~</b>	
13	_	STAIR #1		Α		<b>✓</b>																						<b>~</b>	
14	9	STAIR #2		Α		<b>✓</b>																						<b>-</b>	
15	_	MUA-1		Α				<b>/</b>								<u> </u>			_				<u> </u>	<b>V</b>					RAS
16	$\dashv$	MUA-2		A				<b>✓</b>							L	<b>✓</b>			_	_			<u> </u>	<b>✓</b>	<u> </u>				RAS
17	$\dashv$	GEN. STOP		S	L										L				$\perp$										_
18	$\dashv$	GEN. RUNNING		R	┞										┞				+										_
19 20	$\dashv$	GEN. TROUBLE GEN. LOW LEVEL FUEL		T	L																								_
20 21	$\dashv$	GEN. LOW LEVEL FOEL	_	<u>'</u>	l										H				+										+
22	$\dashv$	SV-1		Т	H					<b>/</b>					┢				$\dashv$										
23	$\dashv$	SV-4		Т						<b>×</b>																			+
24	$\dashv$	SV-5		T	┢					<b>×</b>																			+
25	$\dashv$	SV-6		Т	H					<u>,</u>																			-
26	$\dashv$	SV-7		Т	H					· /																			+
27	_	SV-8		Т						V																			
28	一	SV-9		Т						· ✓									1										
29	$\dashv$	SV-10	$\dashv$	Т	H					<u></u>					T				$\top$										
30	一	SV-11		Т						<u> </u>									$\dashv$							$\sqcap$			1
31	一	SV-12		Т						<u></u>									$\dashv$										
32	一	SV-13	$\neg$	Т						<b>/</b>																			
33	Ī	SV-14		Т						<u></u>																			
34		PS-5		Т									<b>✓</b>																
35		PS-6		Т									<b>✓</b>																
36	[	PS-7		Т									<b>✓</b>																
37	[																		$\perp$				<u> </u>					$\perp$	
38	_[	EMEREGENCY VALVE (GAS LINE)		Α	L																								
39					L										L														N.O/I CONTA
40																													
41																													
		CONTROL SWITCHES  OC — OPEN/CLOSE  RAS — RUN/AUTO/STOP  C/W REQUIRED						ΙΔR	м	•	<u>AMP</u>	C ·	– R	LOSE UNNING TOP	3														

CONTRACTOR TO CHECK AND VERIFY ALL DIMENSIONS AND SITE CONDITIONS. REPORT ANY DISCREPANCIES TO THE CONSULTANT BEFORE PROCEEDING WITH THE WORK. DRAWINGS ARE NOT TO BE SCALED FOR DIMENSIONS.



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		O ISSUES/REVISIONS A	
No.	Date	Description	Ву
1	2024/04/12	ISSUED FOR PERMIT	BV
2	2024/07/30	ISSUED FOR TENDER	BV

#### PRIOR TO PROJECT CONSTRUCTION COMPLETION!!!!

GENERAL CONTRACTOR - MANDATORY DELIVERABLES (WHERE APPLICABLE):

ALL ITEMS LISTED BELOW ARE TO BE DELIVERED TO THE APPROPRIATE AUTHORITY HAVING JURISDICTION FOR THIS BUILDING PERMIT

-ALL OPERATION AND MAINTENANCE MANUALS. -ALL PRODUCT DATA THAT PERTAINS TO ALL FIRESTOPPING MATERIALS

-VERIFICATION LETTER BY A CERTIFIED AND LICENSED SPRINKLER AND LIFE SAFETY SYSTEMSCONTRACTOR. LETTER TO VERIFY INSTALLATION AND/OR MODIFICATIONS AND TESTING PERFORMED AND COMPLETED IN ACCORDANCE WITH NFPA 13 -ALL ESA REPORTS, FINAL SIGN OFF AND PERMITS -VERIFICATION LETTER BY A CERTIFIED AND LICENSED EMERGENCY

LIGHTING ANF LIFE SAFETY SYSTEMS CONTRACTOR.
-CERTIFICATES OF FIRE ALARM VERIFICATION -HYDRO INSPECTION CERTIFICATES -EMERGENCY LIGHTING TEST REPORT. -TESTING, AIR BALANCING, ADJUSTING REPORTS FOR ALL HVAC SYSTEMS -ALL STRUCTURAL STEEL SHOP DRAWINGS AND ENGINEERING REVIEWS -ALL SITE VISIT REPORTS PROVIDED BY PROFESSIONAL DISCIPLINES. -OCCUPANCY AND COMPLIANCE LETTERS FROM ALL PROFESSIONAL DISCIPLINES.



**CONSULTING ENGINEERS** LIGHTING - ELECTRICAL 595 CITYVIEW BLVD, SUITE 204/205 VAUGHAN, ONTARIO, CANADA L4H 3M7 Tel:(905)417-6881 Fax:(905)417-6882 www.e-lumen.ca





32 UNIT AFFORDABLE HOUSING APARTMENT BUILDING 20 SOUTH STREET, TRENTON, ON

City of Quinte West

ELECTRICAL FIRE DETAILS AND SCHEDULE

Drawn	Checked
DD/MU	BV
Date June 2023	Scale N.T.S
Project Number	Sheet Number
23-019	E-700

## NOTES:


TELEPHONE RISERS

E800 SCALE: N.T.S

INCOMING 2-4"C FOR BELL WITHIN PERIMETER OF PROPERTY LINE ACCORDINGLY. PROVIDE REQUIRED 24"x24"x12" JUNCTION BOX COMPLETE WITH COVER TO SUIT.

2 4'x8'x3/4" FIRE RATED PLYWOOD BACKBOARD FOR COMMUNICATION. TYPICAL.

3. REFER TO PANEL SCHEDULES OR DETAILS OF ROOMS FOR RECEPTACLES POWER CIRCUITING.

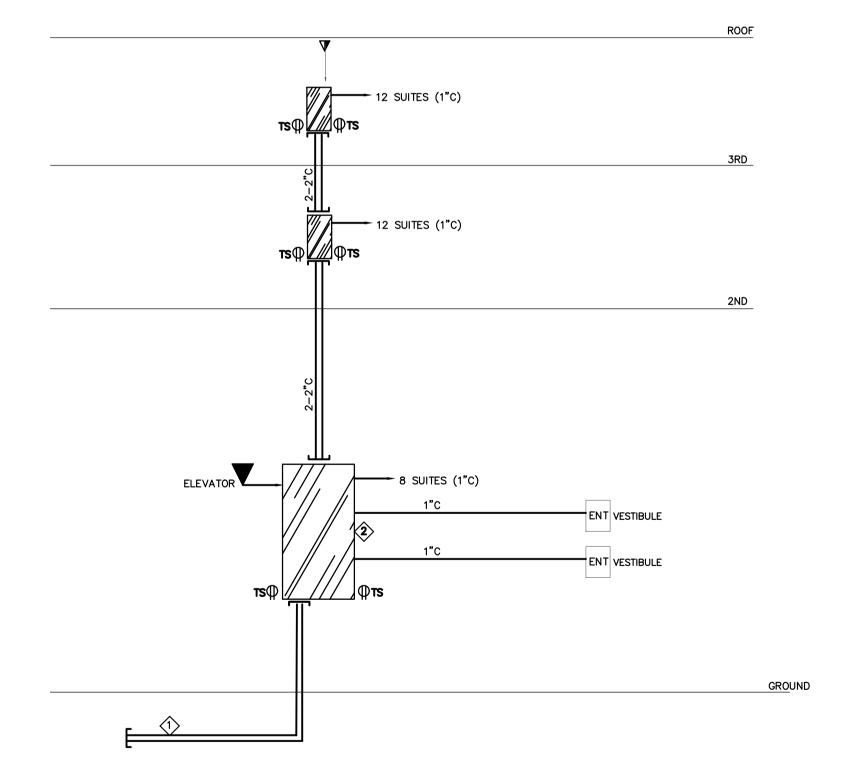


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<sup>2</sup> CABLE RISERS

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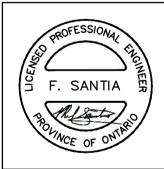
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Project Tit

32 UNIT AFFORDABLE HOUSING APARTMENT BUILDING 20 SOUTH STREET, TRENTON, ON

City of Quinte West

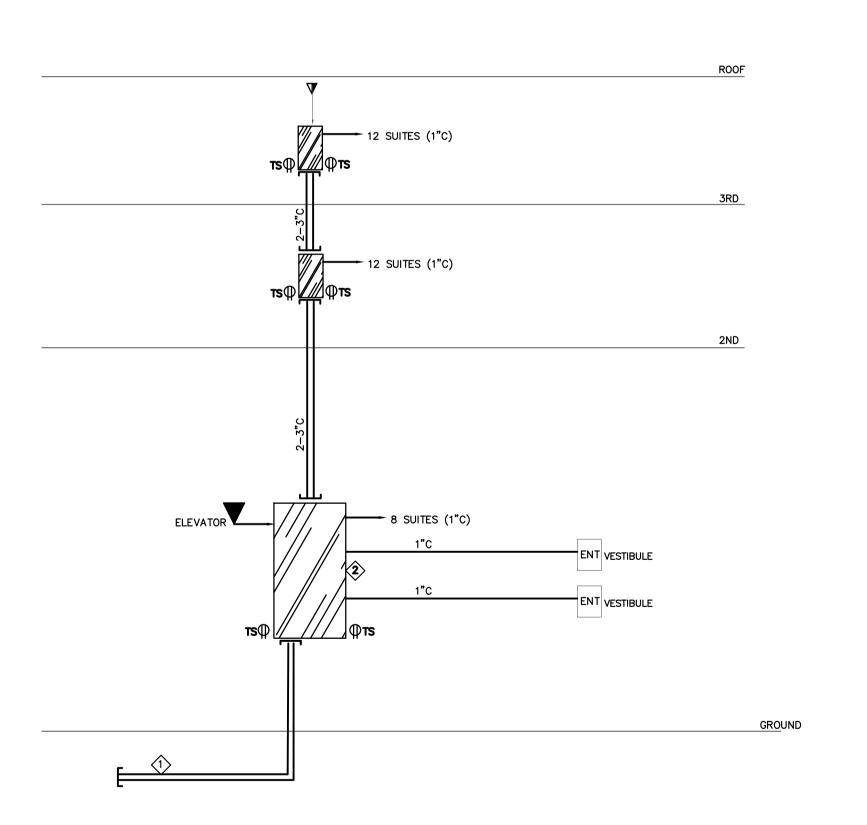
Sheet Title

SECURITY AND COMMUNICATION RISERS

Drawn DD/MU	Checked <b>BV</b>
Date June 2023	Scale N.T.S.
Project Number	Sheet Number
23-019	E-800

## NOTES:

- SECRITY CONTROLLER. EXACT LOCATION TO BE COORDINATED ON SITE TO SUIT.
- SECURITY CAMERA C/W REQUIRED JUNCTION BOX AND 3/4"C. TERMINATE TO NEAREST PULL BOX LOCATION.
- 3 10"x10"x6" PULL BOX WITHIN CEILING SPACE C/W REQUIRED COVER AND 1 1/2" CONDUIT SYSTEM AND UP TO SECURITY CONTROLLER PANEL LOCATION TO SUIT.
- 10"x10"x6" PULL BOX WITHIN CEILING SPACE C/W REQUIRED COVER AND 2" CONDUIT SYSTEM AND UP TO SECURITY CONTROLLER PANEL LOCATION TO SUIT.
- 4. CAMERA AND OTHER SECURITY DEVICES C/W WIRING TO PROVIDED BY SECURITY CONTRACTOR. TERMINATION BY SECURITY CONTRACTOR.
- 5. REFER TO FLOOR PLANS FOR EXACT LOCATION OF SECURITY CAMERAS AND COORDINATE ON SITE.
- 6. DIAGRAM SHOWN INTENT ONLY. PROVIDE REQUIRED CONDUIT SYSTEM C/W ALL MOUNTING ACCESSORIES TO SUIT.
- 7. CAMERA WORK BY OWNER'S VENDOR OF RECORD.

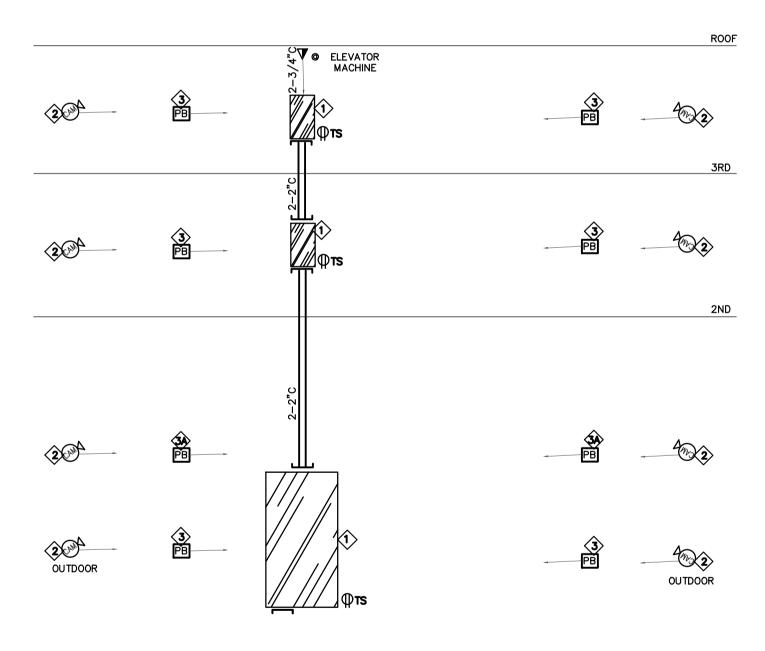

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32 UNIT AFFORDABLE HOUSING APARTMENT BUILDING 20 SOUTH STREET, TRENTON, ON

City of Quinte West

SECURITY DETAILS

Drawn DD/MU	Checked <b>BV</b>
Date June 2023	Scale N.T.S.
Project Number	Sheet Number
07 040	

23-019

E-800A

SECURITY CAMERA DETAIL

E800A SCALE: N.T.S

LOAD DESCRIPTION	LOAD (W)	BRKR SIZE	CCT NO.	PH	CCT NO.	BRKR SIZE	LOAD (W)	LO	AD DESCRIPTION		
OUTDOOR POLE LIGHTS (X10)	, ,	20A	1	Α	2	20A	, ,	COF	RRIDOR LTG - GND FL		
OUTDOOR DOWNLIGHTS (X12)		20A	3	В	4	20A		CO	MMON RM, OFFICE LTG		
GARBAGE, SCOOTER RMS LTG		20A	5	С	6	20A		COMMON RM RECEPTS (X			
UNIVERSAL, STAFF WR LTG		20A	7	Α	8	20A		ABOVE COUNTER RECEPT			
JANITOR WS, STORAGE LTG		20A	9	В	10	20A		COMMON RM (2#12 AWG+			
UNIVERSAL, STAFF WR RECEPTACLES (X2)		15A	11	С	12	15A		COF	RRIDOR RECEPT - GND FL		
GARBAGE, SCOOTER RMS		15A	13	Α	14	15A		CO	MMON ROOM RECEPTS (X5)		
GFL RECEPTACLES (X7) JANITOR WS, STORAGE		15A	15	В	16	15A		OFF	TICE RECEPTACLES (X5)		
RECEPTACLES (X10)		30A /	17	С	18	30A			· ,		
GROUND FLOOR FF-1		2P	19	Α	20	2P		GRO	OUND FLOOR FF-1		
		30A	21	В	22	30A		H			
GROUND FLOOR FF-1		2P	23	C	24	2P		GRO	OUND FLOOR FF-1		
		30A /	25	Α	26	30A		H			
GROUND FLOOR FF-1		2P	27	В	28	2P		GRO	OUND FLOOR FF-1		
		30A /	29	С	30	30A		$\vdash$			
GROUND FLOOR FF-1		2P	31	Ā	32	2P		UH-	-1		
		30A	33	В	34	30A		$\vdash$			
UH-2		2P	35	c	36	2P		UH-3			
		30A /	37	Ā	38	15A		SP/	ARE		
UH-4		2P	39	В	40	15A		SPA	ARE		
AC 1		20A /	41	C	42	20A		1	_		
AC-1 2#12 +GND 3/4"C		2P	43	Α	44	2P		AC- 2#1	-2  2 +GND 3/4"C		
EF-1,2		15A	45	В	46	15A		EF-	-5,6		
EF-3,4		15A	47	С	48	15A		DOC	OR OPERATOR		
		15A /	49	A	50	15A		DOC	OR OPERATOR		
HWT CIRCULATING PUMP			51	В	52	15A		UNI	VERSAL WASHROOM		
		3P	53	C	54	15A		-	OR OPERATOR		
MISC. RECEPTACLES		15A	55	Α	56	15A		SPA	ARE		
SPARE		15A	57	_	58	15A		SPA	ARE		
SPARE		15A	59	С	60	15A		-	ARE		
		125A	61	Ā	62	15A		₩	FICE RECEPTACLES		
2HP2			63	В	64	20A		GFI	RECEPTACLES		
		3P	65	0	66	15A		-	RECEPTACLES		
	VOLTS:	120/20		·	TYF				□FLUSH		
	PHASE:	у Зø				D(kW):			⊠ SURFACE		
P-2HP1	WIRE:	4W				• •	s):		SPRINKLERPROOF		
		400A			LOAD(AMPS): LOCATION: GF ELEC RM				☐ MAIN BREAKER		
	I.C.(KA):						:MS-6AB		SPD		
NOTES:		2011			, <u></u>	, I KOW	. 1410 0/10				

- 1. PROVIDE DOUBLE SIZED NEUTRAL BUS.
  2. THE MAINS SHALL BE COPPER AND SUITABLE FOR BOLT—ON BREAKERS.
  3. COMPLETE CIRCUIT DIRECTORY WITH TYPEWRITTEN LEGEND SHOWING LOCATION OF EACH CIRCUIT.
  4. CIRCUIT NUMBER FOR GROUPING PURPOSE ONLY.
- PANEL SHALL BE WITH ISOLATED GROUND BAR. 6. "\*" DENOTES LOCK TYPE BREAKER

LOAD DESCRIPTION	LOAD (W)	BRKR SIZE	CCT NO.	РН	CCT NO.	BRKR SIZE	LOAD (W)	LO	AD DESCRIPTION		
SPARE		20A	1	Α	2	20A		MAI	N SECURITY CONTROL- 3F		
SPARE		20A	3	В	4	15A		TEL	TELEPHONE BACKBOARD-3F		
MAIN SECURITY CONTROL- 2F		20A	5	С	6	15A		TELEPHONE BACKBOARD-3F			
TELEPHONE BACKBOARD-2F		20A	7	Α	8	15A		ROOF LTG			
TELEPHONE BACKBOARD-2F		20A	9	В	10	15A		SPA	ARE		
CORRIDOR LTG - 2ND FL		20A	11	С	12	15A		SPARE			
CORRIDOR LTG - 3RD FL		20A	13	Α	14	15A		SPARE			
SPARE		15A	15	В	16	15A		SPARE			
SPARE		15A	17	С	18	15A		SPARE			
SPARE		15A	19	Α	20						
			21	В	22						
			23	С	24						
			25	Α	26						
			27	В	28						
			29	С	30						
	VOLTS:	120/20	8V		TYF	E:			□FLUSH		
	PHASE:	3ø			LOA	ND(kW):			⊠ SURFACE		
P-2E2	WIRE:	4W			LOA	D(AMPS	S):				
	MAINS:	125A			LOC	CATION:	2ND FLOC	)R	☐ MAIN BREAKER		
	I.C.(KA): 25kA					FROM	: DP-6E1		☐ SPD		
NOTES:		· ·									
1 DDOVIDE DOLIDLE SIZED	NELITONI DI	10									

- PROVIDE DOUBLE SIZED NEUTRAL BUS.
   THE MAINS SHALL BE COPPER AND SUITABLE FOR BOLT—ON BREAKERS.
   COMPLETE CIRCUIT DIRECTORY WITH TYPEWRITTEN LEGEND SHOWING LOCATION OF EACH CIRCUIT.
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LOAD DESCRIPTION	LOAD (W)	BRKR SIZE	CCT NO.	란	CT NO.	BRKR SIZE	LOAD (W)	L	)AD DESCRIPTION	
ELEVATOR #2 20KVA TX		25A 3P	1 3 5	A B C	2 4 6	40A 3P		P	-2E2	
			7	Α	8					
SPACE			9	В	10			SF	PACE	
			11	O	12	12				
	VOLTS:	347/60	0V		TYF	PE:			□FLUSH	
DD 650	PHASE:	3ø			LOA	AD(kW):			⊠ SURFACE	
DP-6E2 'NON LIFE SAFETY'	WIRE:	4W			LOA	AD(AMPS	S):		SPRINKLERPROOF	
	MAINS:	125A			LOC	CATION:	2ND FLOO	R	☐MAIN BREAKER	
	I.C.(KA):	35kA			FEC	FROM	:DP-6EN		□SPD	

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  COMPLETE CIRCUIT DIRECTORY WITH TYPEWRITTEN LEGEND SHOWING LOCATION OF EACH CIRCUIT. CIRCUIT NUMBER FOR GROUPING PURPOSE ONLY.
- 5. PANEL SHALL BE WITH ISOLATED GROUND BAR.
  6. "\*" DENOTES LOCK TYPE BREAKER

LOAD DESCRIPTION	LOAD (W)	BRKR SIZE	CCT NO.	РΗ	CCT NO.	BRKR SIZE	LOAD (W)	LC	AD DESCRIPTION	
EXIT SIGNS LTG — GND FL		20A	1	Α	2	20A		COI	RRIDOR LTG — GND FL	
EXIT STAIRS LTG (WEST)		20A	3	В	4	20A		MIS	C. RM LTG — GF	
EXIT STAIRS LTG (EAST)		20A	5	С	6	20A		SPA	ARE .	
VESTIBULE LTG		20A	7	Α	8	20A		ELE	CT/MECH RM GFI LTG	
ELEVATOR LIGHTING		20A	9	В	10	20A		ELE	VATOR LIGHTING	
SPARE		15A	11	С	12	20A		ELEVATOR MACHINE RM LTG		
SPARE		15A	13	Α	14	15A		ELEVATOR CAB CONTROL		
ELEVATOR CAB CONTROL		15A	15	В	16	15A			VATOR MACHINE RM RECPT	
VESTIBULE RECEPTACLES		15A	17	С	18	15A			RV CORR, JAN CLOSEI RECPTACLES (X2)	
MAIN SECURITY CONTROL		15A	19	Α	20	20A		SERV CORR, JAN ČLÓSET L		
TELEPHONE BACKBOARD		15A	21	В	22	15A		ELEVATOR PIT LIGHTING		
TELEPHONE BACKBOARD		15A	23	С	24	15A		SPARE		
SPARE		15A	25	Α	26	15A		SPA	ARE .	
			27	В	28					
			29	С	30					
	VOLTS:	120/20	8V		TYF	E:			□FLUSH	
	PHASE:	3ø			LOA	D(kW):			⊠ SURFACE	
P-2E1	WIRE:	4W			LOAD(AMPS):					
	MAINS:	125A			LOC	CATION:	2ND FLOO	R	☐ MAIN BREAKER	
	I.C.(KA):	25kA		FED FROM: DP−6E1 ☐ SPD					☐ SPD	
NOTES:										
1 PROVIDE DOUBLE SIZED	NEUTRAL R	lis -								

1. PROVIDE DOUBLE SIZED NEUTRAL BUS.
2. THE MAINS SHALL BE COPPER AND SUITABLE FOR BOLT—ON BREAKERS.
3. COMPLETE CIRCUIT DIRECTORY WITH TYPEWRITTEN LEGEND SHOWING LOCATION OF EACH CIRCUIT.
4. CIRCUIT NUMBER FOR GROUPING PURPOSE ONLY.
5. PANEL SHALL BE WITH ISOLATED GROUND BAR.
6. "\*" DENOTES LOCK TYPE BREAKER

LOAD DESCRIPTION	LOAD (W)	BRKR SIZE	CCT NO.	РΗ	CCT NO.	BRKR SIZE	LOAD (W)	LC	DAD DESCRIPTION
CORRIDOR LTG - 2ND FL	(44)	15A	1	Α	2	30A	(11)	2NI	D FLOOR LAUNDRY
CORRIDOR RECEPT - 2ND FL		15A	3	В	4	2P		ROO	DM DRYER
CORRIDOR LTG - 3RD FL		15A	5	С	6	30A		2NI	D FLOOR LAUNDRY
CORRIDOR RECEPT - 3RD FL		15A	7	Α	8	2P		ROO	DM DRYER
2ND FLOOR LAUNDRY RM WM		15A	9	В	10	30A		2NI	D FLOOR LAUNDRY
2ND FLOOR LAUNDRY RM WM		15A	11	C	12	2P		ROO	DM DRYER
2ND FLOOR LAUNDRY RM WM		15A	13	Α	14	30A		2NI	D FLOOR LAUNDRY
2ND FLOOR LAUNDRY RM WM		15A	15	В	16	2P		ROO	DM DRYER
3RD FLOOR LAUNDRY RM WM		15A	17	С	18	30A		3RI	D FLOOR LAUNDRY
3RD FLOOR LAUNDRY RM WM		15A	19	Α	20	2P		ROO	DM DRYER
3RD FLOOR LAUNDRY RM WM		15A	21	В	22	30A		3RI	D FLOOR LAUNDRY
3RD FLOOR LAUNDRY RM WM		15A	23	С	24	2P			DM DRYER
ZND FLOOR LAUNDRY RM,		15A	25	Α	26	30A		3RI	D FLOOR LAUNDRY
JANITOR CLOSET GFI RECEP 3RD FLOOR LAUNDRY RM, JANITOR CLOSET GFI RECEP		15A	27	В	28	2P		ROO	DM DRYER
2ND FLOOR LAUNDRY RM,		20A	29	C	30	30A		3RI	D FLOOR LAUNDRY
JANITOR CLOSET LTG 3RD FLOOR LAUNDRY RM, JANITOR CLOSET LTG		20A	31	Α	32	2P			DM DRYER
		30A	33	В	34	15A		EF-	-7
2ND FLOOR FF-1	4000W	2P	35	O	36	15A		RO	OF RECEPTACLE
OND 51 00D 55 4		30A	37	Α	38	15A		LAU	INDRY ROOM PRESS. CON
2ND FLOOR FF-1	4000W	2P	39	В	40	15A		LAU	INDRY ROOM PRESS. CON
		30A /	41	C	42	15A		REC	CEPTACLES 2ND/3RD LNDI
AUNDRY ROOM FAN		/	43	Α	44	15A		DO	OR OPERATOR
POWER SUPPLY		3P	45	В	46				
		ĺ	47	O	48			Т	
			49	Α	50				
			51	В	52			T	
			53	C	54				
			55	Α	56			Т	
			57	В	58			Τ	
			59	С	60			T	
			61	Α	62			Т	
			63	В	64			Τ	
			65	С	66			T	
	VOLTS:	120/20	8V		TYF	E:			□FLUSH
	PHASE:	3ø			LOA	AD(kW):			⊠ SURFACE
P-2HP2	WIRE:	4W		LOA	D(AMPS	S):		SPRINKLERPROOF	
						•	GF ELEC	RM	☐ MAIN BREAKER
	I.C.(KA):				ı		:MS-6AB		☐ SPD

1. PROVIDE DOUBLE SIZED NEUTRAL BUS.
2. THE MAINS SHALL BE COPPER AND SUITABLE FOR BOLT—ON BREAKERS.
3. COMPLETE CIRCUIT DIRECTORY WITH TYPEWRITTEN LEGEND SHOWING LOCATION OF EACH CIRCUIT.
4. CIRCUIT NUMBER FOR GROUPING PURPOSE ONLY.
5. PANEL SHALL BE WITH ISOLATED GROUND BAR.

6. "\*" DENOTES LOCK TYPE BREAKER

LOAD DESCRIPTION	LOAD (W)	BRKR SIZE	CCT NO.	PH	CCT NO.	BRKR SIZE	LOAD (W)		LOAD DESCRIPTION			
COMMUNICATION RECEPTACLE OUTLET		15A	1	Α	2	15A		KITCHEN L	IGHTING/KITCHEN EXHAUST FAN (KEF-1			
LIVING/DINNING RM. RECEPTACLES/LIGHTING		15A	3	В	4	20A		ABOVE CO	OUNTER RECEPTACLES (2#12 AWG+G)			
FOYER/CORRIDOR RECEPT./LTG., COMBI SMOKE ALARMS/STROBES, SMOKE/CARBON MONOXIDE		15A	5	Α	6	20A		ABOVE CC	OUNTER RECEPTACLES (2#12 AWG+G)			
BATHROOM RM. GFI RECEPTACLE/LIGHTING/EF		15A	7	В	8	15A		FRIDGE	FRIDGE			
BEDROOM RM. GFI RECEPTACLE/LIGHTING/EF		15A	9	Α	10	15A		DISHWASH	DISHWASHER			
ERV-1		15A	11	В	12	15A		MICROWAV	E			
(MASTER BEDRM. RECEPTACLE/LIGHTING) 2BEDRM.		15A	13	Α	14	15A		HP-1				
SPARE		15A	15	В	16	<b>/</b> 2P						
SPACE			17	Α	18	40A		STOVE (4#8 AWG WIRING)				
SPACE			19	В	20	<b>/</b> 2P		310VE (4)	TO AWG WIKING)			
SPACE			21	Α	22	15A		SPARE				
SPACE			23	В	24	15A		SPARE				
PANEL "S1"	VOLTS	: 12	0/20	)8V	TYPI	Ξ:			<b></b> IFLUSH			
(TYPICAL FOR 1BR, 2BR SUITES)	PHASE	: 3ø			LOAI	)(kW):		[	SURFACE			
(····,	WIRE: 4W LOAD(AMPS):				O(AMPS		] SPRINKLERPROOF					
	MAINS: 125A LC					ATION:	SUITE	SPACE	MAIN BREAKER (100A-2P)			
	I.C.(KA): 25kA FED FROM: 2D1/2/3 ☐ TVSS						☐ TVSS					
NOTES FOR FAN MOTOR:  EF - PROVIDE FAN SWITCH.  INTERLOCK FXHAUST FAN FE-2 WITH								•				

- INTERLOCK EXHAUST FAN EF-2 WITH DRYER. PROVIDE REQUIRED WIRING RELAY AND CONTACTOR TO SUIT. DIV. 16 TO PROVIDE REQUIRED ARC-FAULT TYPE BREAKER TO ALL CIRCUIT BREAKERS AS REQUIRED BY CODE TO SUIT.

LOAD DESCRIPTION	LOAD (W)	BRKR SIZE	CCT NO.	PH	CCT NO.	BRKR SIZE	LOAD (W)		LOAD DESCRIPTION		
COMMUNICATION RECEPTACLE OUTLET		15A	1	Α	2	15A		KITCHEN	LIGHTING/KITCHEN EXHAUST FAN (KEF-1		
LIVING/DINNING RM. RECEPTACLES/LIGHTING		15A	3	В	4	20A		ABOVE C	BOVE COUNTER RECEPTACLES (2#12 AWG+G)		
FOYER/CORRIDOR RECEPT./LTG., COMBI SMOKE ALARMS/STROBES, SMOKE/CARBON MONOXIDE		15A	5	Α	6	20A		ABOVE C	ABOVE COUNTER RECEPTACLES (2#12 AWG+G)		
BATHROOM RM. GFI RECEPTACLE/LIGHTING/EF		15A	7	В	8	15A		FRIDGE			
BEDROOM RM. GFI RECEPTACLE/LIGHTING/EF		15A	9	Α	10	15A		DISHWASHER			
ERV-1		15A	11	В	12	15A		MICROWAVE			
(MASTER BEDRM. RECEPTACLE/LIGHTING) 2BEDRM.		15A	13	Α	14	15A		HP-1			
(MASTER BEDRM. RECEPTACLE/LIGHTING) 3BEDRM.		15A	15	В	16	<b>2</b> P					
SPACE			17	Α	18	40A		STOVE (4#8 AWG WIRING)			
SPACE			19	В	20	<b>2</b> P		31042 (-	THE ANG WINNES		
SPACE			21	Α	22	15A		SPARE			
SPACE			23	В	24	15A		SPARE			
PANEL "S2"	VOLTS	: 12	0/20	)8V	TYP	E:			⊠FLUSH		
(TYPICAL FOR 3BR SUITES)	PHASE	: 3ø			LOA	)(kW):			□SURFACE		
(	WIRE:	4W	/		LOA	O(AMPS	S):		☐ SPRINKLERPROOF		
							SPACE	⊠MAIN BREAKER (100A-2P)			
	I.C.(K/	A): 25	kA		l		: 2D1/		□ TVSS		
NOTES FOR FAN MOTOR:  EF - PROVIDE FAN SWITCH.  - INTERLOCK EXHAUST FAN EF-2 WITH DRYER. PROVIDE REQUIRED WIRING RELAY AND CONTACTOR TO SUIT.											

DAD DESCRIPTION	LOAD (W)	BRKR SIZE	CCT NO.	PH	CCT NO.	BRKR SIZE	LOAD (W)	LC	DAD DESCRIPTION
		25A /	1	Α	2	40A		Г	
ELEVATOR #1 20KVA TX			3	В	4			P.	-2E1
		<b>3</b> P	5	C	6	<b>3</b> P		┖	
		15A /	7	Α	8				
JOCKEY PUMP		/	9	В	10			SI	PACE
		<b>3</b> P	11	O	12				
	VOLTS:	347/60	)OV		TYF	PE:			□FLUSH
DD 651	PHASE:	3ø			LOA	AD(kW):			SURFACE
DP-6E1 'LIFE SAFETY'	WIRE:	4W			LOA	AD(AMPS	S):		SPRINKLERPROOF
211 2 37 11 27 1	MAINS:	125A			LOC	CATION:	2ND FLO	OR	⊠MAIN BREAKER
	35kA			FEC	FROM	:DP-6EN		□SPD	

6. "\*" DENOTES LOCK TYPE BREAKER

PROVIDE DOUBLE SIZED NEUTRAL BUS.
 THE MAINS SHALL BE COPPER AND SUITABLE FOR BOLT—ON BREAKERS.
 COMPLETE CIRCUIT DIRECTORY WITH TYPEWRITTEN LEGEND SHOWING LOCATION OF EACH CIRCUIT.
 CIRCUIT NUMBER FOR GROUPING PURPOSE ONLY.

5. PANEL SHALL BE WITH ISOLATED GROUND BAR. 6. "\*" DENOTES LOCK TYPE BREAKER

LOAD DESCRIPTION	LOAD (W)	BRKR SIZE	CCT NO.	PH	CT NO.	BRKR SIZE	LOAD (W)	LC	)AD DESCRIPTION
P-2D1		250A 3P	1 3 5	A B C	2 4 6	350A 3P		P-	-2D2
P-2D3		350A 3P	7 9 11	A B C	8 10 12			SF	PACE
PANEL '2SD'	VOLTS: PHASE: WIRE: MAINS: I.C.(KA):	120/20 3ø 4W 1000A 65kA	8V		LOA LOC	AD(kW): AD(AMPS CATION:	S): MAIN ELE RM. MSB-6AB	CT.	□ FLUSH ☑ SURFACE ☑ SPRINKLERPROOF □ MAIN BREAKER □ SPD

1. PROVIDE DOUBLE SIZED NEUTRAL BUS.
2. THE MAINS SHALL BE COPPER AND SUITABLE FOR BOLT—ON BREAKERS.
3. COMPLETE CIRCUIT DIRECTORY WITH TYPEWRITTEN LEGEND SHOWING LOCATION OF EACH CIRCUIT.
4. CIRCUIT NUMBER FOR GROUPING PURPOSE ONLY.
5. PANEL SHALL BE WITH SOLATED GROUND BAR.
6. \*\*\*\* DENOTED LOCK TYPE DEPARTS.

CONTRACTOR TO CHECK AND VERIFY ALL DIMENSIONS AND SITE CONDITIONS. REPORT ANY DISCREPANCIES TO THE CONSULTANT BEFORE PROCEEDING WITH THE WORK. DRAWINGS ARE NOT TO BE SCALED FOR DIMENSIONS.



A - Drawing/detail number B - Sheet number where called C - Sheet number where drawn

	O ISSUES/REVISIONS A										
No.	Date	Description	Ву								
1	2024/04/12	ISSUED FOR PERMIT	BV								
2	2024/07/30	ISSUED FOR TENDER	BV								

### PRIOR TO PROJECT CONSTRUCTION COMPLETION!!!!

GENERAL CONTRACTOR - MANDATORY DELIVERABLES (WHERE APPLICABLE):

ALL ITEMS LISTED BELOW ARE TO BE DELIVERED TO THE APPROPRIATE AUTHORITY HAVING JURISDICTION FOR THIS BUILDING PERMIT

-ALL OPERATION AND MAINTENANCE MANUALS. -ALL PRODUCT DATA THAT PERTAINS TO ALL FIRESTOPPING MATERIALS


-VERIFICATION LETTER BY A CERTIFIED AND LICENSED SPRINKLER AND LIFE SAFETY SYSTEMSCONTRACTOR. LETTER TO VERIFY INSTALLATION AND/OR MODIFICATIONS AND TESTING PERFORMED AND COMPLETED IN ACCORDANCE WITH NFPA 13 -ALL ESA REPORTS, FINAL SIGN OFF AND PERMITS -VERIFICATION LETTER BY A CERTIFIED AND LICENSED EMERGENCY

LIGHTING ANF LIFE SAFETY SYSTEMS CONTRACTOR.
-CERTIFICATES OF FIRE ALARM VERIFICATION -HYDRO INSPECTION CERTIFICATES -EMERGENCY LIGHTING TEST REPORT. -TESTING, AIR BALANCING, ADJUSTING REPORTS FOR ALL HVAC SYSTEMS
-ALL STRUCTURAL STEEL SHOP DRAWINGS AND ENGINEERING REVIEWS

-ALL SITE VISIT REPORTS PROVIDED BY PROFESSIONAL DISCIPLINES. -OCCUPANCY AND COMPLIANCE LETTERS FROM ALL PROFESSIONAL DISCIPLINES.





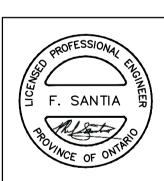

32 UNIT AFFORDABLE HOUSING APARTMENT BUILDING 20 SOUTH STREET, TRENTON, ON

City of Quinte West

ELECTRICAL PANEL SCHEDULES

Drawn DD/MU	Checked <b>BV</b>
Date	Scale
June 2023	N.T.S.
Project Number	Sheet Number
07 010	

23-019 L-900A

LOAD DESCRIPTION	LOAD (W)	BRKR SIZE	CCT NO.	PH	CCT NO.	BRKR SIZE	LOAD (W)	LO	AD DESCRIPTION
			1	Α	2				
			3	В	4				
			5	С	6				
			7	Α	8				
			9	В	10				
			11	С	12				
			13	Α	14				
			15	В	16				
			17	С	18				
P-2HP1	60KW	90A	19 21	A B	20 22	125A	90KW	DH	IWT
		3P	23	С	24	<b>3</b> P			
	VOLTS:	600V			TYP				□FLUSH
	PHASE:	3ø				D(kW):			⊠ SURFACE
P-6HP1	WIRE:	4W			LOA	D(AMPS	S):	<u>,</u>	
	MAINS:	250A			LOC	CATION:	MAIN ELEC RM.	1.	☐ MAIN BREAKER
	I.C.(KA):	35kA			FED	FROM	: MSB-6AB		☐ SPD

PROVIDE DOUBLE SIZED NEUTRAL BUS.

THE MAINS SHALL BE COPPER AND SUITABLE FOR BOLT—ON BREAKERS.

COMPLETE CIRCUIT DIRECTORY WITH TYPEWRITTEN LEGEND SHOWING LOCATION OF EACH CIRCUIT.

CIRCUIT NUMBER FOR GROUPING PURPOSE ONLY.

5. PANEL SHALL BE WITH ISOLATED GROUND BAR.
6. "\*" DENOTES LOCK TYPE BREAKER

	_		_						
LOAD DESCRIPTION	LOAD (W)	BRKR SIZE	CCT NO.	PH	CCT NO.	BRKR SIZE	LOAD (W)	LOA	AD DESCRIPTION
SUITE 1 (FLOOR 1)		100A 2P	1 3	A B	2	100A 2P		SU	ITE 2 (FLOOR 1)
SUITE 3 (FLOOR 1)		100A 2P	5 7	C A	6 8	100A 2P		SU	ITE 4 (FLOOR 1)
SUITE 5 (FLOOR 1)		100A 2P	9 11	B C	10 12	100A 2P		SU	ITE 6 (FLOOR 1)
SUITE 7 (FLOOR 1)		100A 2P	13 15	A B	14 16	100A 2P		SU	ITE 8 (FLOOR 1)
		15A	17	С	18	15A			
		15A	19	Α	20			Me	tering Controller
		15A	21	В	22	JP			-
		15A	23	С	24	15A			
		15A	25	Α	26	15A			
		15A	27	В	28	15A			
		15A	29	С	30	15A			
		15A	31	В	32	15A			
		15A	33	С	34	15A			
		15A	35	Α	36	15A			
		15A	37	В	38	15A			
		15A	39	С	40	15A			
		15A	41	Α	42	15A			
	VOLTS:	•	8V		TYF			- 1	□FLUSH
	PHASE:					ND(kW):		- 1	⊠ SURFACE
P-2D1	WIRE:	4W				D(AMPS):		- 1	
	MAINS:					CATION: 2N		R	☐ MAIN BREAKER
	I.C.(KA): 25kA					FROM: DF	P-6E1		☐ SPD
NOTES:									

1. PROVIDE DOUBLE SIZED NEUTRAL BUS.
2. THE MAINS SHALL BE COPPER AND SUITABLE FOR BOLT—ON BREAKERS.
3. COMPLETE CIRCUIT DIRECTORY WITH TYPEWRITTEN LEGEND SHOWING LOCATION OF EACH CIRCUIT.
4. CIRCUIT NUMBER FOR GROUPING PURPOSE ONLY.

CIRCUIT NOMBER FOR GROUPING FORFUSE ONE
 PANEL SHALL BE WITH ISOLATED GROUND BAR.
 "\*" DENOTES LOCK TYPE BREAKER

LOAD DESCRIPTION	LOAD (W)	BRKR SIZE	CCT NO.	PH	CCT NO.	BRKR SIZE	LOAD (W)	LOA	D DESCRIPTION
SUITE 21 (FLOOR 3)		100A 2P	3	A B	2	100A 2P		SUIT	E 22 (FLOOR 3)
SUITE 23 (FLOOR 3)		100A 2P	5 7	C A	6 8	100A 2P		SUIT	E 24 (FLOOR 3)
SUITE 25 (FLOOR 3)		100A 2P	9 11	ВС	10 12	100A 2P		SUIT	E 26 (FLOOR 3)
SUITE 27 (FLOOR 3)		100A 2P	13 15	A B	14 16	100A 2P		SUIT	E 28 (FLOOR 3)
SUITE 29 (FLOOR 3)		100A 2P	17 19	C A	18 20	100A 2P		SUIT	E 30 (FLOOR 3)
SUITE 31 (FLOOR 3)		100A 2P	21 23	ВС	22 24	100A 2P		SUIT	E 32 (FLOOR 3)
		15A 15A	25 27	A B	26 28	15A		Mete	ering Controller
		15A 15A	29 31	В	30 32	3P 15A			
		15A	33	0	34	15A		$\vdash$	
		15A	35	Ä	36	15A		$\vdash$	
		15A	37	В	38	15A		$\vdash$	
		15A	39	C	40	15A		$\vdash$	
		15A	41	Α	42	15A			
	VOLTS:	120/20	8V		TYF	E:		<u> </u>	FLUSH
	PHASE:	3ø			LOA	ND(kW):			SURFACE
P-2D3	WIRE:	4W			LOA	D(AMPS):			SPRINKLERPROOF
	MAINS:	400A			LOC	CATION: 2N	D FLOC	R [	MAIN BREAKER
	I.C.(KA)	): 25kA			FEC	FROM: DF	P-6E1		SPD
NOTES:  1. PROVIDE DOUBLE SIZED 2. THE MAINS SHALL BE CO 3. COMPLETE CIRCUIT DIREC 4. CIRCUIT NUMBER FOR GR 5. PANEL SHALL BE WITH IS 6. "*" DENOTES LOCK TYPE	PPER AN TORY WI OUPING OLATED	ND SUITABLE TH TYPEWRIT PURPOSE O GROUND BA	TEN NLY.	R BC LEG	)LT- END	ON BREAKER SHOWING LO	S. DCATION	OF EA	CH CIRCUIT.

LOAD DESCRIPTION	LOAD (W)	BRKR SIZE	CCT NO.	PΗ	CCT NO.	BRKR SIZE	LOAD (W)	LOA	AD DESCRIPTION
EV-1(2#6+GND - 1"C)		90A 2P	1 3	A B	2	90A 2P		EV-	2(2#8+GND - 1"C)
EV-1(2#6+GND - 1"C)		90A 2P	5 7	C A	6 8	90A 2P		EV-	2(2#8+GND - 1"C)
			9	В	10	<u> </u>			
			11	С	12				
			13	Α	14				
			15	В	16				
			17	С	18				
			19	A	20				
			21 23	В	22 24	ł			
	VOLTS:	120/20			TYF				 □FLUSH
	PHASE:	3ø			LOA	AD(kW):		- 1	☑ SURFACE
P-2B	WIRE:	4W			LOA	AD(AMPS	S):		SPRINKLERPROOF
	MAINS:	225A			LOC	CATION:	MAIN ELEC	<sup>;T.</sup>	MAIN BREAKER
	I.C.(KA):	20kA			FED	FROM	: MSB-6AB		☐ SPD
NOTES:  1. PROVIDE DOUBLE SIZED 2. THE MAINS SHALL BE 0 3. COMPLETE CIRCUIT DIRI 4. CIRCUIT NUMBER FOR 0 5. PANEL SHALL BE WITH 6. "*" DENOTES LOCK TYPE	COPPER AND ECTORY WITH GROUPING PUISOLATED GR	SUITABLE TYPEWRIT RPOSE O	TEN NLY.					OF E	ACH CIRCUIT.

LOAD DESCRIPTION	LOAD (W)	BRKR SIZE	CCT NO.	PH	CCT NO.	BRKR SIZE	LOAD (W)	LO	AD DESCRIPTION
SUITE 9 (FLOOR 2)		100A 2P	1 3	A B	2	100A 2P		SU	ITE 10 (FLOOR 2)
SUITE 11 (FLOOR 2)		100A 2P	5 7	C A	6 8	100A 2P		SU	ITE 12 (FLOOR 2)
SUITE 13 (FLOOR 2)		100A 2P	9 11	В С	10 12	100A 2P		SU	ITE 14 (FLOOR 2)
SUITE 15 (FLOOR 2)		100A 2P	13 15	A B	14 16	100A 2P		SU	ITE 16 (FLOOR 2)
SUITE 17 (FLOOR 2)		100A 2P	17 19	C A	18 20	100A 2P		SL	JITE 18 (FLOOR 2)
SUITE 19 (FLOOR 2)		100A 2P	21 23	В С	22 24	100A 2P		SL	JITE 20 (FLOOR 2)
		15A	25	Α	26	15A			
		15A	27	В	28			Me	etering Controller
		15A	29	С	30	3P			
		15A	31	В	32	15A			
		15A	33	С	34	15A			
		15A	35	Α	36	15A			
		15A	37	В	38	15A			
		15A	39	С	40	15A			
		15A	41	Α	42				
	VOLTS:	120/20	8V		TYF				□FLUSH
	PHASE:	Зø			ı	AD(kW):			SURFACE SURFACE
P-2D2	WIRE:	4W			LOA	AD(AMPS):			
	MAINS:	400A			LOC	CATION: 2N	ID FLOO	R	☐ MAIN BREAKER
	I.C.(KA)	): 25kA			FEC	FROM: DF	P-6E1		☐ SPD
NOTES:									

1. PROVIDE DOUBLE SIZED NEUTRAL BUS.
2. THE MAINS SHALL BE COPPER AND SUITABLE FOR BOLT—ON BREAKERS.
3. COMPLETE CIRCUIT DIRECTORY WITH TYPEWRITTEN LEGEND SHOWING LOCATION OF EACH CIRCUIT.
4. CIRCUIT NUMBER FOR GROUPING PURPOSE ONLY.
5. PANEL SHALL BE WITH ISOLATED GROUND BAR.
6. \*\* DENOTES LOCK TYPE BREAKER

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LIGHTING ANF LIFE SAFETY SYSTEMS CONTRACTOR.
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**CONSULTING ENGINEERS** LIGHTING - ELECTRICAL 595 CITYVIEW BLVD, SUITE 204/205 VAUGHAN, ONTARIO, CANADA L4H 3M7 Tel:(905)417-6881 Fax:(905)417-6882 WWW.e-lumen.ca





32 UNIT AFFORDABLE HOUSING APARTMENT BUILDING 20 SOUTH STREET, TRENTON, ON

City of Quinte West

ELECTRICAL PANEL SCHEDULES

Drawn DD/MU	Checked <b>BV</b>
Date June 2023	Scale N.T.S.
Project Number	Sheet Number

23-019

E-900B

LOAD DESCRIPTION	LOAD (W)	BRKR SIZE	CCT NO.	PH	CCT NO.	BRKR SIZE	LOAD (W)	LOAD DESCRIPTION
			1	Α	2			
			3	В	4			
			5	С	6			
	_		7	Α	8			
			9	В	10			
			11	C	12			
			13 15	В	14 16			
			17	С	18			
		90A /	19	Ā	-	125A /		
P-2HP1	60KW		21	В	22		90KW	DHWT
		3P	23	С	24	<b>3</b> P		
	VOLTS:	600V			TYF	E:		□FLUSH
	PHASE:	3ø			LOA	D(kW):		SURFACE
P-6HP1	WIRE:	4W			LOA	D(AMPS	S):	
	MAINS: 2	250A			LOCATION: MAIN ELECT.			MAIN BREAKER
	I.C.(KA):	35kA			FED	FROM	: MSB-6AE	B □ SPD
NOTES:  1. PROVIDE DOUBLE SIZI 2. THE MAINS SHALL BE 3. COMPLETE CIRCUIT DI 4. CIRCUIT NUMBER FOR 5. PANEL SHALL BE WITI 6. "*" DENOTES LOCK T	COPPER AND RECTORY WITH GROUPING PUI H ISOLATED GRO	SUITABLE TYPEWRIT RPOSE O	TEN NLY.					OF EACH CIRCUIT.

LOAD DESCRIPTION	LOAD (W)	BRKR SIZE		PH	CCT NO.	BRKR SIZE	LOAD (W)	LOAD DESCR	RIPTION
EXIT SIGNS LTG - GND FL		20A	1	Α	2	20A		2ND FLOOR LTO	<b>3</b> .
EXIT SIGNS LTG - GND FL		20A	3	в	4	20A		3RD FLOOR LTO	€.
		20A	5	O	6	20A		SPARE	
		20A	7	A	8	20A		SPARE	
		15A	9	в	10	15A			
		15A	11	O	12	15A		SPARE	
SPARE		15A	13	Α	14	15A		SPARE	
SPARE		15A	15	в	16	15A		SPARE	
SPARE		15A	17	O	18	15A		SPARE	
SPARE		15A	19	Α	20	15A		SPARE	
SPARE		15A	21	В	22	15A		SPARE	
SPARE		15A	23	O	24	15A		SPARE	
SPARE		15A	25	Α	26	15A		SPARE	
SPARE		15A	27	в	28	15A		SPARE	
SPARE		15A	29	O	30	15A		SPARE	
P-2E2	PHASE: WIRE:	120/20 3ø 4W 25A 25kA	BV		LOA	.D(kW): .D(AMPS :ATION:	S): 2ND FLOC : DP-6E1	1—	KLERPROO
NOTES:  1. PROVIDE DOUBLE SIZED 2. THE MAINS SHALL BE C 3. COMPLETE CIRCUIT DIREC 4. CIRCUIT NUMBER FOR G 5. PANEL SHALL BE WITH I 6. "*" DENOTES LOCK TYPE	NEUTRAL BU OPPER AND CTORY WITH ROUPING PU SOLATED GRO	IS. SUITABLE TYPEWRIT RPOSE O	TEN NLY.		LT—	ON BREA	KERS.	, <del>-</del>	т.



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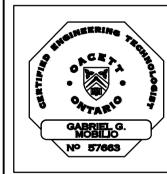
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City of Quinte West

ELECTRICAL PANEL SCHEDULES

Drawn DD/MU	Checked <b>BV</b>
Date June 2023	Scale N.T.S.
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E-900C

LS1 LC1	25W, 90CR1,3500°K, 50,000HRS,120V	SITE DOLE MOUNTED LUMINAIDE CAM CLASS DIFFUSED 16' HIGH F <sup>#</sup> W ALLIMINUM DOLE			
LC1	90CR1,3500°K, 50,000HRS,120V	SITE DOLE MOUNTED LUMINAIDE CAM CLASS DIFFUSED 16' HIGH F"W ALLIMINUM DOLE			
LC1	15W,	SITE POLE MOUNTED LUMINAIRE C/W GLASS DIFFUSER, 16' HIGH, 5"W ALUMINUM POLE AND TO OPERATE AT 120V C/W ALL MOUNTING ACCESSORIES	CAT: P15 SERIES GARDCO		
51	90CR1,3500°K, 50,000HRS,120V	4" DIAMETER RECESSED MOUNTED LUMINAIRE DOWNLIGHT AT 120V C/W 0-10V DIMMING DRIVER AND C/W ALL MOUNTING ACCESSORIES, LENS AND GASKETTED	PRESCOLITE CAT # LBRP-RD SERIES(SL MODULE)		
۱ ' <sup>د</sup>	2 X 7W LED A19 LAMP	SURFACE MOUNTED LUMINAIRE IN CORRIDORS, BEDROOM, ETC. TO OPERATE AT 120V. 8" DIAMETER C/W GLASS DIFFUSER.	CAT: AFX SERIES ROUND		
S2	3 X 9W LED A19 LAMP	SURFACE MOUNTED LUMINAIRE IN KITCHEN AREA TO OPERATE AT 120V. 15" DIAMETER C/W GLASS DIFFUSER.	OMNILUMEN  CAT: AFX SERIES ROUND OMNILUMEN		
S3	2 X 7W LED A19 LAMP	SURFACE MOUNTED LUMINAIRE IN KITCHEN AREA TO OPERATE AT 120V. 12" DIAMETER C/W GLASS DIFFUSER.	CAT: AFX SERIES ROUND OMNILUMEN		
S4	23W LED	BATH AND VANITY WALL SCONCE LED LIGHT TO OPERATE AT 120V. SURFACE MOUNTED C/W GLASS DIFFUSER & ALL MOUNTING ACCESSORIES. 36" LENGHT	CAT: CADET BFP LED TLI		
S5	12W LED, 120V	4" DIAMETER RECESSED SHOWER LUMINAIRE LED LIGHT TO OPERATE AT 120V C/W GLASS COVER & GASKET	PEERLESS CAT #		
S6	1 LED LAMP, 9W	UTILITY SURFACE MOUNTED GLOBE LUMINAIRE C/W BRACKET, GUARD & GLASS DIFFUSER.	PEERLESS CAT #		
	10W,	4' LENGTH, 1"W, 0.5"H RECESSED MOUNTED T-BAR LUMINAIRE DOWNLIGHT AT 120V C/W 0-10V DIMMING	DEEDLEGG		
LA1	90CR1,3500°K, 50,000HRS,120V	DRIVER AND C/W ALL MOUNTING ACCESSORIES	PEERLESS CAT # LBRP-RD SERIES(ML MODULE)		
LC1	25 <b>W</b> , 90CR1,3500°K, 50,000HRS,120V	4" DIAMETER RECESSED MOUNTED LUMINAIRE DOWNLIGHT AT 120V C/W 0-10V DIMMING DRIVER AND C/W ALL MOUNTING ACCESSORIES	PRESCOLITE CAT # LBRP-RD SERIES(ML MODULE)		
LC2	30 <b>W</b> , 90CR1,3500°K, 50,000HRS,120V	4" DIAMETER RECESSED MOUNTED LUMINAIRE DOWNLIGHT AT 120V C/W 0-10V DIMMING DRIVER AND C/W ALL MOUNTING ACCESSORIES	PRESCOLITE CAT # ARC LUX SERIES		
WA1	15W, 90CR1,3500°K, 50,000HRS,120V	WALL MOUNTED SCONCE LUMINAIRE, TYPE III AT 120V C/W 0-10V DIMMING DRIVER AND C/W ALL MOUNTING ACCESSORIES	TERON LIGHTING CAT # CADDY SERIES		
WA2	15W, 90CR1,3500°K, 50,000HRS,120V	WALL MOUNTED SCONCE LUMINAIRE, TYPE II AT 120V C/W 0-10V DIMMING DRIVER AND C/W ALL MOUNTING ACCESSORIES	TERON LIGHTING CAT # CADDY SERIES		
LP1	30W, 90CR1,4000°K, 50,000HRS,120V	4' LENGHT, NARROW STRIP LIGHT SURFACE MOUNTED LUMINAIRE C/W LENS AT 120V C/W 0-10V DIMMING DRIVER AND C/W ALL MOUNTING ACCESSORIES	COLUMBIA CAT # LCL SERIES		
LP2	40W, 90CR1,4000°K, 50,000HRS,120V	4' LENGHT, NARROW STRIP LIGHT SURFACE MOUNTED LUMINAIRE C/W LENS AT 120V C/W 0-10V DIMMING DRIVER AND C/W ALL MOUNTING ACCESSORIES	COLUMBIA CAT # LCL SERIES		
LT1	15 W LED, LED,90CRI, 400°K, 50,000 HRS, 120V	WALL MOUNTED ELEVATOR PIT LED LIGHTING C/W GLOBE GLASS AND GUARD 120V	PEERLESS CAT #		
хс	COMBINATION EXIT SIGN/EMERGENCY BATTERY UNIT C/W DOUBLE LED 7W MR16 HEADS AND ULTRA BRIGHT LED EXIT SIGN	GREEN PICTOGRAM EXIT COMBO C/W MR-16 LED HEADS IN ALUMINUM HOUSING TO OPERATE AT 120V/347V.	STANPRO CAT. #PRMXL SERIES		
ντ I	ULTRA BRIGHT LED EXIT SIGN, ARROW(S) INDICATE DIRECTION OF EXIT (EGRESS)TRAVEL	GREEN PICTOGRAM EXIT SIGN, ALUMINUM HOUSING, DIRECTIONAL FACES AS PER DRAWINGS FLOOR PLAN, UNIVERSAL MOUNTING. VOLTAGE TO MATCH EXISTING BASE BUILDING VOLTAGE. ELECTRICAL CONTRACTOR TO VERIFY. SINGLE, DOUBLE & UNIVERSAL FACES. 120/347V. SELF POWERED(120MIN).	STANPRO CAT. #RMXL SERIES		
ЕМ1	REMOTE EMERGENCY BATTERY 1 HEAD	LED REMOTE EMERGENCY HEADS. SINGLE AND DOUBLE HEADS AS NOTED ON DRAWINGS. 12/24VDC, 7W/HEAD, MR16	STANPRO CAT. #RMXL SERIES		
	REMOTE EMERGENCY BATTERY 2 HEADS		STANPRO		

LUMINARIES SCHEDULE

E-901 SCALE: N.T.S.

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32 UNIT AFFORDABLE HOUSING APARTMENT BUILDING 20 SOUTH STREET, TRENTON, ON


City of Quinte West

ELECTRICAL LUMINAIRES DETAILS

DD/MU	Checked <b>BV</b>
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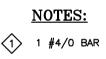
23-019

E-901

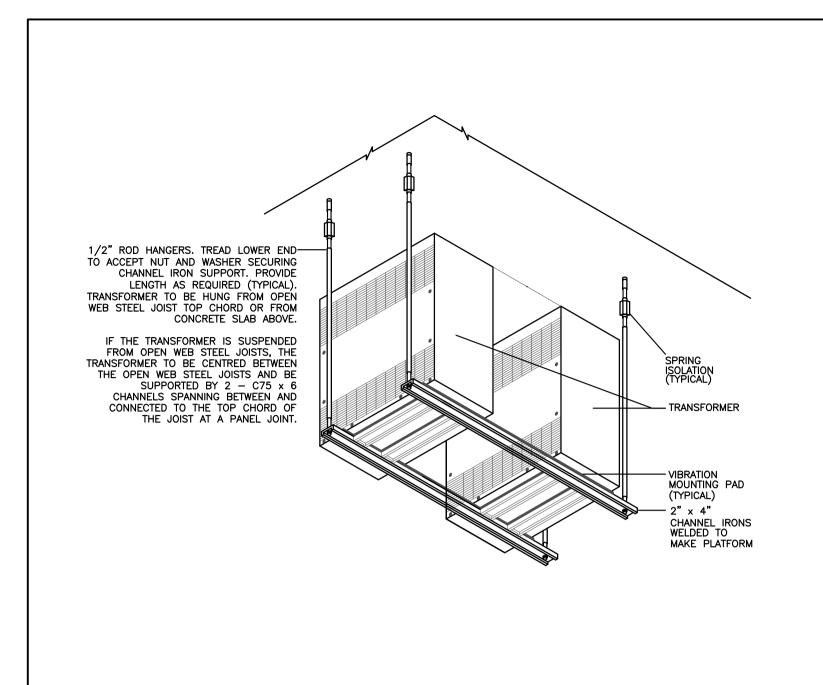


TRANSFORMER MOUNTING DETAIL

SCALE: N.T.S




- 1 #4/0 BAR STRANDED COPPER GROUND CONDUCTOR
- 4-20MM (DIA.) X3000MM (L) COPPER PLATED GROUND RODS INSTALLED UNDERGROUND.
- PERIMETER GROUND BUS, 1500MM(L) X 50MM(H) X 6MM(D) COPPER BAR C/W WALL MOUNTED INSULATOR SPACER.
- 4. BOND ALL NON CURRENT CARRYING METAL PARTS IN THE ELECTRICAL ROOM. DOORS, PANELS, ETC.

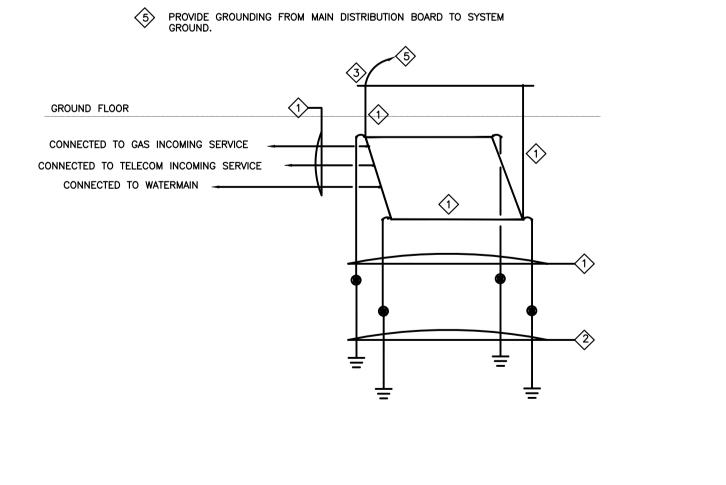


4 ELECTRICAL ROOM GROUNDING DETAIL

SCALE: N.T.S.

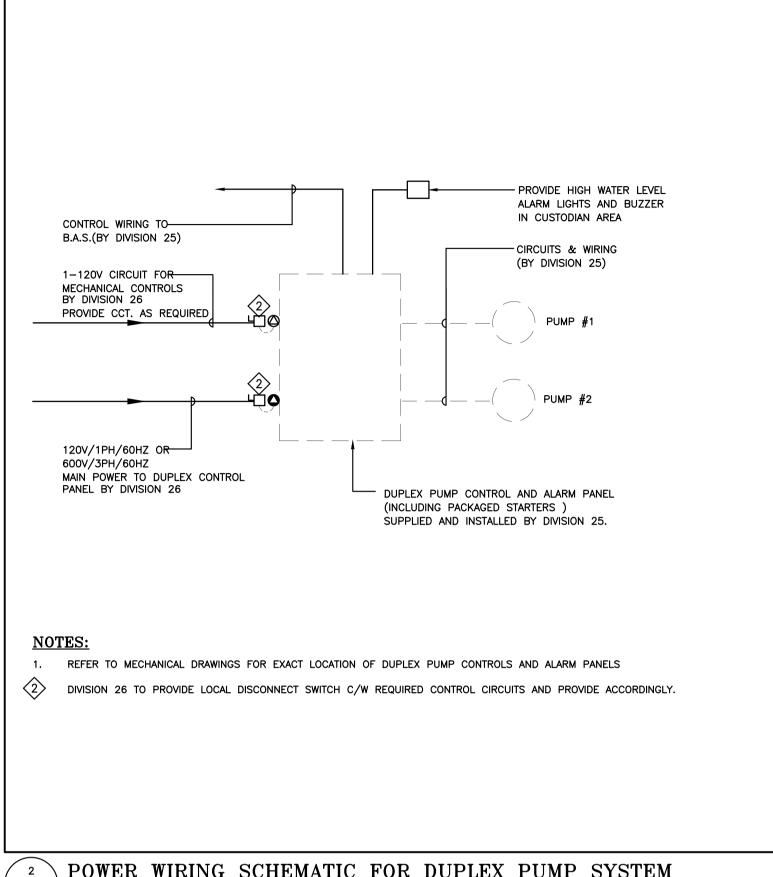

POWER WIRING SCHEMATIC FOR DUPLEX PUMP SYSTEM

SCALE: N.T.S

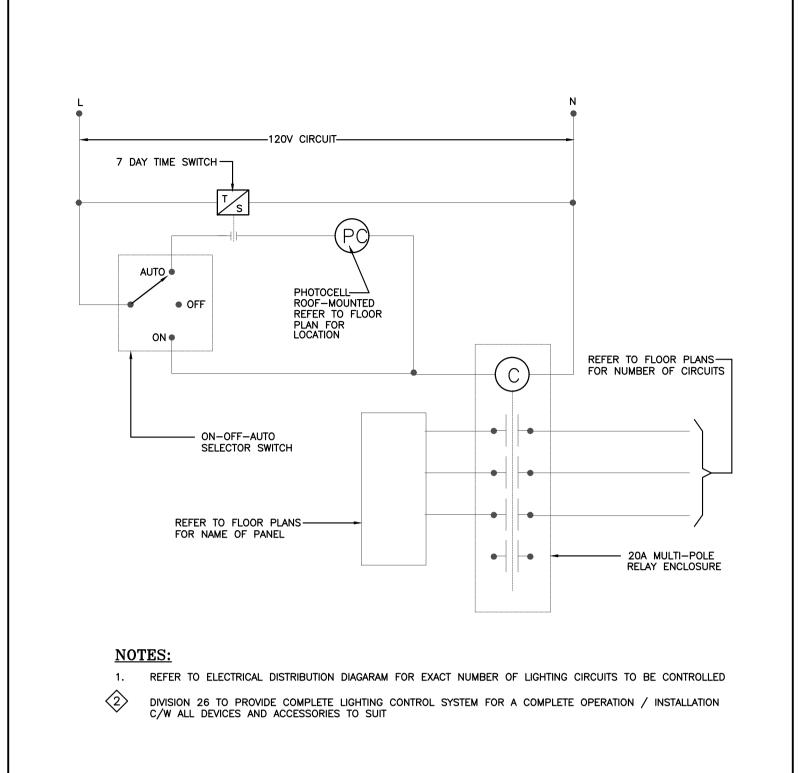

TYPICAL EXTERIOR LIGHTING CONTROL DIAGRAM

SCALE: 1:50

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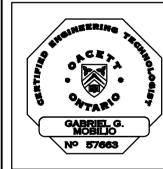
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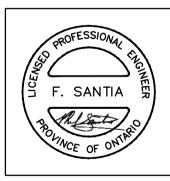
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Project T


32 UNIT AFFORDABLE HOUSING APARTMENT BUILDING 20 SOUTH STREET, TRENTON, ON


City of Quinte West

Sheet Title

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23-019	E-902



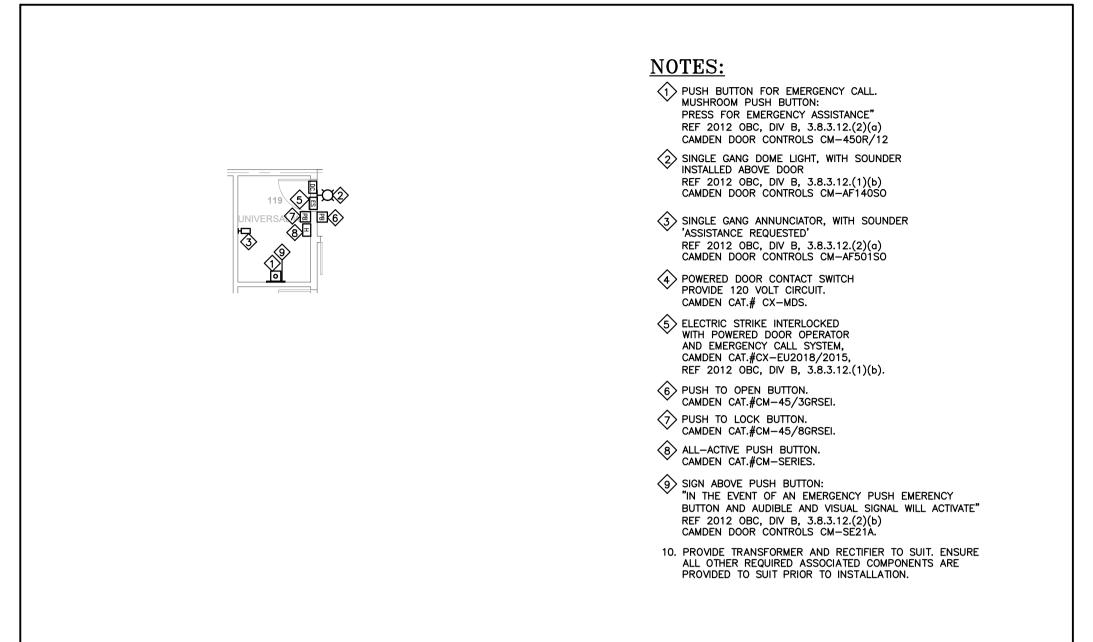

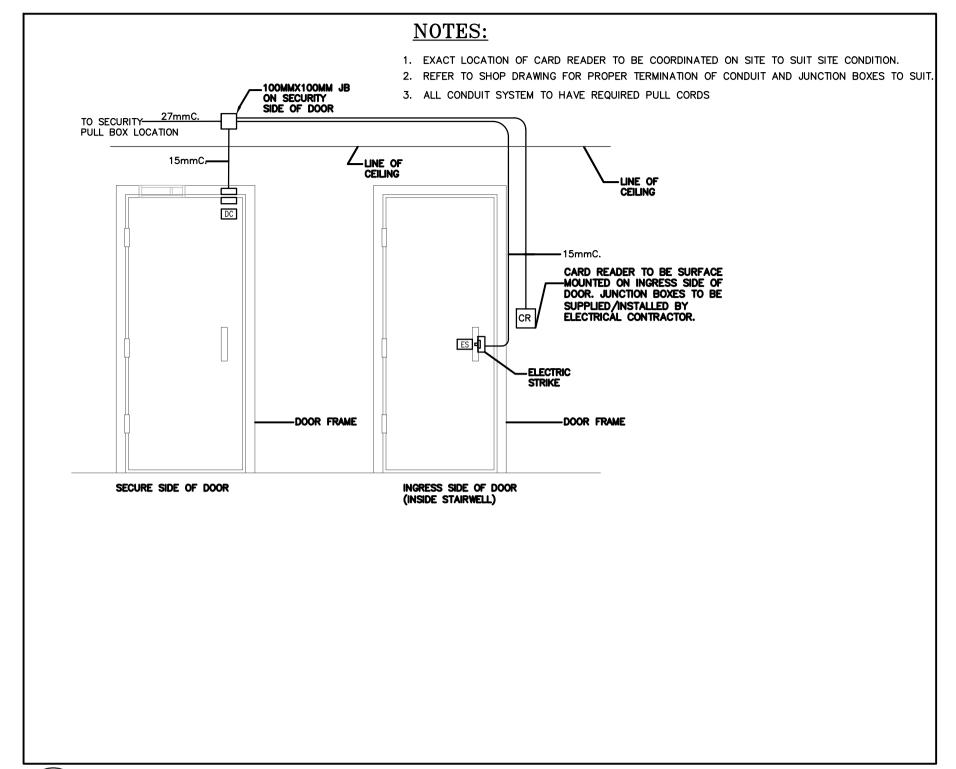
VINIVERSAL WASHROOM CALL SYSTEM DETAIL FLOOR PLAN

\ UNIVERSAL WASHROOM CALL SYSTEM DETAIL

E-903 SCALE: 1:100

E-903 SCALE: N.T.S

2 TYPICAL DOOR SECURITY DETAIL
E-903 SCALE: 1:50

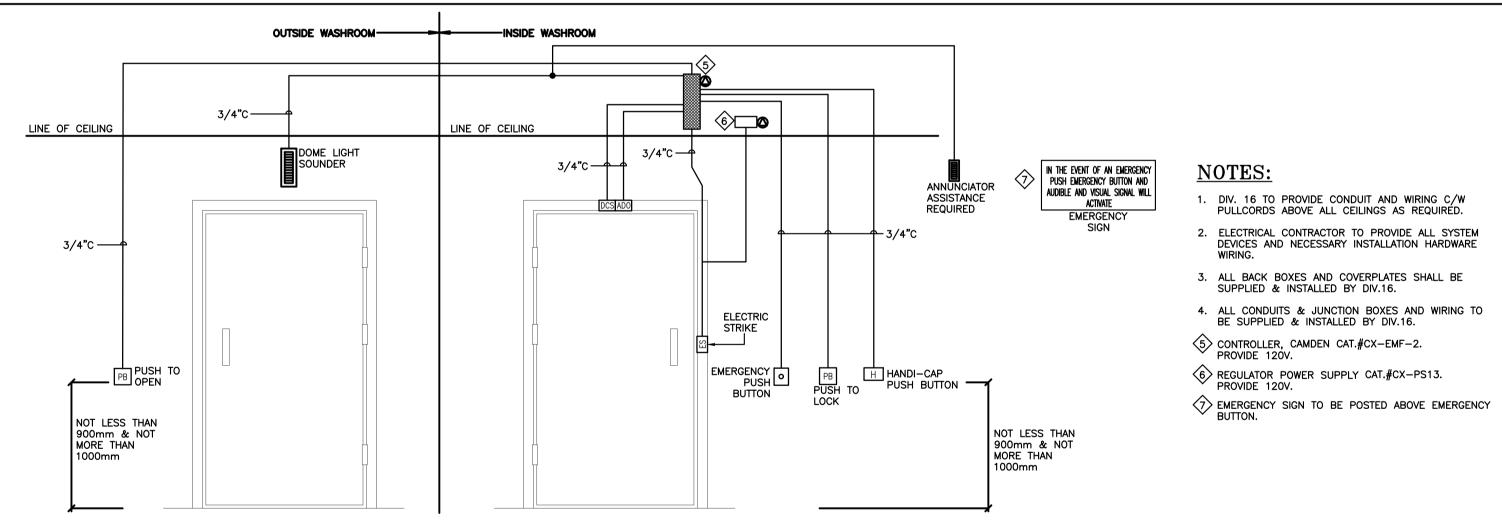

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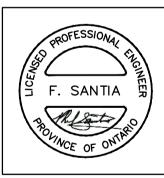
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