32 UNIT AFFORDABLE HOUSING APARTMENT BUILDING 20 SOUTH STREET, TRENTON, ONTARIO, K8V 1P8



SUPPORTING PEOPLE Hastings AND OUR COMMUNITIES

> **ISSUED FOR TENDER** JULY 31, 2024





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+	DWG #	TITLE/ DESCRIPTION
1	M.000	COVER
2	M.001	NOTES, LEGEND, SITE & DRAWING LIST
3	M.003	SCHEDULES
4	M.100A	NORTH BELOW SLAB PLUMBING & DRAINAGE PLAN
5	M.100B	SOUTH BELOW SLAB PLUMBING & DRAINAGE PLAN
6	M.101A	NORTH GROUND FLOOR PLUMBING & DRAINAGE PLAN
7	M.101B	SOUTH GROUND FLOOR PLUMBING & DRAINAGE PLAN
8	M.102A	NORTH SECOND FLOOR PLUMBING & DRAINAGE PLAN
9	M.102B	SOUTH SECOND FLOOR PLUMBING & DRAINAGE PLAN
10	M.103A	NORTH THIRD FLOOR PLUMBING & DRAINAGE PLAN
11	M.103B	SOUTH THIRD FLOOR PLUMBING & DRAINAGE PLAN
12	M.201A	NORTH GROUND FLOOR HVAC PLAN
13	M.201B	South ground floor hvac plan
14	M.202A	NORTH SECOND FLOOR HVAC PLAN
15	M.202B	South Second Floor HVAC Plan
16	M.203A	NORTH THIRD FLOOR HVAC PLAN
17	M.203B	South Third Floor Hvac Plan
18	M.300	ROOF
19	M.400	RISER DIAGRAMS
20	M.450	SCHEMATIC DIAGRAM
21	M.451	INSTALLATION DETAIL FOR A MODULATING CLOTHES DRYER EXHAUST SYSTEM
22	M.452	GAS RISER SCHEMATIC
23	M.500	DETAIL SHEET 1
24	M.501	DETAIL SHEET 2
25	M.502	DETAIL SHEET 3
26	M.503	DETAIL SHEET 4

GCS Project # 23006

GENERAL NOTES

- ALL DRAWINGS ARE DIAGRAMMATIC ONLY. THE ARRANGEMENTS OF EQUIPMENT SHOWN ARE APPROXIMATIONS ONLY AND MAY BE ALTERED BY THE ENGINEERS TO MEET THE REQUIREMENTS OF THI PROJECT. THESE DRAWINGS SHALL BE READ IN CONJUNCTION WITH THE ARCHITECT'S, INTERIOR DESIGNER, AND MECHANICAL DRAWINGS FOR LOCATION OF ALL LUMINAIRES, SWITCHES, DEVICES, OUTLETS, FURNITURE FEEDING POINTS, DIMENSIONS, MOUNTING HEIGHTS, AND CONSTRUCTION DETAILS.
- IN EVERY INSTANCE WHERE IT IS REQUIRED IN THE SPECIFICATION OR ON DRAWING THAT EQUIPMENT AND MATERIALS BE REMOVED FROM EXISTING LOCATIONS AND RE-INSTALLED, EITHER IN WHOLE OR IN PART IN NEW LOCATIONS, ALL SUCH EQUIPMENT AND MATERIALS SHALL BE THOROUGHLY CLEANED AND WHERE NECESSARY PUT INTO GOOD OPERATING CONDITION BEFORE BEING RE-INSTALLED IN THE NEW LOCATION. TEST ALL PARTS OF THE RE-USED OR RELOCATED ELECTRICAL EQUIPMENT AND CORRECT ALL FAULTS AND GROUNDS.
- ALL SLAB OPENINGS WILL BE X-RAYED AND REVIEWED WITH LANDLORD AND BASE BUILDING STRUCTURAL CONSULTANT. CONTRACTOR SHALL X-RAY THE FLOOR AND SUBMIT TO BASE BUILDING STRUCTURAL ENGINEER FOR WRITTEN APPROVAL AT LEAST 72 HOURS PRIOR TO ANY CORE DRILLING ON THE BUILDING. THE CONTRACTOR SHALL INCLUDE THE COST OF STRUCTURAL ENGINEER. COORDINATE ALL CORE DRILLING WITH LANDLORD'S SITE REPRESENTATIVE AND TENANT. ALL NOISY WORK SHALL BE PERFORMED AFTER HOURS.
- ALL OPENINGS IN BUILDING RISER, IF APPLICABLE, SHALL BE SEALED WITH APPROVED FIRE STOP MATERIAL. ANY FIREPROOFING MATERIAL REMOVED WILL BE REPLACED WITH A SUITABLE AND APPROVED FIREPROOFING MATERIAL AND SHALL BE INSTALLED AS PER BUILDING AND FIRE CODE.
- COORDINATE WITH THE CLIENT TO CONFIRM EQUIPMENT OR SYSTEMS/DEVICES TO REMAIN.
- CONTRACTOR SHALL BE RESPONSIBLE FOR ALL REFINISHING OF DAMAGED BUILDING AREAS AND FINISHES AFFECTED BY THE WORK AS OUTLINED UNDER SCOPE OF WORK OF THIS PROJECT.
- ALL INSTALLATIONS WITHIN EXISTING AREAS SHALL BE COORDINATED WITH OWNER AND BASE BUILDING MANAGEMENT. INSTALLATION MUST BE PERFORMED IN A MANNER TO ELIMINATE ANY INTERFERENCES TO STAFF AND NORMAL OPERATION OF THE FACILITY.
- THE CONTRACTOR IS RESPONSIBLE FOR THE INSTALLATION AND DISTRIBUTION OF TEMPORARY POWER WITHIN THE PREMISES DURING THE CONSTRUCTION PERIOD. EXPOSED ELECTRICAL CORDS OUTSIDE TH LEASED PREMISES SHALL NOT BE PERMITTED.
- CONTRACTOR SHALL BE RESPONSIBLE FOR COORDINATION OF ALL THE WORK WITH ALL OTHER TRADES, CONSULTANTS, AND THE OWNER. ALL WORK SHALL BE SCHEDULED AND CARRIED OUT BY THE CONTRACTOR IN A MANNER TO ENSURE CONTINUED AND NON-INTERRUPTED OPERATION OF EXISTING FACILITY.
- DUCT DIMENSIONS AND FLOWS ON DRAWINGS ARE EXPRESSED IN S.I. UNITS.

PIPING AND PLUMBING DIMENSIONS ON DRAWINGS ARE EXPRESSED IN I.P. UNITS.

DEMOLITION NOTES

- CONTRACTOR MUST CHECK AND VERIFY ALL DIMENSIONS AND REPORT ANY DISCREPANCIES BEFORE COMMENCING WORK. USE ONLY THE LATEST APPROVED DRAWING FOR CONSTRUCTION; PRINTS ARE NOT TO BE SCALED.
- ALL DRAWINGS TO BE READ IN CONJUNCTION WITH ARCHITECTURAL PLANS.
- ALL WORKS SHOWN ON DRAWINGS ARE NEW AND TO BE CARRIED OUT BY THE MECHANICAL CONTRACTOR (PLUMBER INCLUDED), UNLESS OTHERWISE NOTED.
- MECHANICAL CONTRACTOR WILL DO ALL CUTTING AND PATCHING WHERE REQUIRED FOR H.V.A.C. AND PLUMBING SYSTEMS.
- MECHANICAL CONTRACTOR SHALL VISIT SITE DURING THE TENDER PERIOD TO VERIFY EXISTING CONDITIONS NOT LIMITED TO THAT WHICH IS SHOWN ON THE PLANS OR WRITTEN TO THE SPECIFICATIONS AND INCLUDE FOR TO MAKE GOOD ALL REQUIREMENTS AS PER THE INTENT OF THESE CONTRACT DOCUMENTS FOR A FULLY OPERATIONAL TURN KEY INSTALLATION. IF ACCESS IS NOT PROVIDED FOR WHATEVER REASON, IT IS TO BE STATED IN THE TENDER QUOTATION IN CLEAR PRINT ACCORDINGLY.
- MECHANICAL CONTRACTOR TO MAKE ALL NECESSARY TEMPORARY PROVISIONS TO MAINTAIN H.V.A.C., PLUMBING AND DRAINAGE SYSTEMS FOR OCCUPIED AREAS DURING DEMOLITION AND CONSTRUCTION. ALL OF WHICH TO BE INCLUDED IN HIS CONTRACT. ALL ASSOCIATED NON MECHANICAL WORK, SUCH AS ELECTRICAL, TO BE CARRIED OUT BY THE GENERAL CONTRACTOR.
- MECHANICAL CONTRACTOR TO COMMISSION A BUILDING AUTOMATION SYSTEM TECHNICIAN TO ENSURE THAT SYSTEMS ARE NOT INTERRUPTED AS A RESULT OF THE CONSTRUCTION. MECHANICAL CONTRACTOR SHALL BE RESPONSIBLE FOR ALL REMEDIAL WORK TO THE AUTOMATION SYSTEM IN ITS ENTIRETY AS REQUIRED.
- MECHANICAL CONTRACTOR SHALL SUPPLY AND INSTALL NEW PLUMBING VENTS IN WALL AND CEILING SPACE WHERE EXISTING VENTS ARE REVEALED DURING DEMOLITION OF EXISTING PARTITIONS AND WALLS. MECHANICAL CONTRACTOR SHALL BE RESPONSIBLE TO SUPPLY & INSTALL NEW PLUMBING VENTS TO ACCOMMODATE NEW BUILDING DESIGN AND PARTITION LAYOUTS. ALL ASSOCIATED FLOOR CUTTING, IF REQUIRED, SHALL BE BY THE MECHANICAL CONTRACTOR.
- SUPPLY AND INSTALL NEW CLEANOUTS WHERE REQUIRED AS A RESULT OF FLOOR DEMOLITION AND UPGRADE.
- DRAIN EXISTING COLD WATER SYSTEM AFTER-HOURS FOR COLD WATER PIPING REMEDIAL WORK OR extension.
- MECHANICAL CONTRACTOR SHALL REBALANCE ALL EXISTING SYSTEMS AND UNITS BEING REUSED THAT HAVE BEEN ALTERED IN ANY WAY. REPLACE DRIVE KITS AND MOTORS WHERE REQUIRED. THE MECHANICAL CONTRACTOR WILL CLOSELY COORDINATE WITH THE ROOFING CONTRACTOR TO PREVENT ANY DAMAGE TO ROOF TOP EQUIPMENT.
- ALL CONTROL WIRING AND CONTROLS ARE TO BE REMOVED OR REPLACED BY THE MECHANICAL CONTRACTOR WHERE REQUIRED.
- MECHANICAL CONTRACTOR TO INCLUDE FOR RELOCATION OF ALL STARTERS AND THERMOSTATS NOT SHOWN ON DRAWINGS. VISIT SITE PRIOR TO TENDER CLOSING TO CONFIRM EXTENT OF ALL WORK. COORDINATE WITH THE GENERAL CONTRACTOR AND DIVISION 16, TO ENSURE THAT ALL ASSOCIATED WORKS ARE INCLUDED IN THE CONTRACT.
- COMPLETELY REMOVE AND DISCARD ALL CROSSED H.V.A.C. UNITS, SYSTEMS INCLUDING DUCTWORK, THERMOSTATS AND CONTROL WIRING, UNLESS OTHERWISE NOTED.
- MECHANICAL CONTRACTOR TO CONTACT LOCAL GAS COMPANY TO INFORM THEM OF THE REVISED GAS LOAD REQUIREMENTS AT THE IMMEDIATE START OF THE PROJECT. MECHANICAL CONTRACTOR SHALL MAKE ALL NECESSARY APPLICATIONS AND COMPLETE FORMS TO SATISFY THE REQUIREMENTS OF THE GAS COMPANY. MECHANICAL CONTRACTOR SHALL COORDINATE REMEDIAL GAS METER WORKS WITHIN THE CONSTRUCTION SCHEDULE AND BE RESPONSIBLE FOR ANY DELAYS.
- MECHANICAL CONTRACTOR TO MAKE ALL NECESSARY PROVISIONS FOR RELOCATED THERMOSTATS.
- SOME ASBESTOS REMOVAL MAY BE REQUIRED. PLUMBER TO VISIT SITE AND VERIFY PRIOR TO STARTING ANY WORK. REPORT ANY REMOVAL REQUIRED TO THE GENERAL CONTRACTOR AND ---. ASBESTOS REMOVAL SHALL BE PART OF THIS CONTRACT FOR DEMOLITION OF PIPING AND INSULATION.

This drawing is the property of the

Galang Consulting Services, and

must be returned upon completion

of the work. All information shown

on this drawing is for use on this

specific project. Contractor must

verify all dimensions on the job and

report any discrepancies to the

Architect before proceeding with

the work.


6	REISSUED FOR BUILDING PERMIT	MAR 14/24
5	ISSUED FOR PERMIT	FEB. 20/24
4	ISSUED FOR CLASS B COSTING	JAN. 19/24
3	ISSUED FOR COORDINATION	JAN. 12/24
2	ISSUED FOR COORDINATION	NOV.8/23
#	ISSUES	DATE


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1 ISSUED FOR TENDER	JUL 31/24	
) ISSUED FOR TENDER	JUL 12/24	
ISSUED FOR TENDER	JUN 28/24	
REISSUED FOR BUILDING PERMIT	JUN 24/24	G
ISSUED FOR TENDER	APR 08/24	
REVISIONS	DATE	

PIPING SYMBOL LEGEND

	PIPING STMI	BUL LEU	AEND
	DOMESTIC COLD WATER	Ø	FLOOR CLEAN OUT
	DOMESTIC HOT WATER		WALL CLEAN OUT
	DOMESTIC HOT WATER RECIRC	[CAPPED PIPE / CLEAN OUT
CD	CONDENSATE DRAIN		FLEXIBLE CONNECTION (PIPE)
—— GL ——	GLYCOL SUPPLY	+	HOSE BIBB
GL	GLYCOL RETURN	() <u>RD</u>	ROOF DRAIN
— HWS —	HOT WATER SUPPLY	$\textcircled{\bullet}$	SECONDARY ROOF DRAIN
HWR	HOT WATER RETURN	(E)	EXISTING
ST ST	STORM, STORM BURIED/BELOW	-#	WALL HYDRANT
SAN	SANITARY, SANITARY BURIED/BELOW		UNION
- (111)	PIPING TRACING	P	FLOW SWITCH
C	PIPING TURN DOWN OR DROP		PRESSURE SWITCH
0	PIPING TURN UP OR RISE	EJ	EXPANSION JOINT
	PIPING TEE DOWN OR DROP	AV	AUTOMATIC AIR VENT
0	PIPING TEE UP OR RISE	Q	PRESSURE GAUGE WITH GAUGE COCK
°C	P-TRAP	€€	VALVE ON PIPING RISE OR DROP
	GATE VALVE		TRAP PRIMER
	BALL VALVE	Q	THERMOMETER
	MIXING VALVE		DIRECTION OF FLOW
, ø `	BUTTERFLY VALVE		SLOPE & DIRECTION OF FALL
	GLOBE VALVE		REDUCER OR INCREASER
	PRESSURE REDUCING VALVE	ø	DIAMETER
	BACKFLOW PREVENTER	0 <u>fD</u>	FLOOR DRAIN
	BALANCING VALVE	O <u>FFD</u>	FUNNEL FLOOR DRAIN
	AUTOMATIC FLOW CONTROL VALVE	—— G ——	GAS LINE. GAS PIPING SCHEDULE
	TEMP. & PRESSURE RELIEF VALVE	0	40 & TO CODES.
	PRESSURE RELIEF VALVE	V	DHW COMBUSTION EXHAUST VENTING
	MOTORIZED SHUT-OFF VALVE	—— A ——	DHW COMBUSTION AIR MAKEUP
	STRAINER		


	AIR SYSTE	M LEGE	ND
	RECTANGULAR SUPPLY/ OUTSIDE AIR DUCT UP		FLEXIBLE DUCT
	RECTANGULAR SUPPLY/ OUTSIDE AIR DUCT DOWN	CFM	SPACE PRESSURIZATION ARROW
	RECTANGULAR RETURN/ RELIEF AIR DUCT UP	DL/ UC-1-	DOOR LOUVER / UNDERCUT DOOR
	RECTANGULAR RETURN/ RELIEF AIR DUCT DOWN	-	SUPPLY AIRFLOW ARROW
	RECTANGULAR EXHAUST AIR DUCT UP	-\	RETURN OR EXHAUST AIRFLOW ARROW
	RECTANGULAR EXHAUST AIR DUCT DOWN	\square	CEILING DIFFUSER (SUPPLY)
\square	ROUND SUPPLY/ OUTSIDE AIR DUCT UP		RETURN AIR GRILLE OR REGISTER
$\square \otimes$	ROUND SUPPLY/ OUTSIDE AIR DUCT DOWN		EXHAUST AIR GRILLE OR REGISTER
	ROUND RETURN/ RELIEF AIR DUCT UP	XX	
	ROUND RETURN/ RELIEF AIR DUCT DOWN	AXX	-NECK SIZE -CFM
	ROUND EXHAUST AIR DUCT UP		SIDE WALL GRILLE
	ROUND EXHAUST AIR DUCT DOWN	F/D	FIRE DAMPER
	DUCT WITH LINING OR SOUND INSULATION	(H) X	HUMIDITY SENSOR OR HUMIDISTAT AND NUMBER
	STAINLESS STEEL DUCT	<u>(5) X</u>	SENSOR AND NUMBER
	PVC COATED DUCT	Ś₩ X	SWITCH AND NUMBER
	DOUBLE WALL DUCT	<u> </u>	TEMPERATURE SENSOR OR THERMOSTAT & ZONE NUMBER
BDD	BACKDRAFT DAMPER FOR ROUND AND RECTANGULAR DUCT	DP	DIFFERENTIAL PRESSURE SENSOR
FD T	FIRE DAMPER FOR ROUND AND RECTANGULAR DUCT	SP	STATIC PRESSURE SENSOR
SD I	SMOKE DAMPER FOR ROUND AND RECTANGULAR DUCT	(0_2)	OXYGEN SENSOR
SFD	COMBINATION SMOKE/FIRE DAMPER FOR ROUND & RECTANGULAR DUCT	(CO)	CARBON MONOXIDE SENSOR
VD VD	MANUAL VOLUME DAMPER FOR ROUND AND RECTANGULAR DUCT	02	CARBON DIOXIDE SENSOR
	FLEXIBLE CONNECTION	##"X##"	DIFFUSER SIZE
	MECHANICAL	LINEWO	RK LEGEND
		RL-	

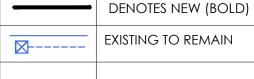

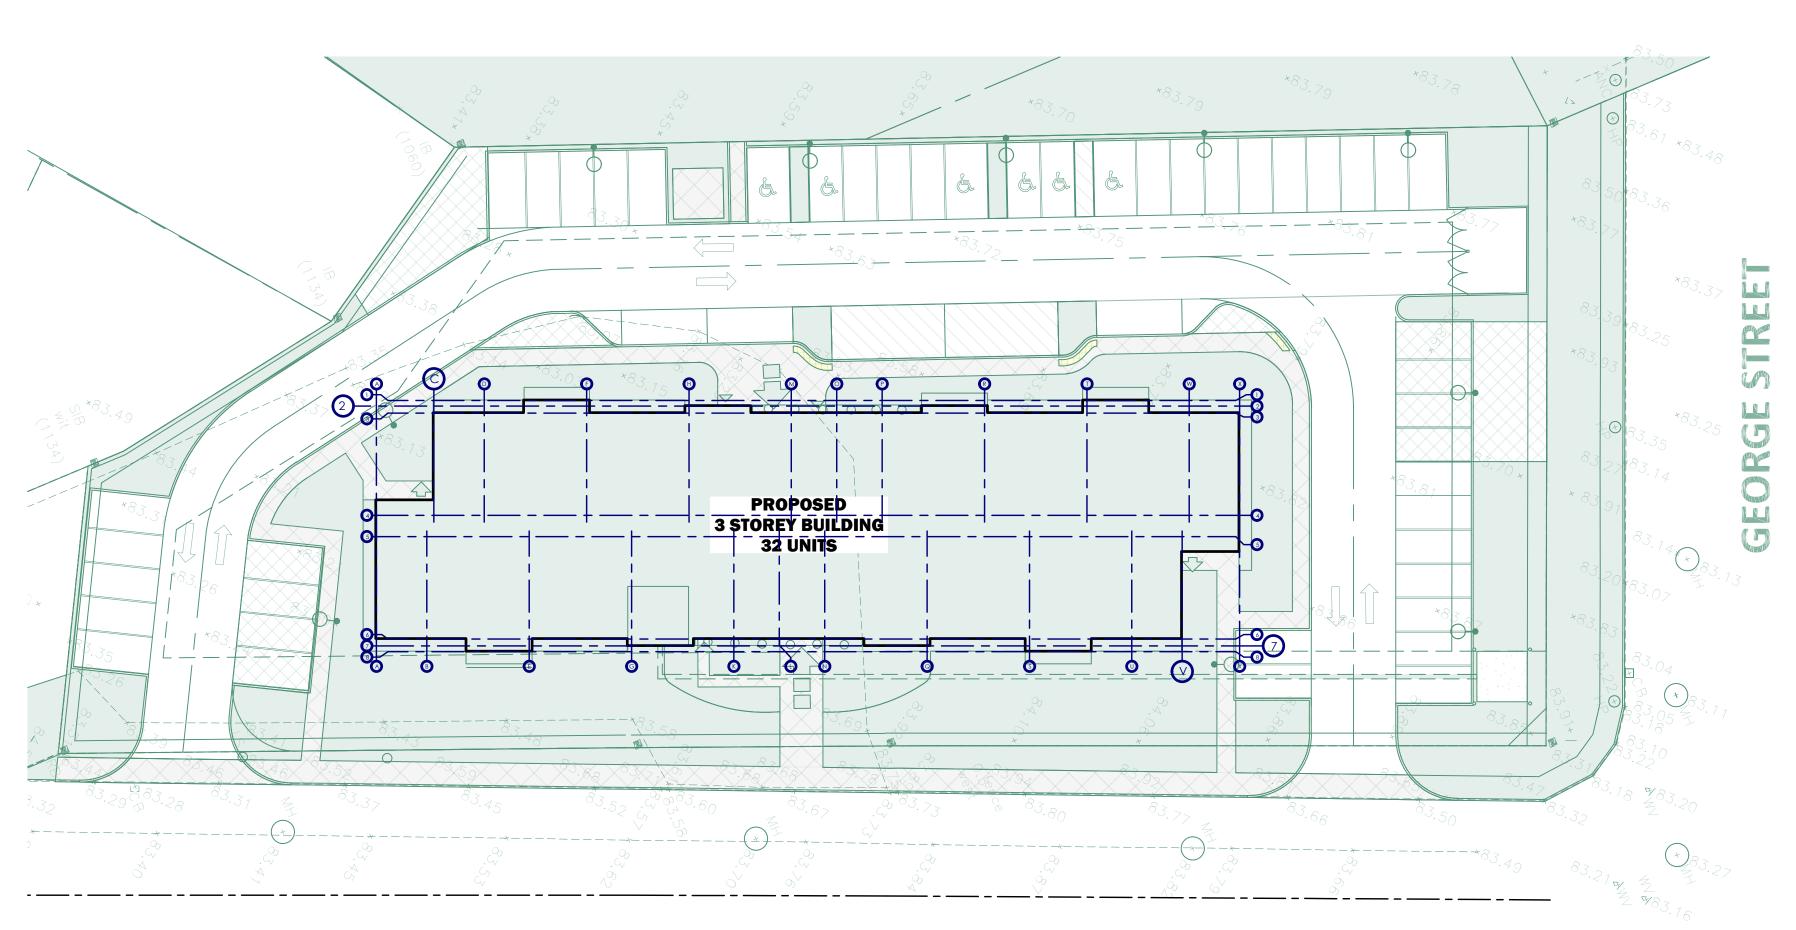

DENOTES TO BE RELOCATED


41111111 1441111	DENOTES EXISTING TO BE REMOVED

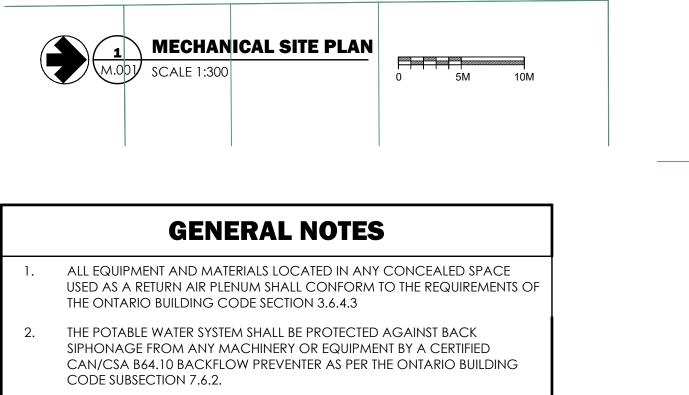

- FOR PIPE OFF-SETS (E.G.: WASHROOMS LOCATED ABOVE SENSITIVE AREAS, ETC.) PROVIDE 25MM (1") THICK FIBERGLASS, COVERED WITH 2MM 'ACUSEAL' TO SANITARY OR STORM ELBOWS FROM DRAINS OR PIPES ABOVE AND THE FIRST 1.5M (5'-0") OF HORIZONTAL RUN AFTER THE ELBOW.
- ALL DRAINS INDICATED ON THE MECHANICAL DRAWINGS OR OTHERWISE SHALL INCLUDE ALL NECESSARY FITTINGS, AND PIPING SUFFICIENT FOR CONNECTION TO THE NEAREST SANITARY TRUNK OR STACK.
- SUPPLY AND EXHAUST FANS INTAKE AND EXHAUST DUCTS CONNECTING TO THE EXTERIOR SHALL COMPLY WITH OBC SB-10 AND ASHRAE 90.1. CAPACITIES UP TO 141L/S (300CFM) C/W BACK DRAFT DAMPER CAPACITIES EXCEEDING 141L/S (300CFM) C/W MOTORIZED DAMPER COORDINATE WITH SECTION 15900 (AND DIV. 16) FOR INTERLOCK WITH RELATED FAN(S).
- SUITES SIDEWALL SUPPLY AIR DIFFUSERS ALL SIDEWALL SUPPLY AIR DIFFUSERS MUST BE INSTALLED AS HIGH AS POSSIBLE. TOP SIDE OF SIDEWALL DIFFUSERS MUST BE MAXIMUM 150MM BELOW FINISHED CEILING OR BULKHEADS.
- MUA RISERS TO BE INSTALL SO AS TO PREVENT THE DUCT AND DUCT SUPPORTS FROM MAKING CONTACT WITH SUITE WALL ASSEMBLIES.
- DAMPERS PROVIDE BALANCING DAMPERS AT BRANCH DUCTS. PROVIDE FIRE DAMPER(S) ON ALL DUCTWORK THAT PENETRATE THROUGH FIRE RATED WALL PARTITIONS.

	TAGS AND CAL	L OUT S	YMBOLS
EQUIP	EQUIPMENT REQUIRING ELECTRICAL SERVICE. REFER TO	#	REVISION CALLOUT
#	SCHEDULES FOR PERFORMANCE REQUIREMENTS.	$\left(1 \right)$	KEYNOTE CALLOUT
EQUIP	EQUIPMENT <u>NOT</u> REQUIRING ELECTRICAL SERVICE. REFER TO	\bigcirc	POINT OF CONNECTION
#	SCHEDULES FOR PERFORMANCE REQUIREMENTS.	\bigotimes	POINT OF DEMARCATION
	SECTION CALLOUT — SECTION DESIGNATION	E	FURNISHED & INSTALLED BY ELECTRICAL
P3.1	– SHEET NUMBER	M	FURNISHED & INSTALLED BY MECHANICAL
A	DETAIL CALLOUT - DETAIL DESIGNATION	P	FURNISHED AND INSTALLED BY PLUMBING
P3.1	- SHEET NUMBER	S E 1 1	HEAT TRACE CIRCUIT START AND END HEAT TRACE CIRCUIT NUMBER
	– DIFFUSER TYPE		-VAV ID
	– NECK SIZE	6" VAV-1 300 CFM	CFM
XX	– CFM		- VAV INLET SIZE



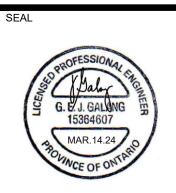






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SOUTH STREET



SITE STATISTICS								
INFORMATION								
ADDRESS:	20 South St, Quinte West, Ontario, K8V 1P8							
LEGAL DESIGNATION: ZONING DESIGNATION: PROPOSED BUILDING:	R4-10 (FORMERLY CF) 32-UNIT AFFORDABLE HOUSING BUILDING, 3- STOREY NEW BUILDING							
	PERMITTED/ REQUIRED	PROPOSED						
Setback								
MIN. FRONT YARD	7.5 M	-						
MIN. EXTERIOR SIDE YARD	7.5 M	-						
MIN. INTERIOR SIDE YARD	7.5 M	-						
MIN. REAR YARD	7.5 M	-						
HEIGHT	15 M	-						
MINIMUM LOT AREA	160 SM PER UNIT= 5120 SM	5168.9 SM						
MINIMUM LOT FRONTAGE	25 M	117.6 M						
MINIMUM LANDSCAPE OPEN SPACE	25%	-						
GROUND FLOOR	1200	SM						
SECOND FLOOR	1200	SM						
THIRD FLOOR	1200	SM						
TOTAL	3600 SM							
PARKING CALCULATION 1.25 SPACES PER UNIT, PLUS .25 SPAC	ES PER UNIT DEDICA							

PARKING IN A BUILDING CONTAINING 4 OR MORE DWELLING UNITS

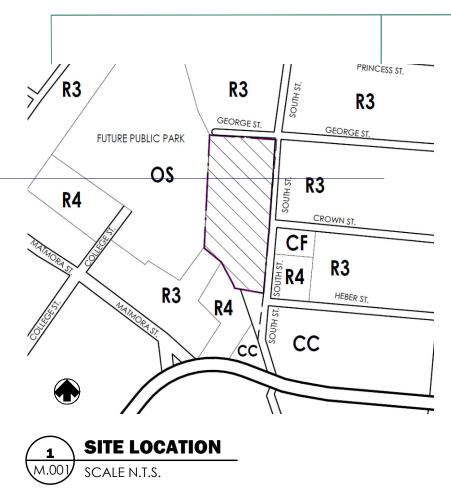PARKING REQUIRED 32 UNITS X 1.25= 40 PARKING REQUIRED (5.3M X 2.9M) INCLUDING


32 UNITS X 0.25= 8 PARKING WILL BE DEDICATED FOR VISITOR PARKING 2 BARRIER-FREE SPACE REQUIRED

PARKING PROVIDED

40 PARKING PROVIDED (5.3M X 2.9M) INCLUDING **48** PARKING SPACES PROVIDED 6 BARRIER-FREE SPACES PROVIDED

LOADING AREA REQUIRED

2 LOADING AREA REQUIRED (9M X 3.5M)

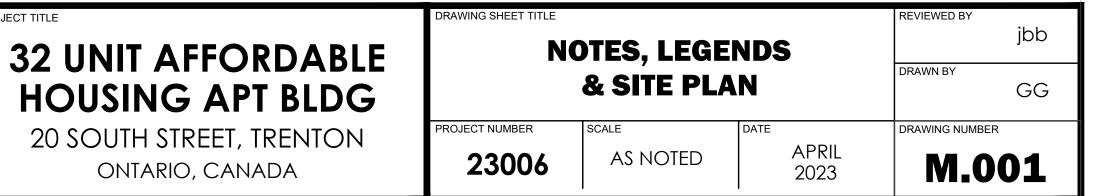

PUMP S	CHEDULE																										
															P	OWER SUPPLY				STARTER			CONTROLS		OTHER REQUIREMENTS		REMARKS:
REFERENCE	DESCRIPTION	LOCATION (GPM)	HEAD (PSI) RPM	MANUFACTURE R	MODEL	TYPE / SIZE	DIM	ENSIONS (r WIDTH	nm) HEIGHT	WEIGHT (Kg.)	ENERGY REQUIRED (kW)	MOTOR SIZE (HP)	FLA	VOLTS	PHASE	FED FROM	EM.	NORM.	SUPPLIED BY:	INSTALLED BY:	TYPE	MANUAL	AUTO.	INTERLOC K BY:	DISC. AT MOTOR	W.P. DISC. AT MOTOR F.A. SHUT.	
FIRE PUMPS																	•	•									
FP-101A	DUTY FIRE PUMP	MECH. ROOM 750	427 3600	S.A. ARMSTRONG	6x4LA-F	VIL	660	504	871	257		20	-	208	3	REFER SLD	YES	-	DIV. 21	DIV. 21	PKG	-	YES	DIV. 21	YES		PACKAGE UNIT ULC AND FM LABELED C/W CONTROLLER REDUCED VOLTAGE STARTER TRANSFER SWITCH, AUTO TRANSFER SWITCH AND TORNATECH-GPA-GPU-600/150/3/60 CONTROLLER. RATED HEAD = 40 PSI, DISCHARGE HEAD = 112 PSI,
FP-101B	STANDBY FIRE PUMP	MECH. ROOM 750	427 3600	S.A. ARMSTRONG	6x4LA-F	VIL	660	504	871	257		20	-	208	3	REFER SLD	YES	-	DIV. 21	DIV. 21	PKG	-	YES	DIV. 21	YES		PACKAGE UNIT ULC AND FM LABELED C/W CONTROLLER REDUCED VOLTAGE STARTER TRANSFER SWITCH, AUTO TRANSFER SWITCH AND TORNATECH-GPA-GPU-600/150/3/60 CONTROLLER. RATED HEAD = 40 PSI, DISCHARGE HEAD = 112 PSI,
FP-102	JOCKEY PUMP	MECH. ROOM 7.5	15 3600	S.A. ARMSTRONG	SERIES 4700	VMS-03:14B	210	251	748	48		3	-	575	3	REFER SLD	YES	-	DIV. 21	DIV. 21	PKG	-	YES	DIV. 21	YES		PACKAGE UNIT ULC AND FM LISTED C/W TORNATECH-JP3-600/3/3/60 CONTROLLER . PUI TO BE BE RATED FOR 350 PSI

	MAKE UP AIR UNIT SCHEDULE															
					Evaporator Fan	Cooling	Heating	Electrical				Rated Performance			Electrical	
Tag #	Room Name	Qty	Manufacturer	Indoor Unit Model Number	CFM	МВН	kW	Voltage	Sound dB(A)	Dimensions (WxDxH) in	Weight (lb)	MRE	EER MRC	Refrigerant	MCA (A)	MOCP (A)
					Airflow High to Low											
MUA-1		1	Johnson Controls	JROA-120	2500	131	60	575V/3P	74	148 x 64 x 66	2168	5.5 lb/kWH	13.9 47.29 lb/h	R-410A	63.9	70
MUA-2		1	Johnson Controls	JROA-120	2500	131	60	575V/3P	74	148 x 64 x 66	2168	5.5 lb/kWH	13.9 47.29 lb/h	R-410A	63.9	70

Notes for Ventum+ ERV

1. 24" ROOF CURB

2. Factory wired non-fused disconnect switch with internal circuit breaker isolation 3. Units shall include factory mounted BACnet IP controls with BTL Certification

4. Filter monitoring with remote alarm via differential pressure measurement across the filter

14. Airflow measuring on supply fans via differential pressure measurement

5. Certifications: UL, CSA

6. Factory mounted DX coils with stainless steel drain pan, utilized for supply air temperature control

7. Ship loose temperature sensor for discharge air temperature control

8. Factory mounted and brazed Daikin's Electronic Expansion Valves (EEV) and factory wired Daikin controller(s) 9. Unit and Daikin controller(s) to be single-point power. Factory to provided Modbus wiring.

10. Electric heater will require a separate power connection

	EXHAUSTFAN SCHEDULE												
TAG	LOCATION	SERVING	QTY	MFR	Model #	Flow(CFM)	SP(InchWC)	RPM	Power(HP)	Bectrical	Speed Control	Comments	
E -1	RM112	ELECROOM	1	TWINATY	T500L	1/4"		890	232W	115V/1PH/60HZ	YES(57W)	C/WV104 MBRATION HANGERS, 69WON/OFF SWITCH	
E -2	R M111	MECH ROOM	1	TWINCITY	T500L	1/4"		890	232W	115V/1PH/60HZ	YES(57W)	C/WV104 MBRATION HANGERS, 69WON/OFF SWITCH	
EF -3	RN 116	SCOOTERROOM	1	TWINCITY	T900L	1/2"		810	306W	115V/1PH/60HZ	YES(57W)	C/WV104 MBRATION HANGERS, 69WON/OFF SWITCH	
EF-4	RM 118	GARBAGEROOM	1	TWINCITY	T500L	1/4"		890	232W	115V/1PH/60HZ	YES(57W)	C/WV104 MBRATION HANGERS, 69WON/OFF SWITCH	
EF-5	RM 60	WASHROOMS	1	TWINCITY	T300L	1/2"		1145	212W	115V/1PH/60HZ	YES(57W)	C/WV104 MBRATION HANGERS, 69WON/OFF SWITCH	
EF-6	RM112	STORAGE	1	TWINGTY	T250L	1/4"		1005	166W	115V/1PH/60HZ	YES(57W)	C/WV104 MBRATION HANGERS, 69WON/OFF SWITCH	
E -7	RM215&RM315	ELECROOM	2	TWINCITY	T400L	1/4"		775	146W	115V/1PH/60HZ	YES(57W)	C/WV104 MBRATION HANGERS, 69WON/OFF SWITCH	
EF-8	ROOF	DRYEREXHAUST2ND FLOOR	1	ENERVEX	BEX 300	750	1	2000	1				
EF -9	ROOF	DRYEREXHAUST3RD FLOOR	1	ENERVEX	BEX 300	750	1	2000	1				

NOTES:

1) All Fans shall be complete with Vibration isolators.

2) c/w Flexible Connections. 3) c/w Speed Control and tied into BAS

	SPLIT UNIT SCHEDULE																						
					Evaporator Fan	Cooling	Heating	Electrical			Rated Performance							Electrical					
Tag #	Room Name	Qty	Manufacturer	Indoor Unit Model Number	CFM Airflow High to Low	BTU/h	BTU/h	Voltage	Sound Pressure Level High to Low dB(A)	Dimensions (WxDxH) mm	Weight (Ib)	SEER2	EER2	HSPF2	Tag #	Outdoor Unit Model Number	Refrigerant	Voltage	MCA (A)	MOCP (A)	Dimensions (WxDxH) mm	Weight (lb)	Remarks
AC-1	VARIOUS	REFER TO DRGS	Johnson Controls	RPK-1.5	364-312-253	12,000	12,000	208-230/1	42-32-26	934 x 270 x 210	19.8	21.5	13.1	9	CU-1	RAS-1.5	R-410A	208-230/1	12	20	810 x 580 x 280	79.4	
AC-2	ELIVATOR SHAFT	REFER TO DRGS	Johnson Controls	RPK-1.5	364-312-253	12,000	12,000	208-230/1	42-32-26	934 x 270 x 210	19.8	21.5	13.1	9	CU-1	RAS-1.5	R-410A	208-230/1	12	20	810 x 580 x 280	79.4	

NOTES:

Wall Mount Indoor Units will be loose supplied condensate pumps, field installed by contractor. 1

2 Each Indoor Unit is to be powered from respective Outdoor Unit.

Outdoor Unit will be placed on 18" high stand. 3

4 Contact Badri Patel at badri.patel@jci.com/416-892-3032 for pricing. 5 Each Indoor Unit will be supplied with its own Wired Controller.

Unit will be with wind baffle. 6

7 Units will be provided with BAS connectivity.

	23006-Hastings Affordable Housing - Air Source Heat Pump Schedule																		
				External	,		Cooling				Heating			Electrical					
			Airflow	Static	dB(A) @	EAT			Outdoor		EAT LAT				Compres	Fan	Total		
TAG	Model	Capacity	(CFM)	Dressure	rated Capacity	EDB (°F)	EWB (°F)	Total (Btu/hr)	EDB (°F)	EWB (°F)	EDB (°F)	LDB (°F)	Total (Btu/hr)	Voltage	RLA	FLA	LRA	MCA (A)	Max Fuse
HP-1	Pentair V12	FULL	250	1.0	43	80.0	67.0	8734	17.0	15.0	60.0	70.0	5606	120v	6.6		39.0		
Notes:-																			

1) each HP comes c/w 2 fans and motors each rated at 136W 120v 1ph 60Hz 12.3A circuit with a 15A breaker.


2) Each unit comes c/w a Hermetic Rotary Compressor 725w, 6.6A RLA, 39A LRA.


3) Unit to be complete with Merv* & MERV 15 Filters. Units to be supplied with 2 spare sets of filters. 1 to be installed at handover and 1 Handed over to client for future use at xompletion of the project. 4) Each unit to be supplied with a 5kw Electric heater to be mounted seperately and powered seperately but controlled by the main HP.

5) Electrical heater to be a 240V/1ph/ 20.8Amps (60Hz).

3 ISSUED FOR COORDINATION JAN. 12/24 8 REISSUED FOR BUILDING PERMIT JUN 24/24 4 2 ISSUED FOR COORDINATION NOV.8/23 7 ISSUED FOR TENDER APR 08/24 * # ISSUES DATE # REVISIONS DATE	
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SPACE

UNIT HEATER / FORCE FLOW HEATER/ ELECTRIC BASEBOARD HEATER SCHEDULE

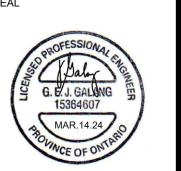
	-			
RVED	SELECTION	HEATING CAPACITY	POWER	REMARKS
ОМ	OUTLET OCC-RF	4800/3600W	208/ 1PH	PROVIDE THERMOSTATE
OOM	OUTLET OCC-RF	4800/3600W	208/ 1PH	PROVIDE THERMOSTATE
ROOM	OUTLET OCC-RF	4800/3600W	208/ 1PH	PROVIDE THERMOSTATE
ROOM	OUTLET OCC-RF	4800/3600W	208/ 1PH	PROVIDE THERMOSTATE
TAIR TAIR IANCE IVULE(2)	OUTLET OAWH04008-TAV	4000W	208V / 1PH	
CE	OUTLET OCB	1100W	208V / 1PH	UNIT TO BE 4FT LONG AND WITH FLOOR MOUNTING FEE
ROOM	OUTLET OAWH04008-TAV		208V / 1PH	

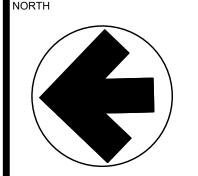OARD HEATER SHALL BE CONTROLLED USING THE VRF FAN COIL SPACE THERMOSTAT TO SUPPLEMENT THE FAN COIL HEAT PUMP NG CAPABILITY BASEBOARD HEATERS C/W BOTTOM AIR INLET & PEDESTAL LECTED AT SHOP DRAWING STAGE

GRILLE AND DIFFUSER SCHEDULE ACCESSORIES TYPE REMARKS SELECTION ΊCΕ NAILOR MODEL RNSA 24"X24" (T-BAR SQUARE CONE ALUMINUM CONSTRUCTION NOTE 1, 2, 3 CEILING) C/W O.B. DAMPER, LOUVER FACE SCD/31/600x600 IFFUSER DIFFUSER - STEEL CONSTRCTION NAILOR, MODEL 80/TB/B12 (T-BAR CEILING) ½"x ½"x ½" EGGCRATE GRILLE WITH CHANNEL FRAME - ALUMINUM EGGCRATE TYPE EGGCRATE C/W BORDER GRILLE NOTE 1, 2, 3 CONSTRUCTION NAILOR, MODEL 80/TB/B12 (T-BAR CEILING) ½"x ½"x ½" EGGCRATE GRILLE WITH CHANNEL FRAME - ALUMINUM EGGCRATE TYPE EGGCRATE C/W BORDER NOTE 1, 2, 3 GRILLE CONSTRUCTION EGGCRATE C/W BORDER NOTE 1, 2, 3 GRILLE SERIES 80, 600x600 EGGCRATE C/W BORDER NOTE 1, 2, 3 GRILLE SERIES 80, 300x300

ND AIR FLOW SEE DWGS 6. TYPE 'D' NAD KLIMA PRE-ENGINEERED DUCT & DIFFUSER SHALL HAVE THE FOLLOWING SPECIFICATIONS: SUPPLY AND INSTALL ENGINEERED NAD KLIMA RRA-RN HIGH INDUCTION DUCT DIFFUSERS, WITH FACTORY ASSEMBLED DUCT DIFFUSER SECTIONS AND DIFFUSERS PRE-INSTALLED. DIFFUSERS SHALL HAVE 100MM ER/NR DRUMS INTEGRATED INTO THE SLOTS WITH AN AIRFLOW PATTERN ADJUSTABILITY OF 180 DEGREES. DIFFUSERS SHALL BE DESIGNED FOR LESS THAN 30FPM IN THE OCCUPIED OFFICE ZONE AT 4FT AFF; LESS THAN NC35 SOUND LEVEL, AND LESS THAN 1-DEGREE TEMPERATURE DIFFERENTIAL ACROSS THE FINISHED FLOOR. NAD KLIMA RRA DUCT DIFFUSER SECTIONS SHALL BE FACTORY PRE-FABRICATED, TED WITH CEILING TILE PRE BALANCED, PRE SEALED, PRE PAINTED WITH POWDER COATED BAKED ENAMEL FINISH, PRE-INTEGRATED AND ADJUSTED RN SLOT DRUMS AND PRE DRILLED FOR HANGING AND CONNECTING HOLES AT THE FACTORY. CONTRACTOR TO COORDINATE DIMENSIONS AND INSTALLATION WITH NAD KLIMA. DIFFUSERS SHALL BE MANUFACTURED IN CANADA WITH LEAD TIMES LESS RMANCE SPACE ROOM THAN 6 WEEKS. WHEN NECESSARY, LOCAL MANUFACTURER TO BE AVAILABLE FOR SITE VISITS TO PROVIDE TECHNICAL SUPPORT TO PRODUCT AS PER SITE CONDITIONS. NAD KLIMA DIFFUSERS ARE PRE-APPROVED BY THE ARCHITECT/INTERIOR DESIGNER. PROVIDE BASE-BID NAD KLIMA MODEL RRA ENGINEERED PRE-FABRICATED HIGH INDUCTION CIRCULAR DUCT DIFFUSERS

DRAWING SHEET TITLE REVIEWED BY jbb **32 UNIT AFFORDABLE SCHEDULES** DRAWN BY HOUSING APT BLDG GG 20 SOUTH STREET, TRENTON ROJECT NUMBER SCALE DRAWING NUMBER APRIL AS NOTED 23006 **M.003** ONTARIO, CANADA 2023

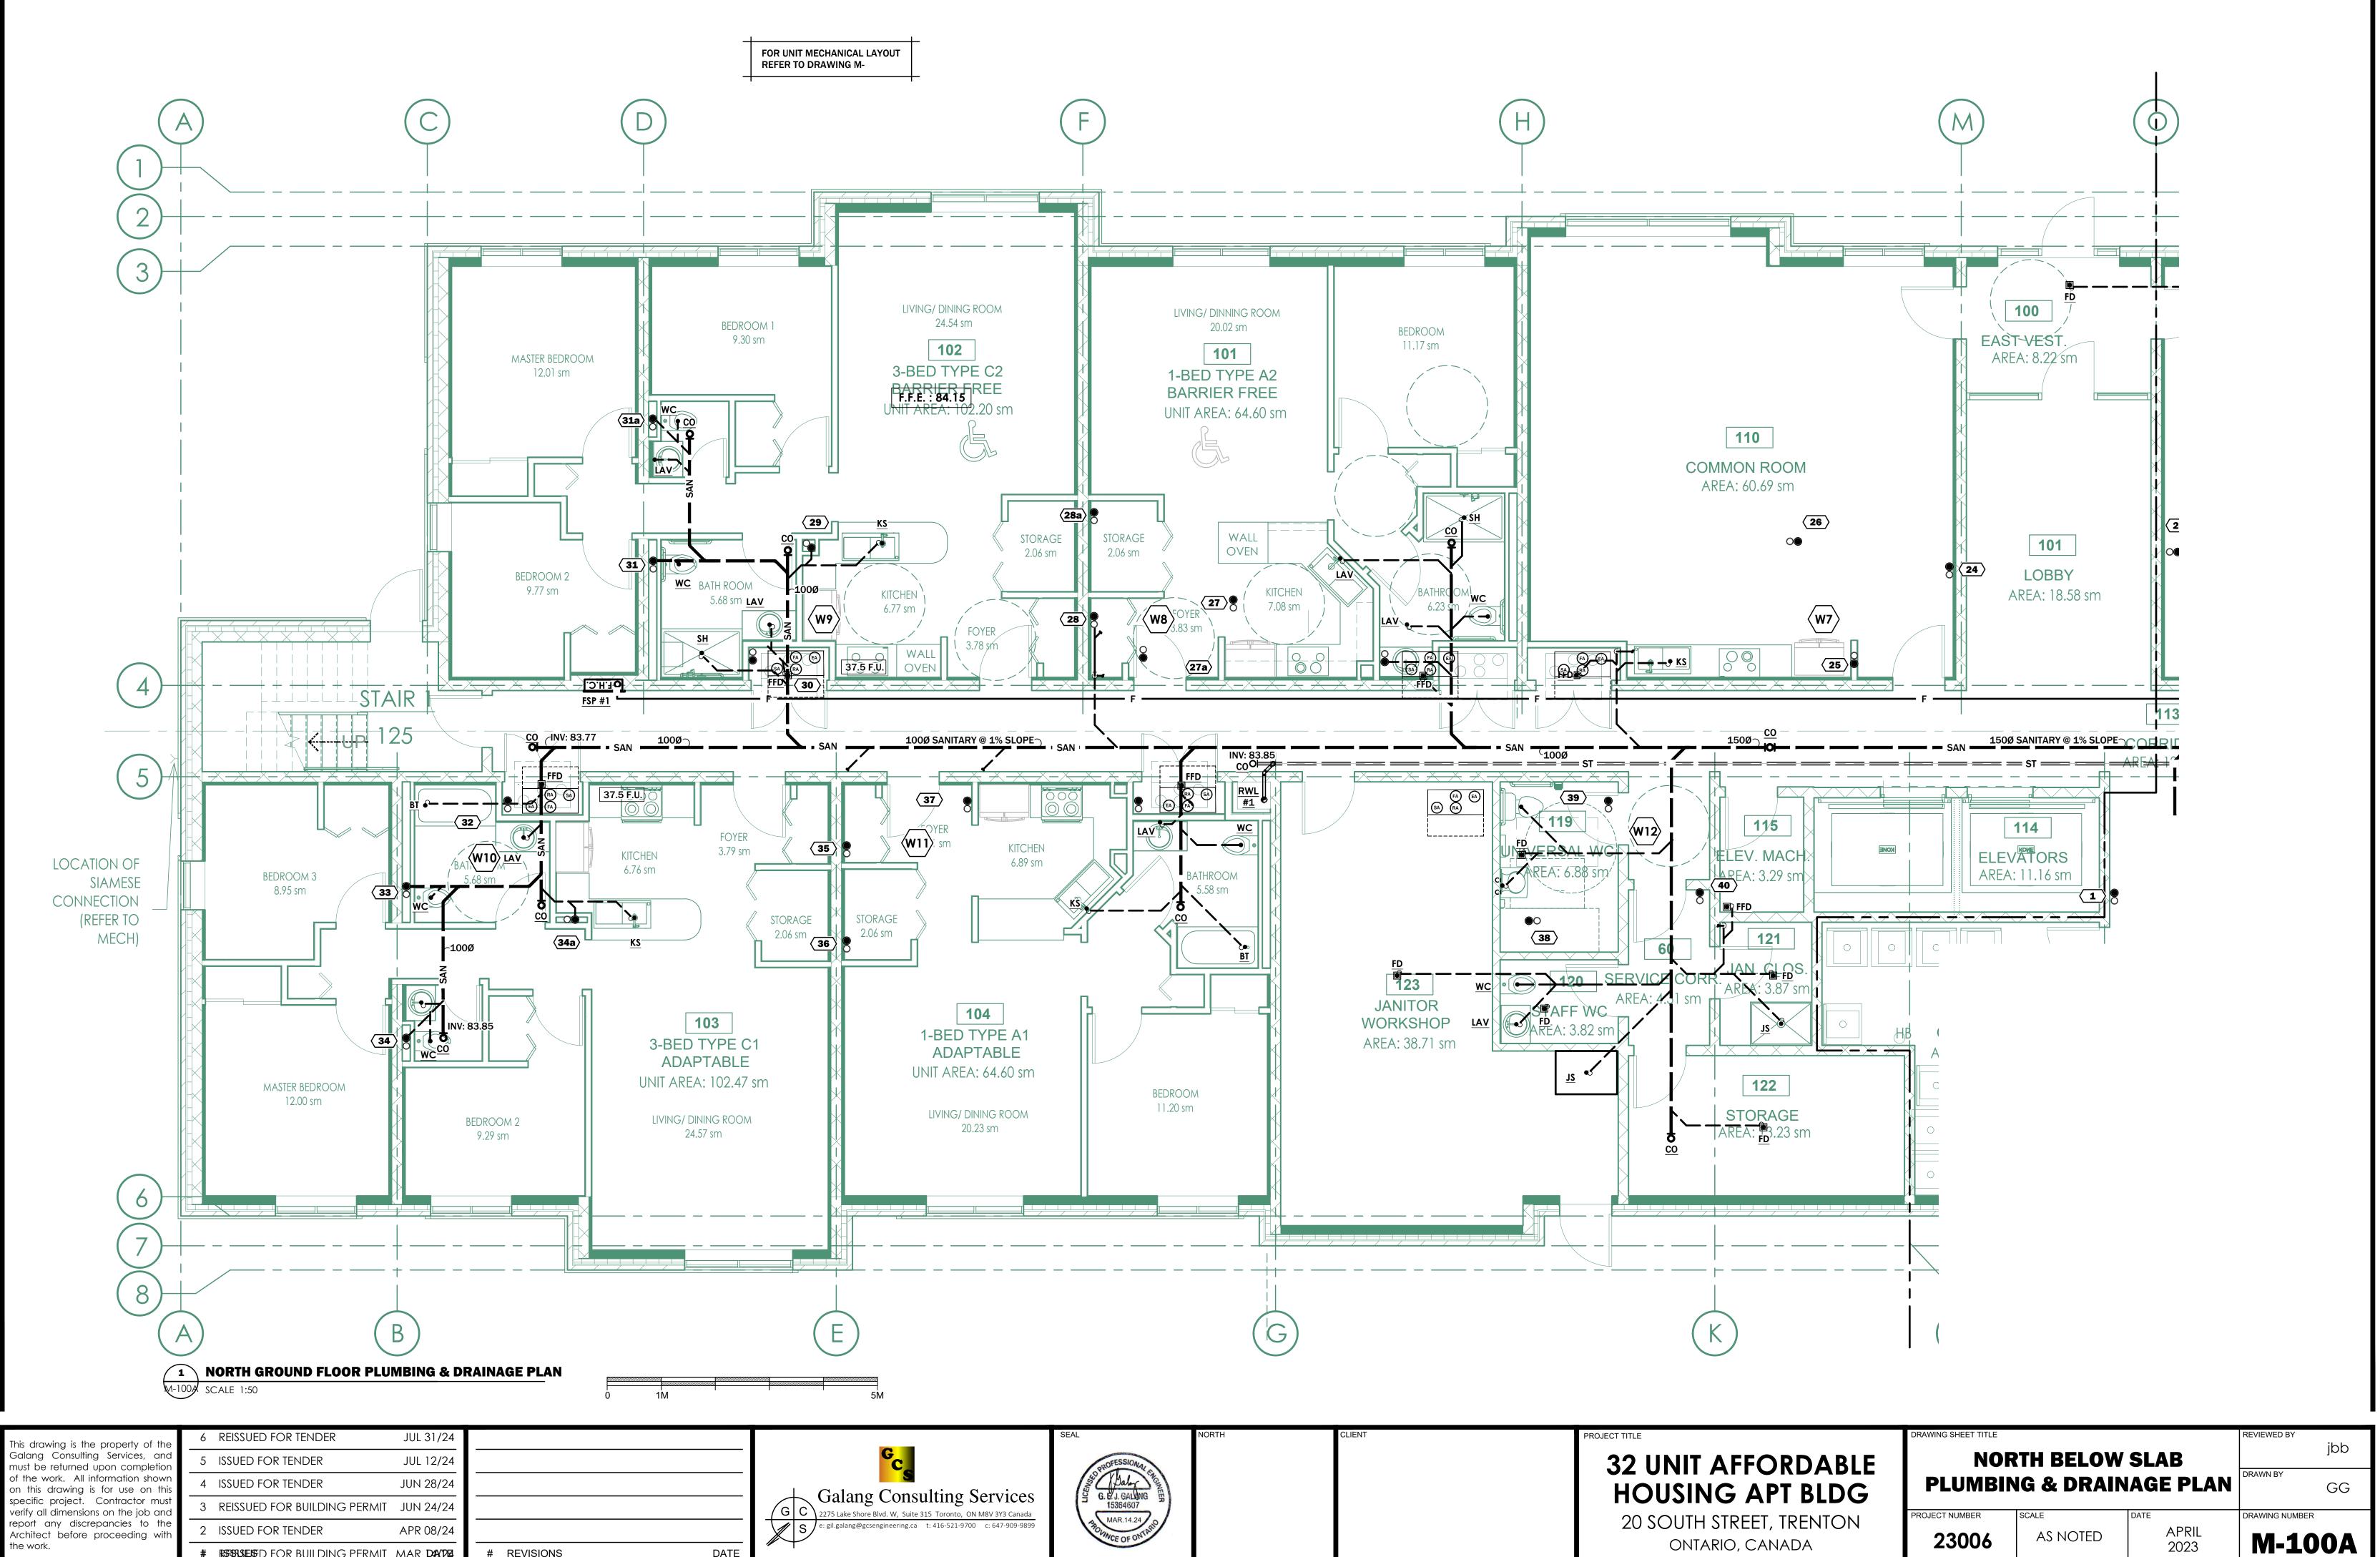


REESSIGED FOR BUILDING PERMIT MAR D4/12/24

REVISIONS

DATE

ONTARIO, CANADA

APRIL 2023

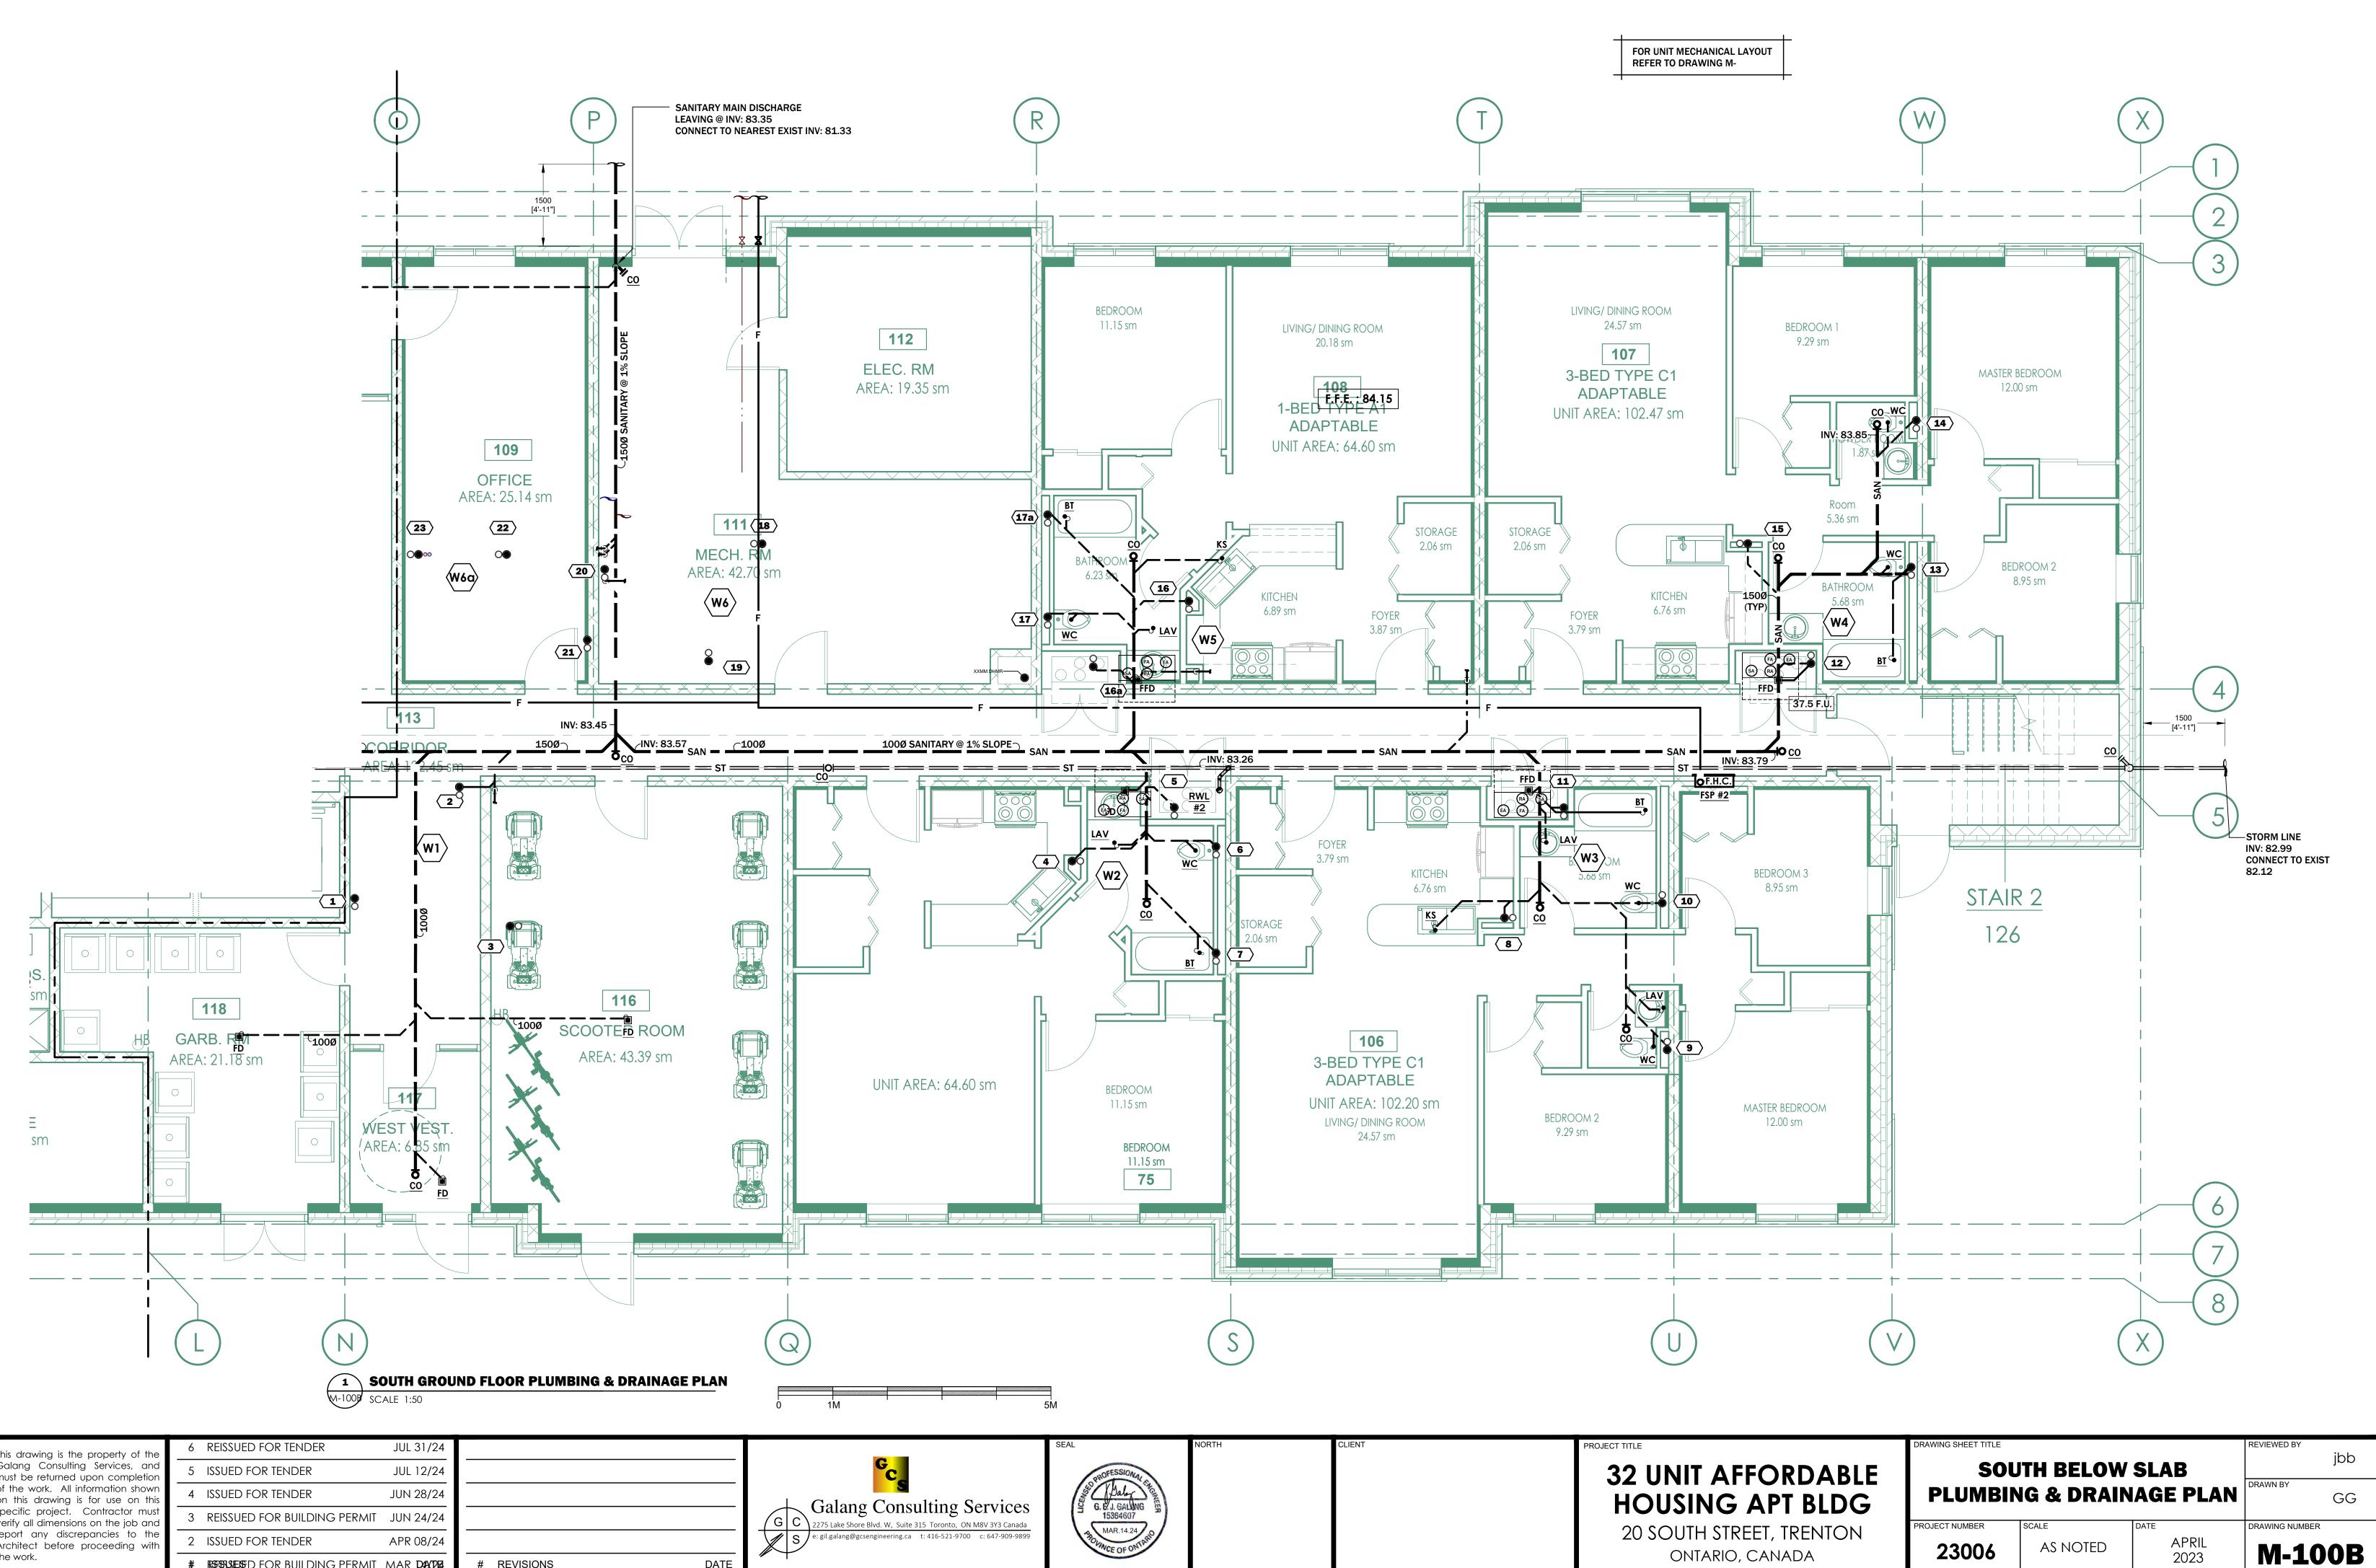



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	#	RESSURED FOR BUILDING PERMIT	MAR D44/1212
_	2	ISSUED FOR TENDER	APR 08/24
_	3	REISSUED FOR BUILDING PERMIT	JUN 24/24
_	4	ISSUED FOR TENDER	JUN 28/24
_	5	ISSUED FOR TENDER	JUL 12/24
_	6	REISSUED FOR TENDER	JUL 31/24

REVISIONS

DATE



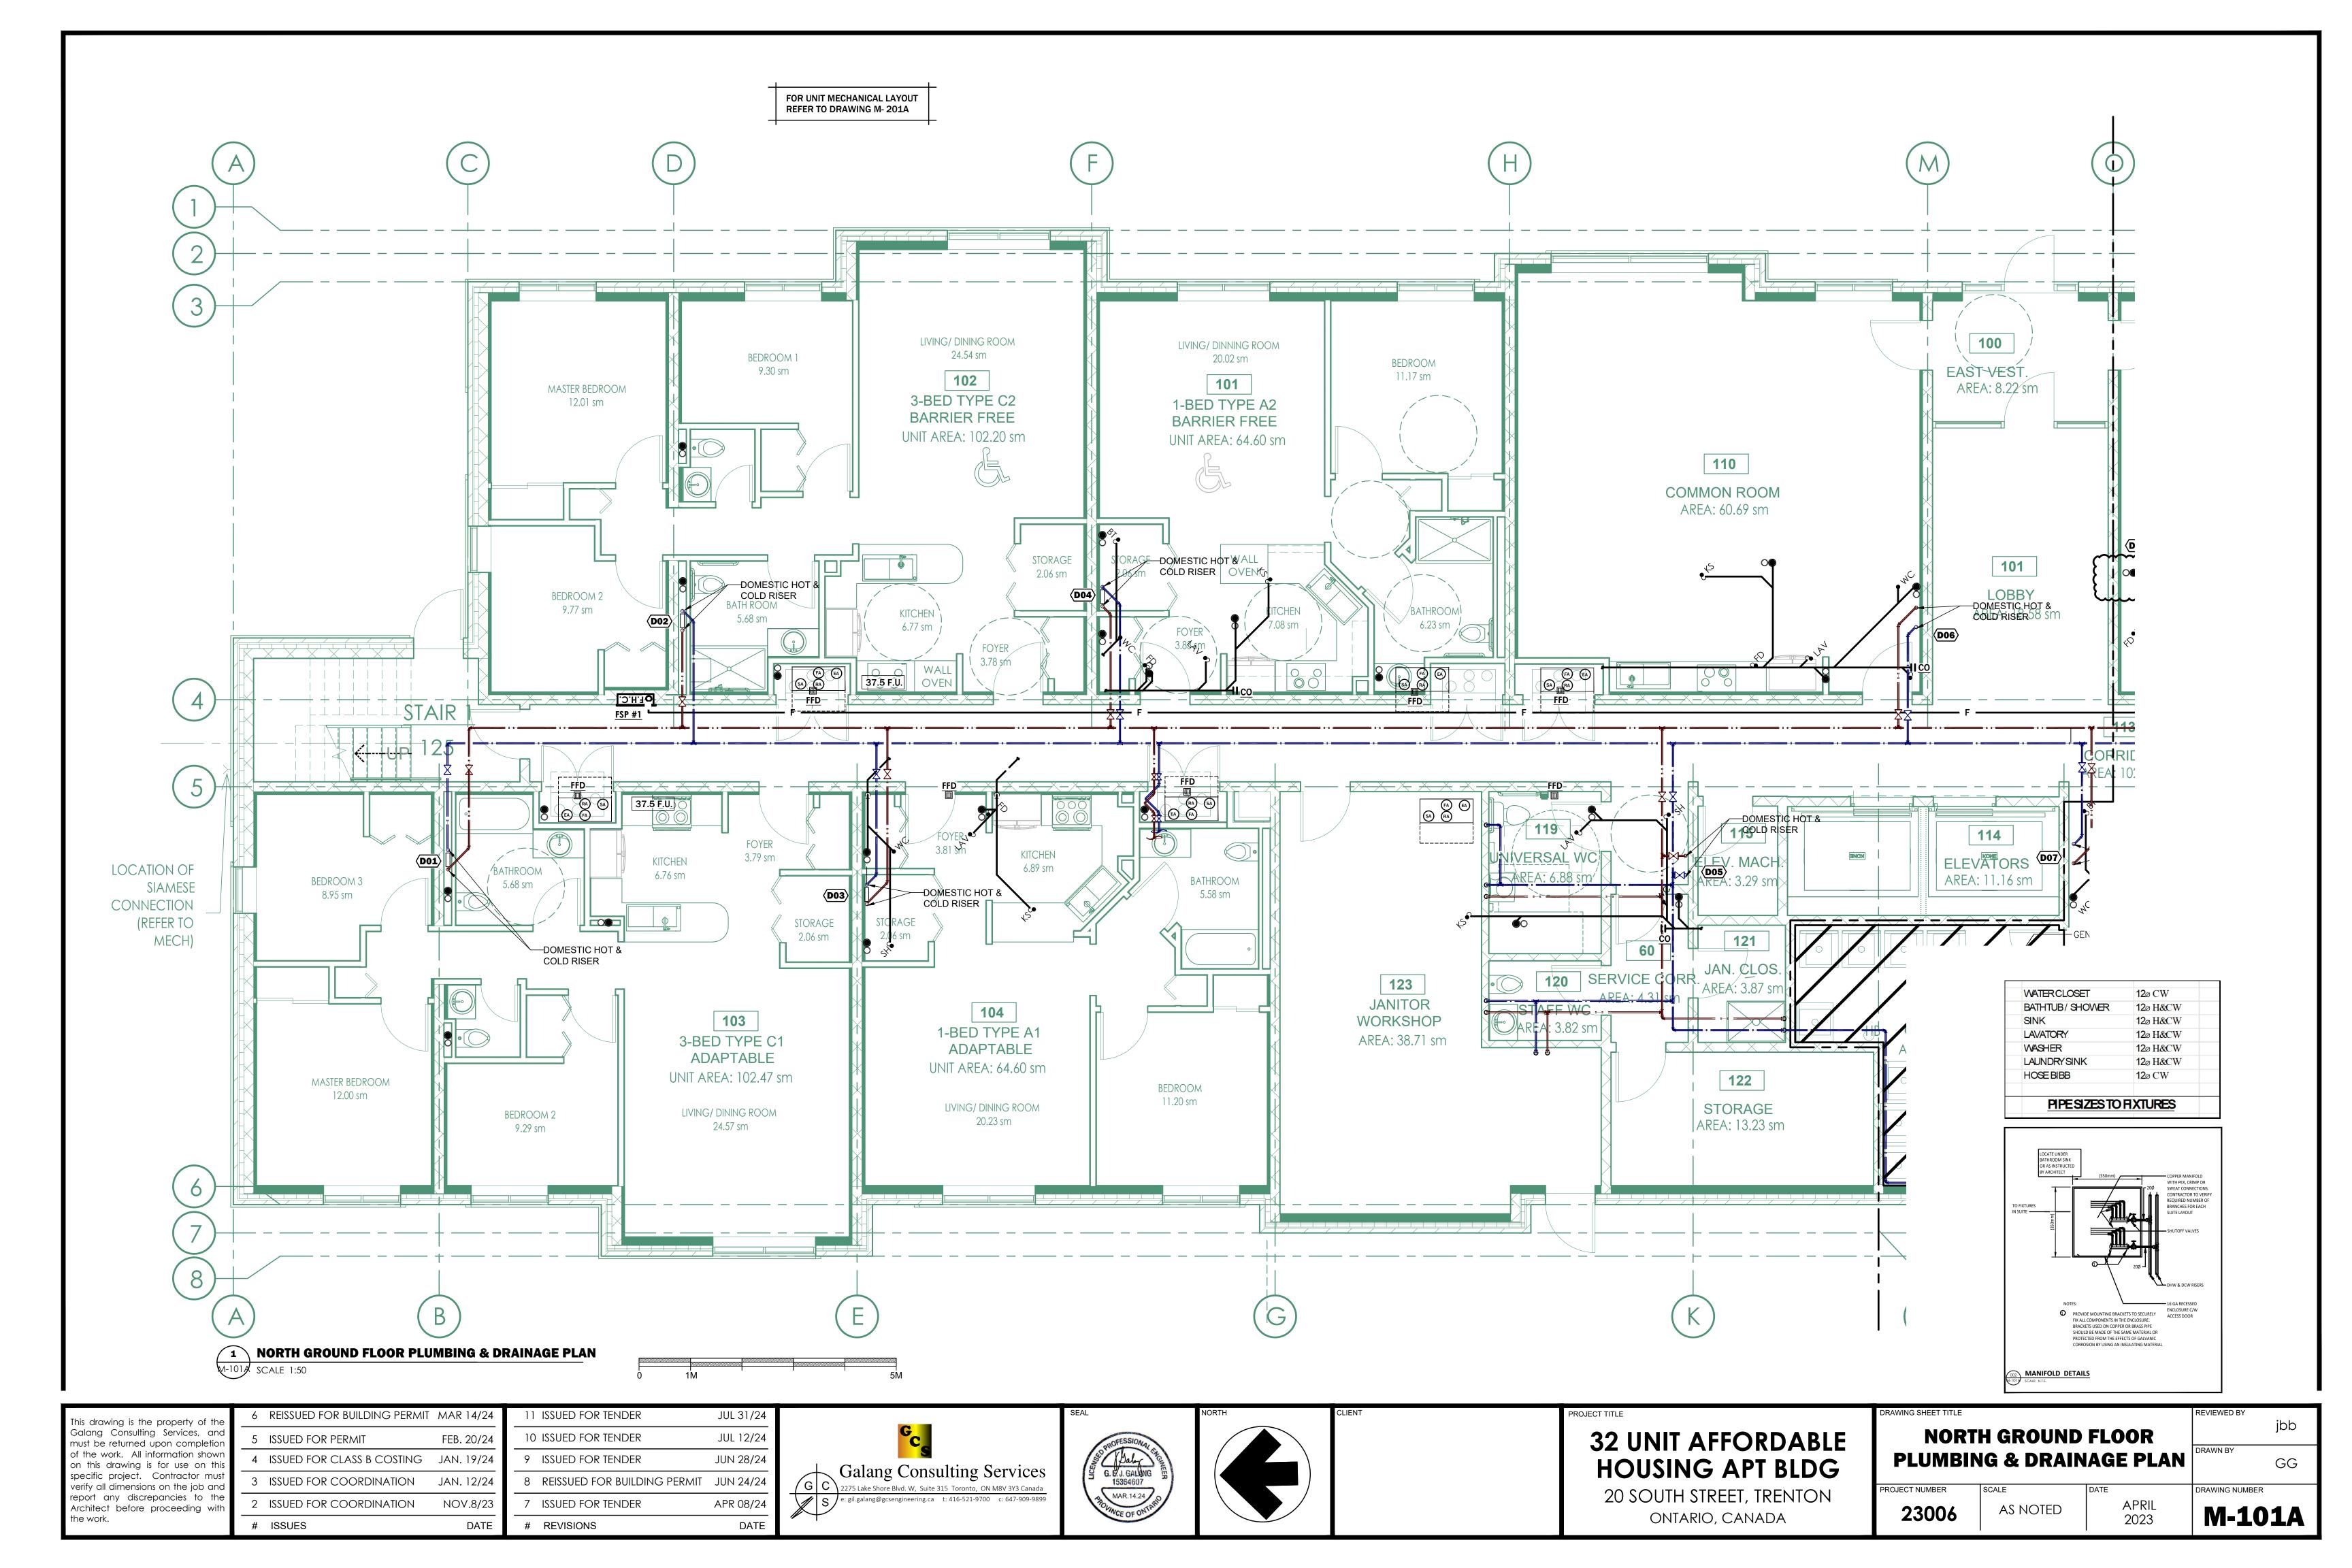

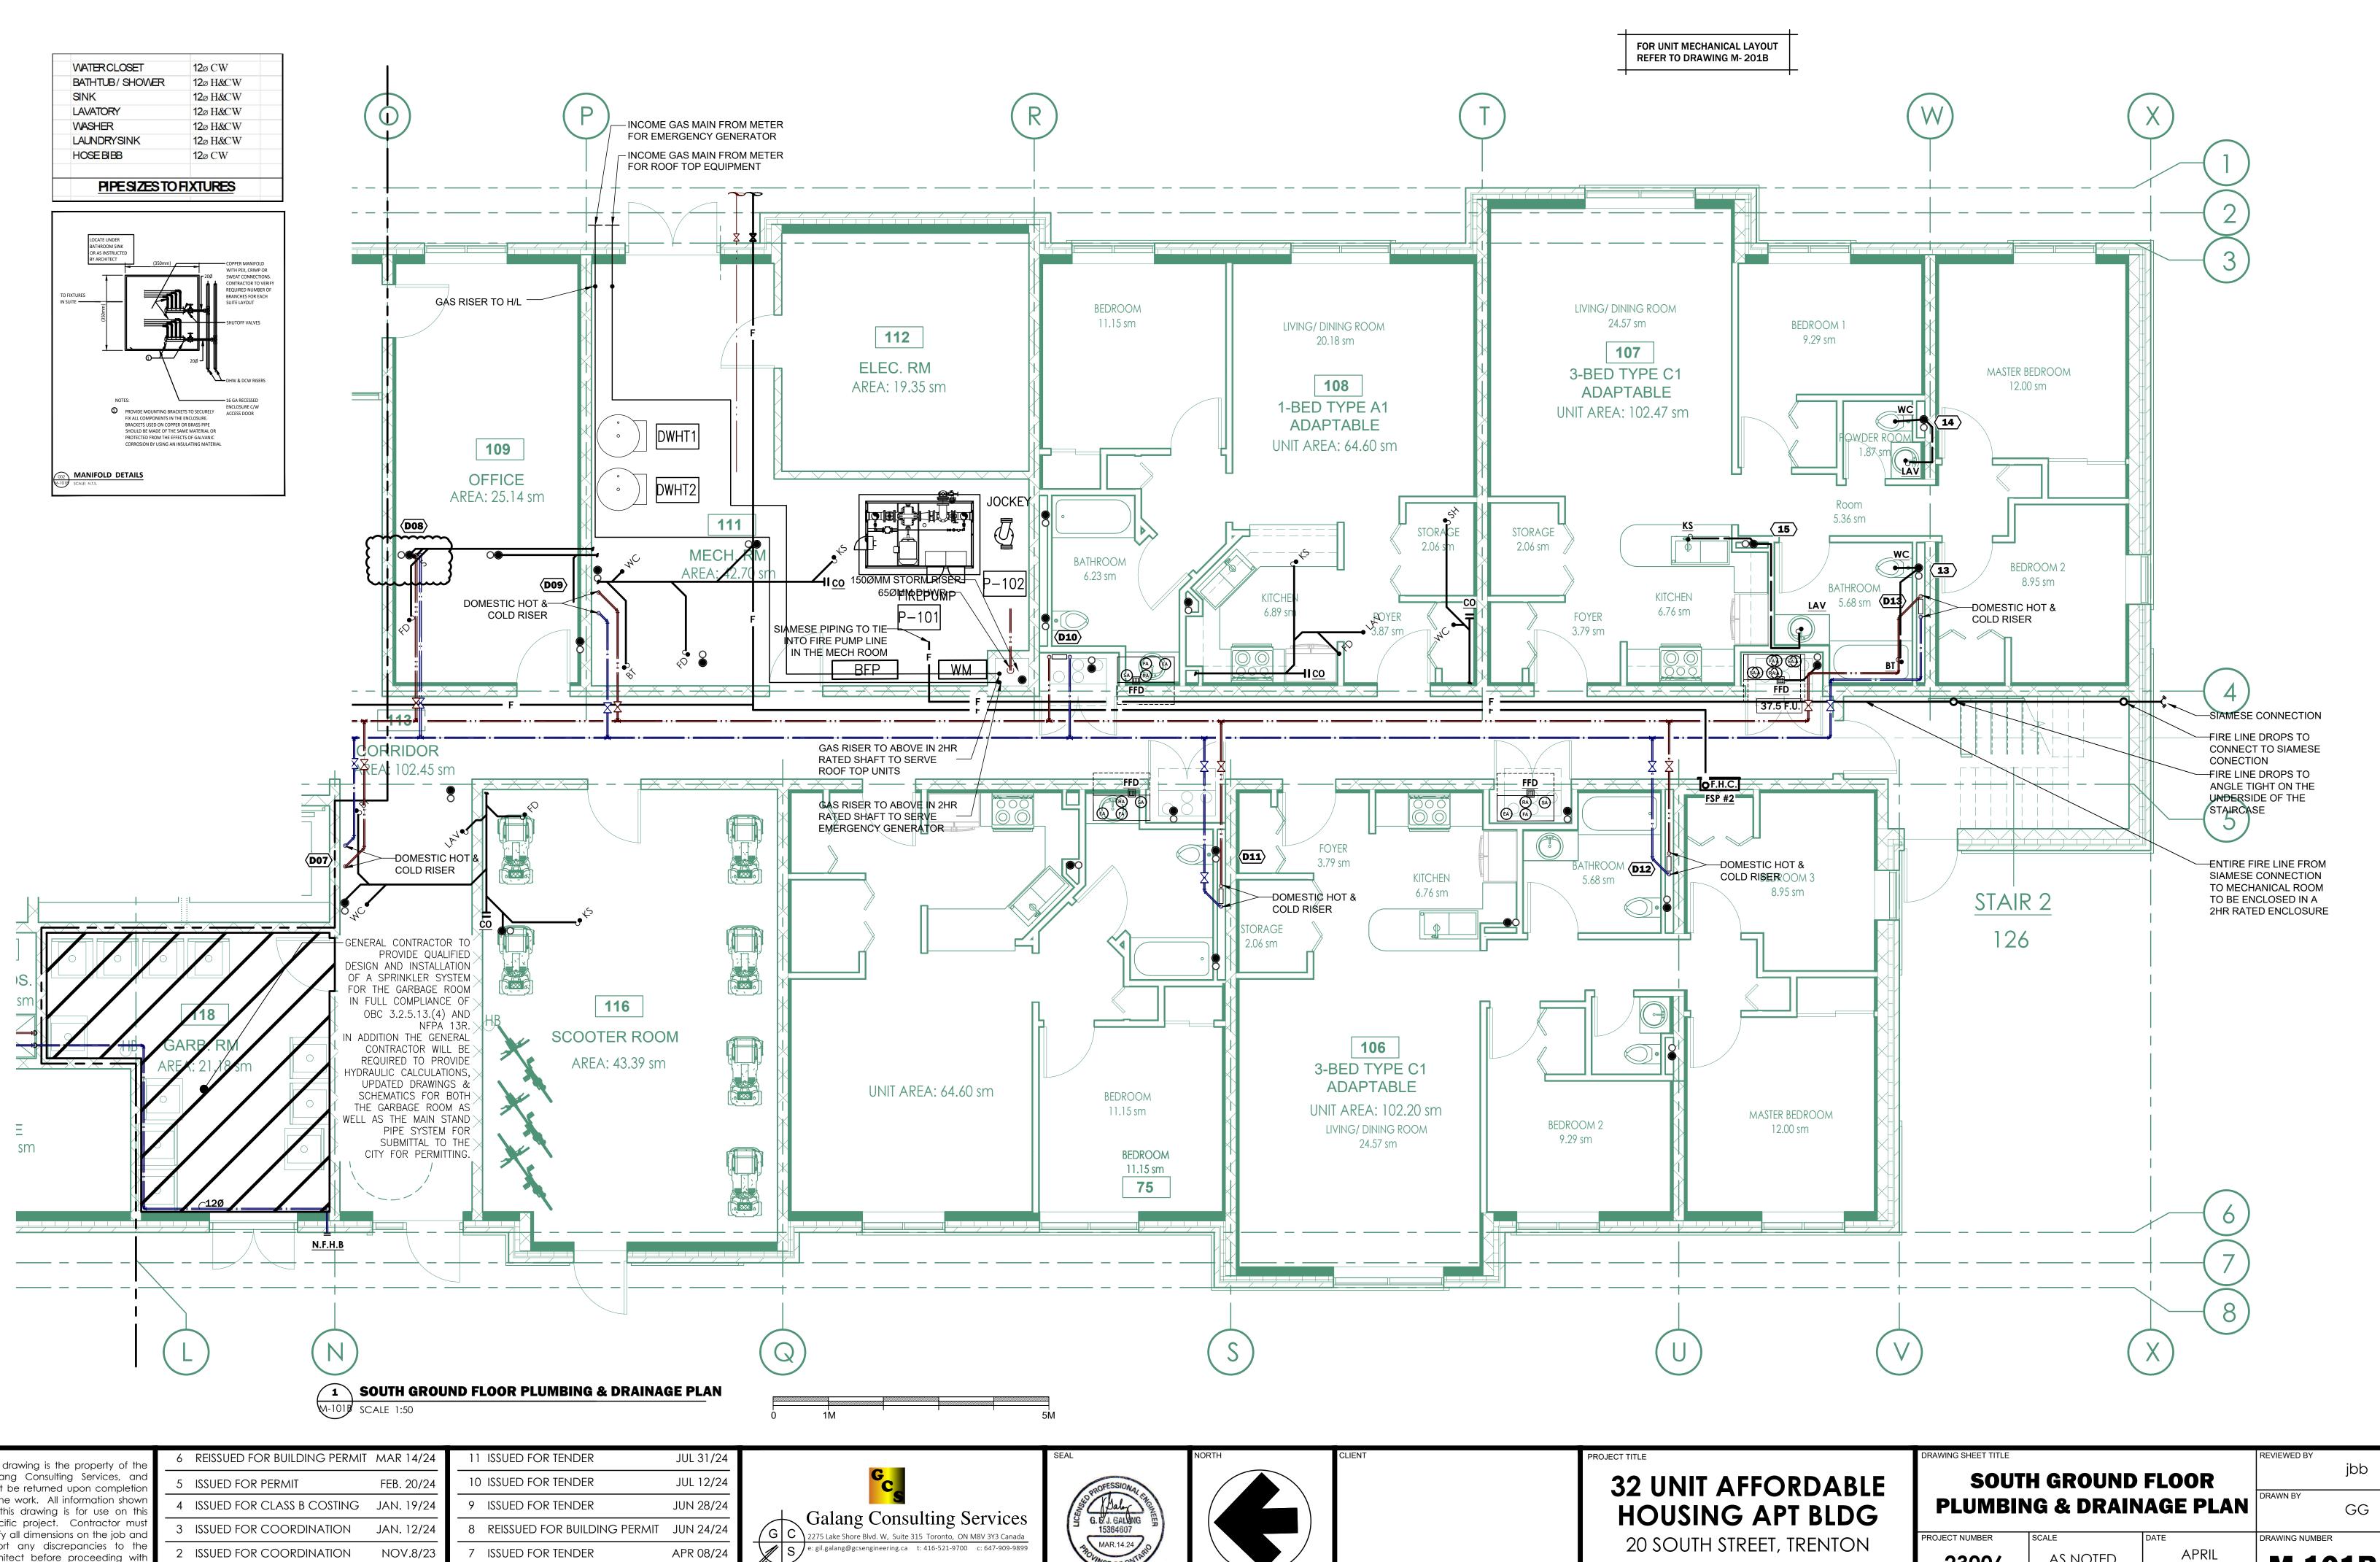the work.						
report any discrepancies to the Architect before proceeding with	2	ISSUED FOR COORDINATION	NOV.8/23	7	ISSUED FOR TENDER	APR 08/24
specific project. Contractor must verify all dimensions on the job and	3	ISSUED FOR COORDINATION	JAN. 12/24	8	REISSUED FOR BUILDING PERMIT	JUN 24/24
of the work. All information shown on this drawing is for use on this	4	ISSUED FOR CLASS B COSTING	JAN. 19/24	9	ISSUED FOR TENDER	JUN 28/24
Galang Consulting Services, and must be returned upon completion	5	ISSUED FOR PERMIT	FEB. 20/24	10) ISSUED FOR TENDER	JUL 12/24
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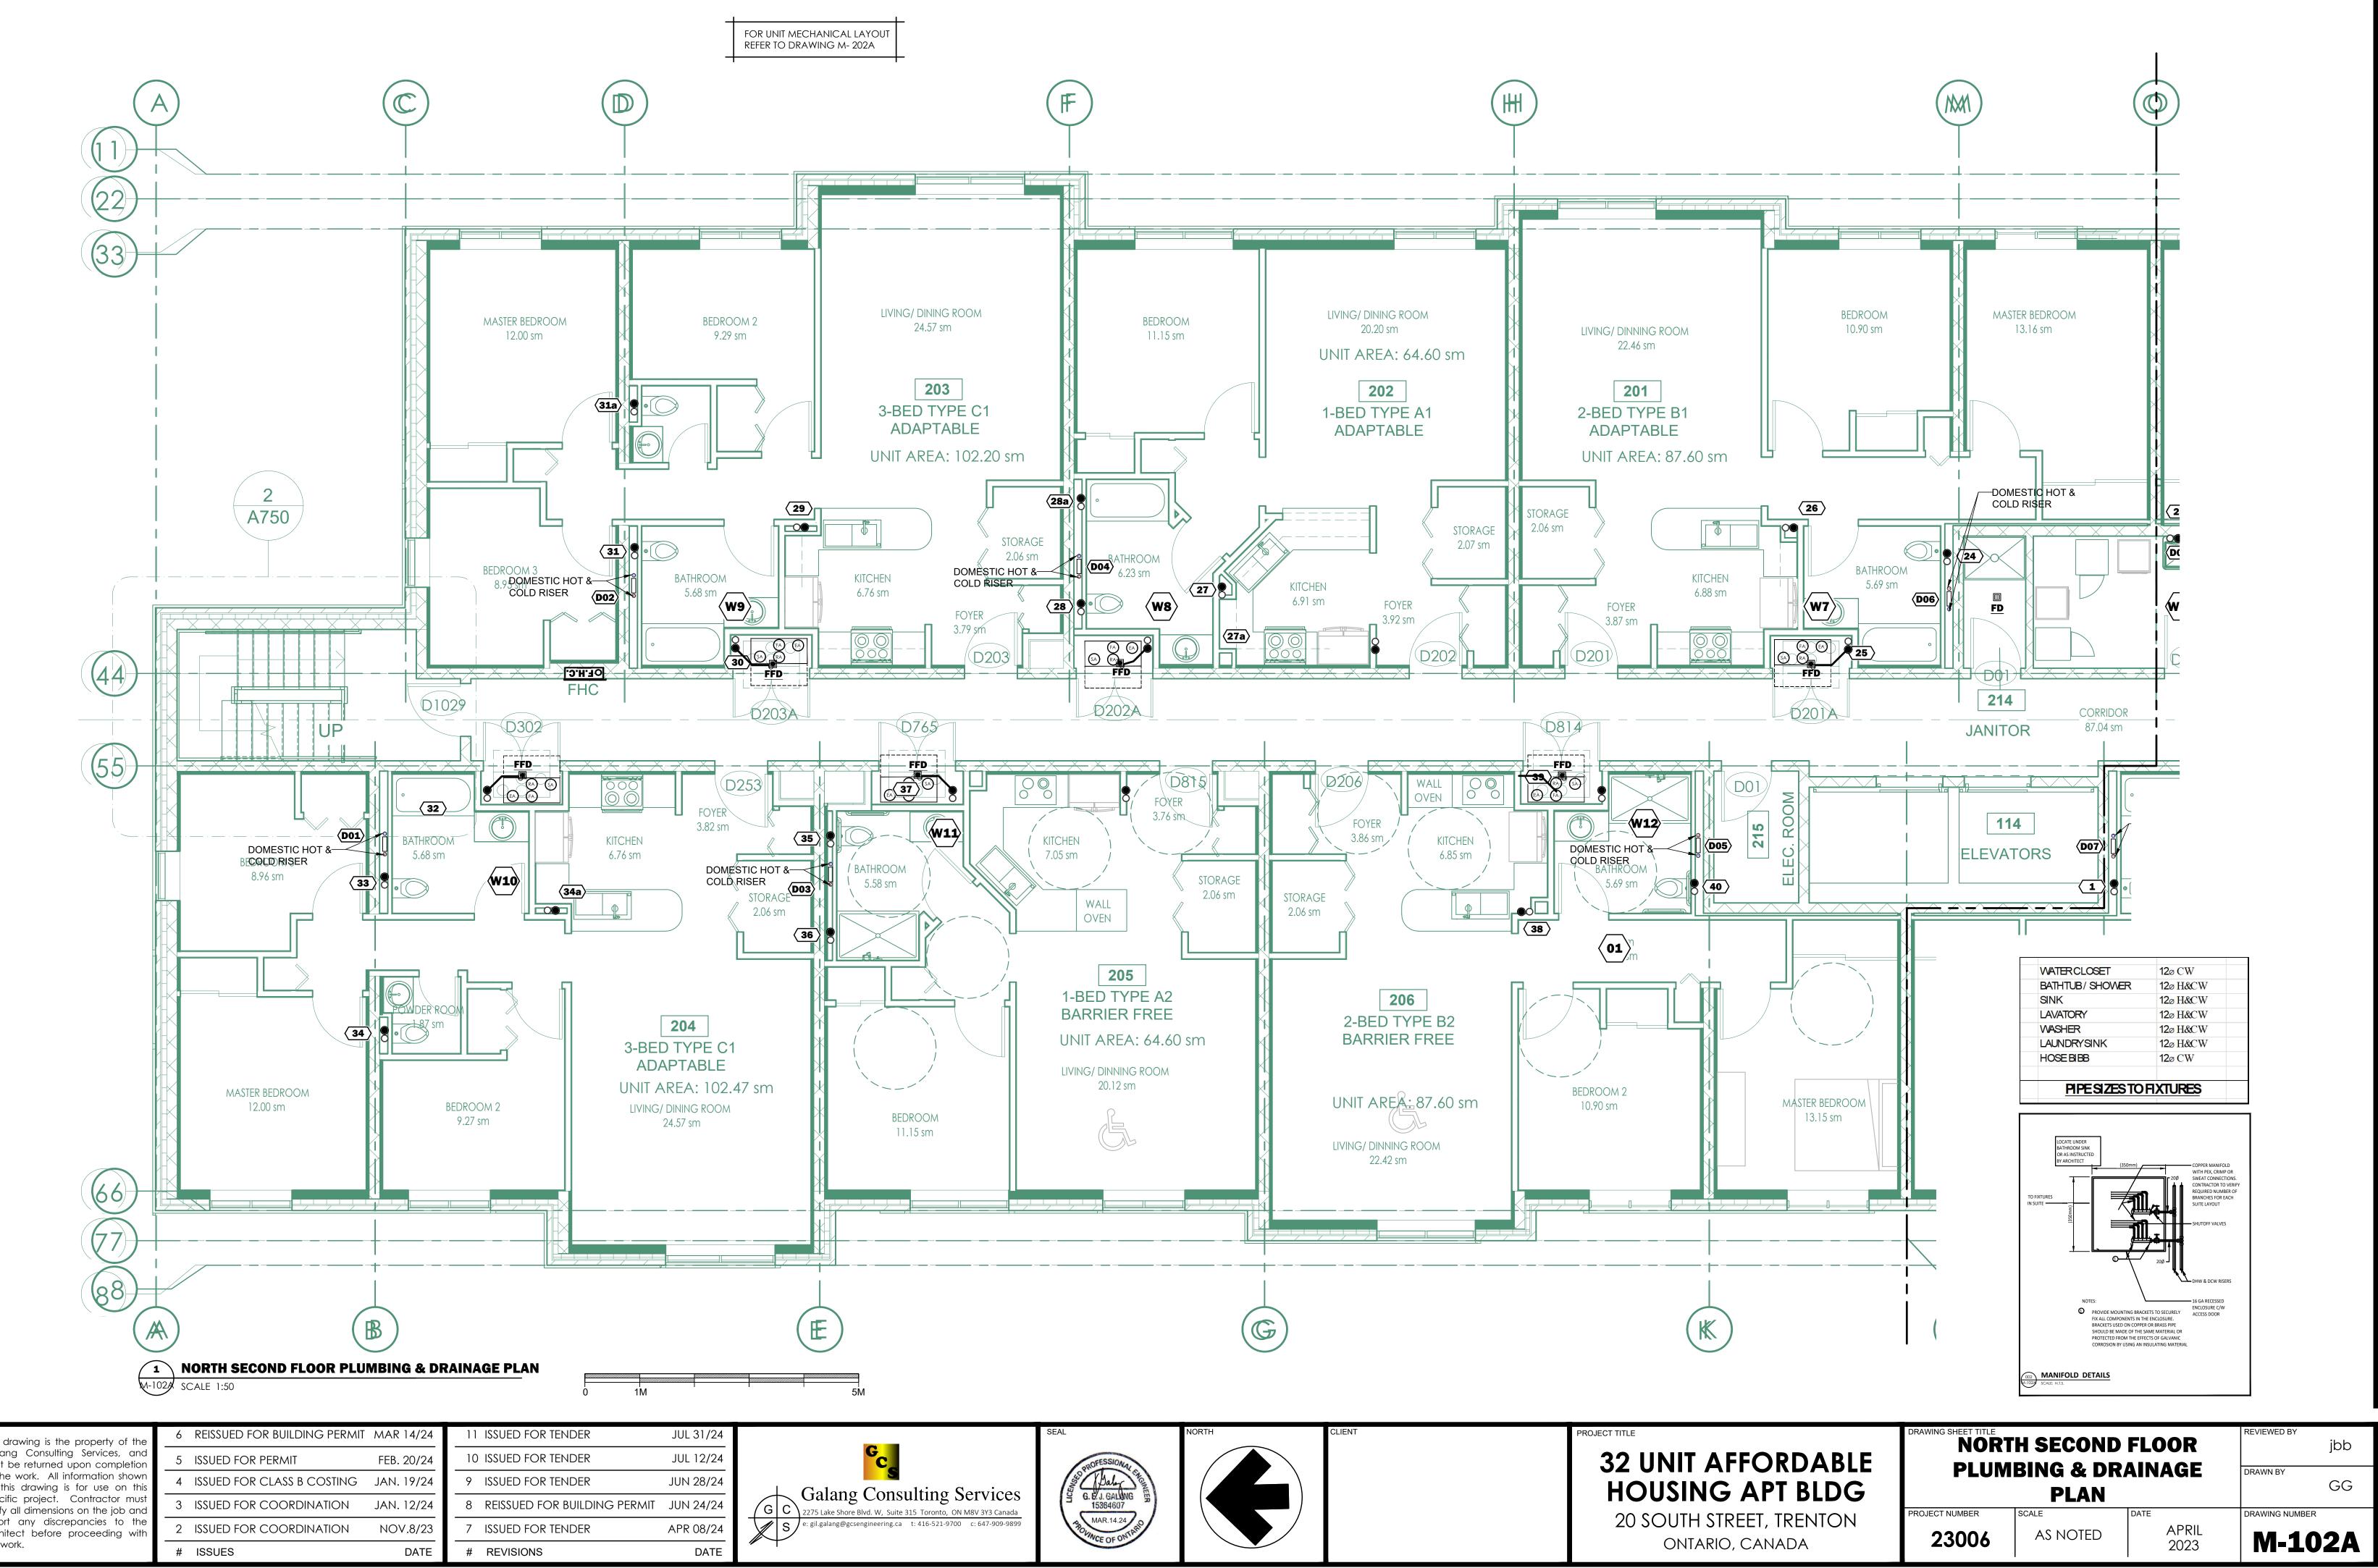
ONTARIO, CANADA

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AS NOTED

APRIL 2023


M-101B



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	9	ISSUED FOR TENDER	JUN 28/24	
	8	REISSUED FOR BUILDING PERMIT	JUN 24/24	
	7	ISSUED FOR TENDER	APR 08/24	
	#	REVISIONS	DATE	
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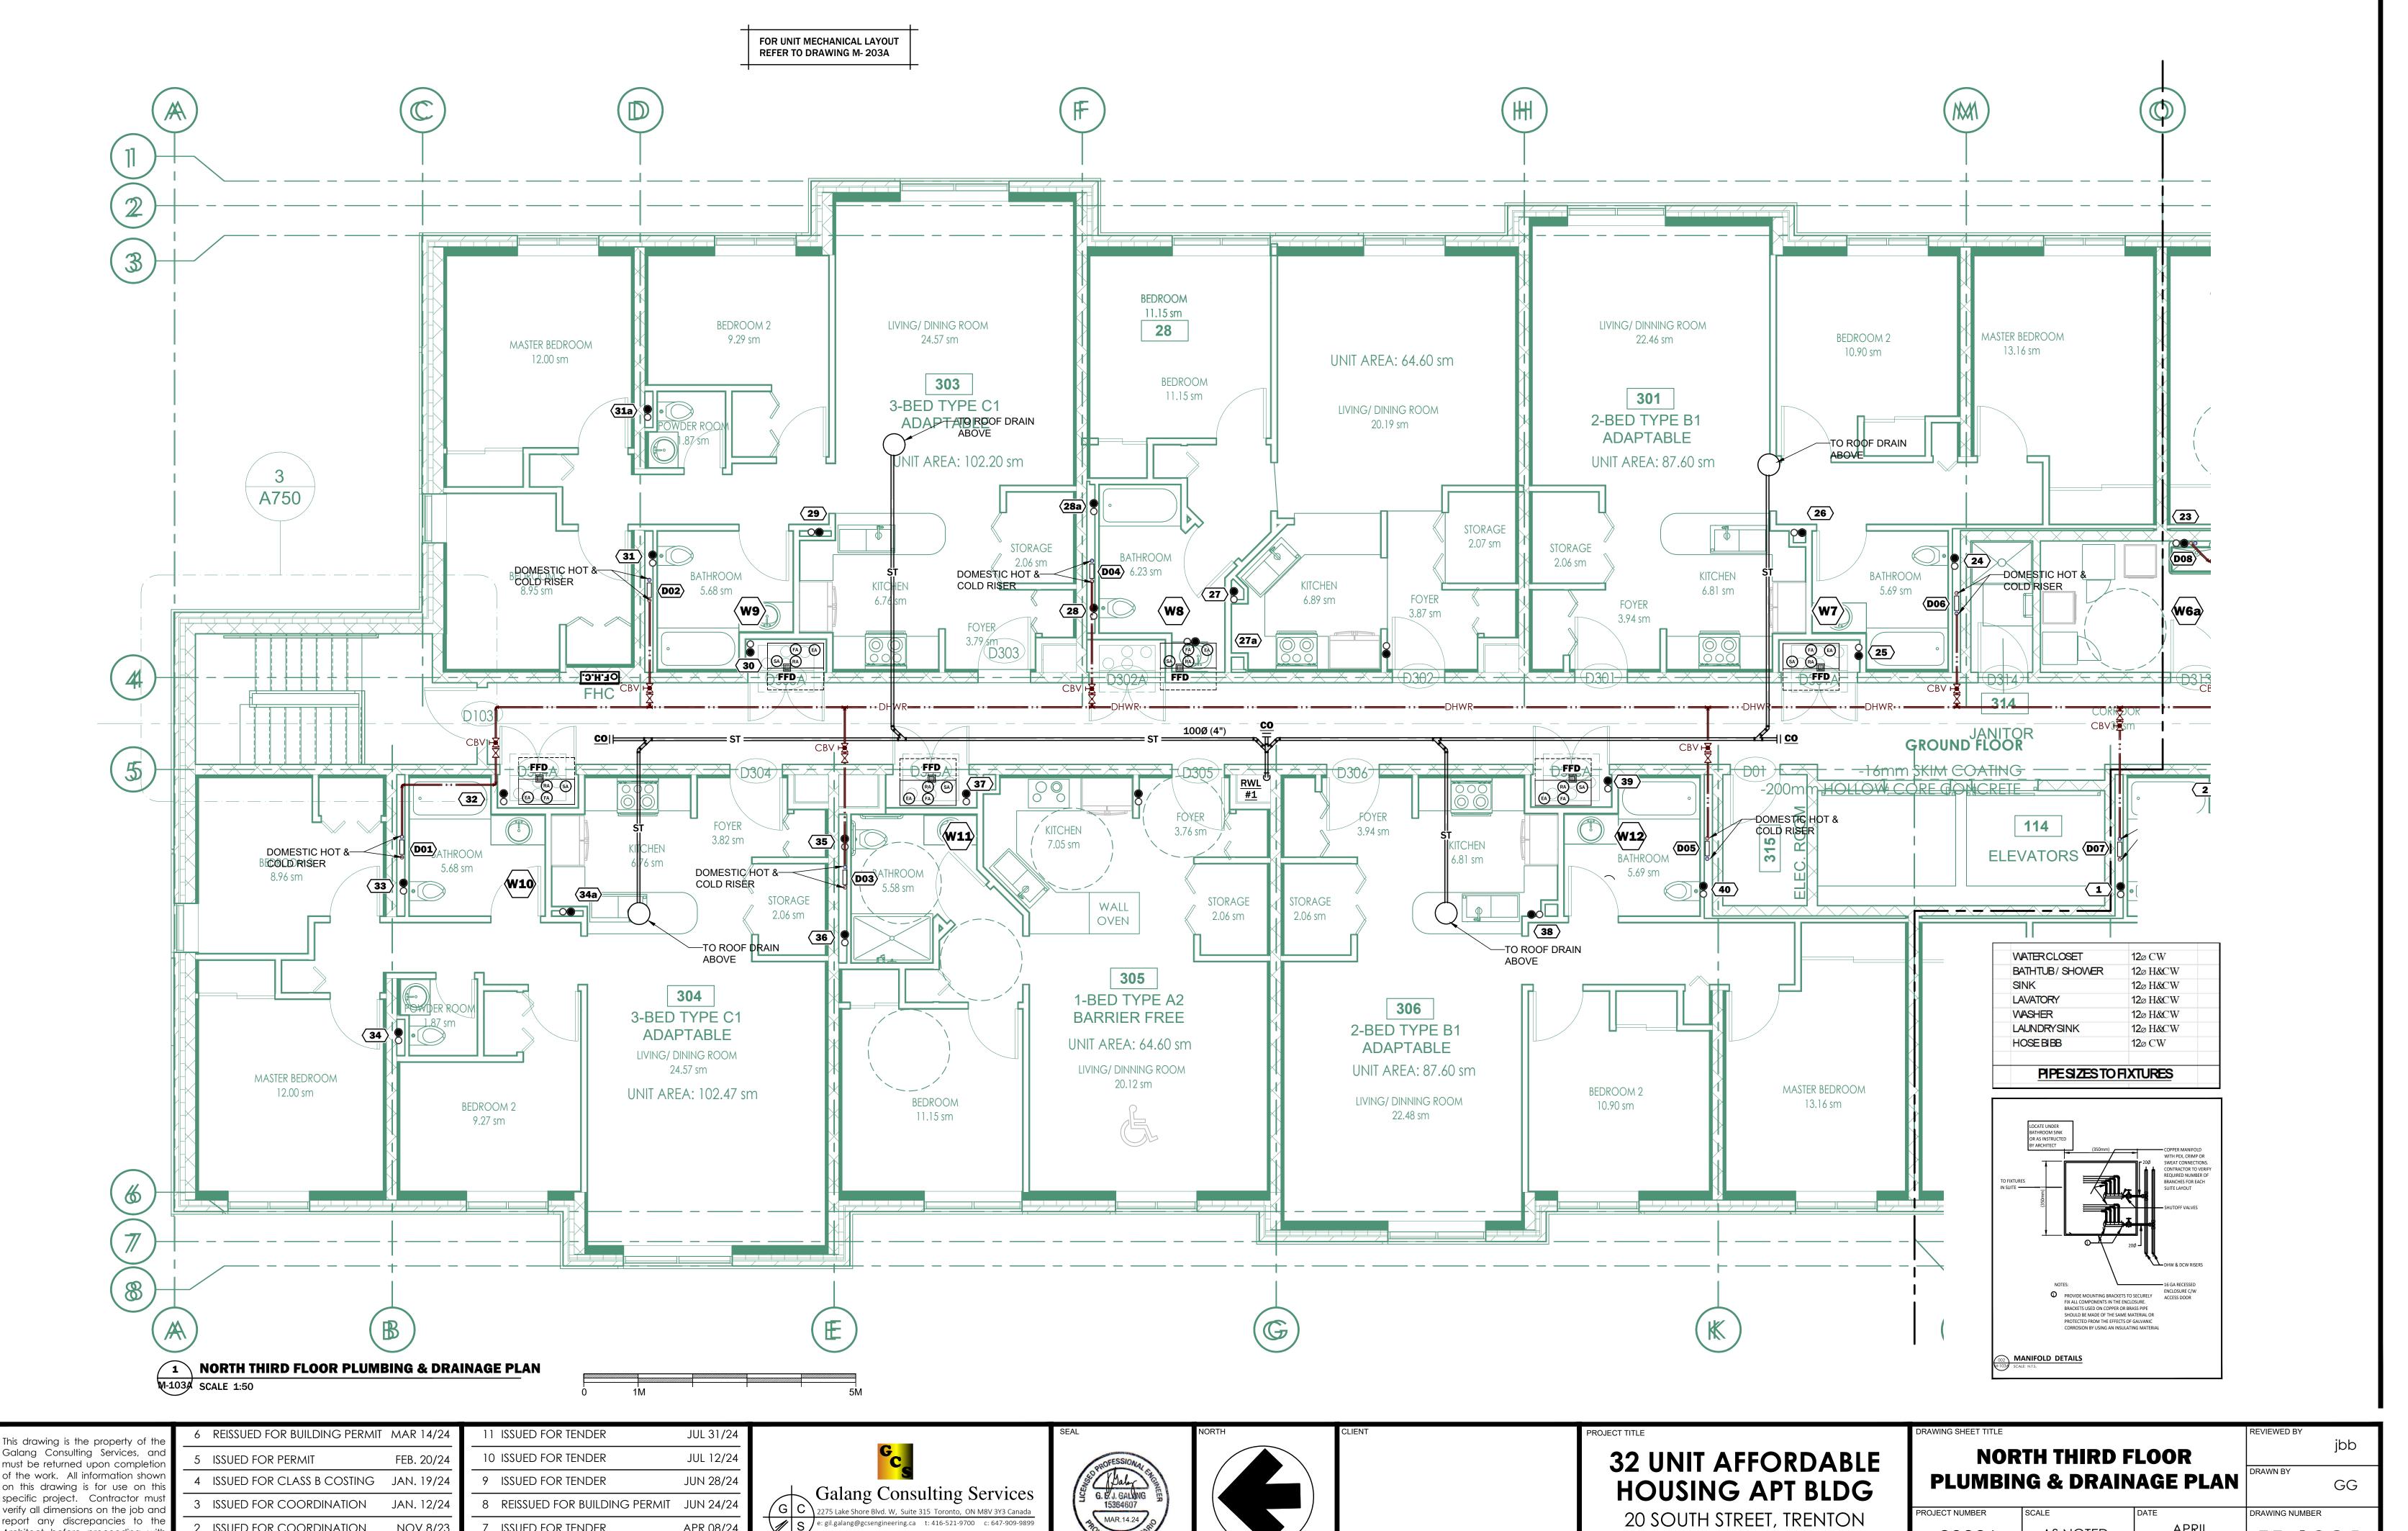
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ONTARIO, CANADA

23006

APRIL 2023
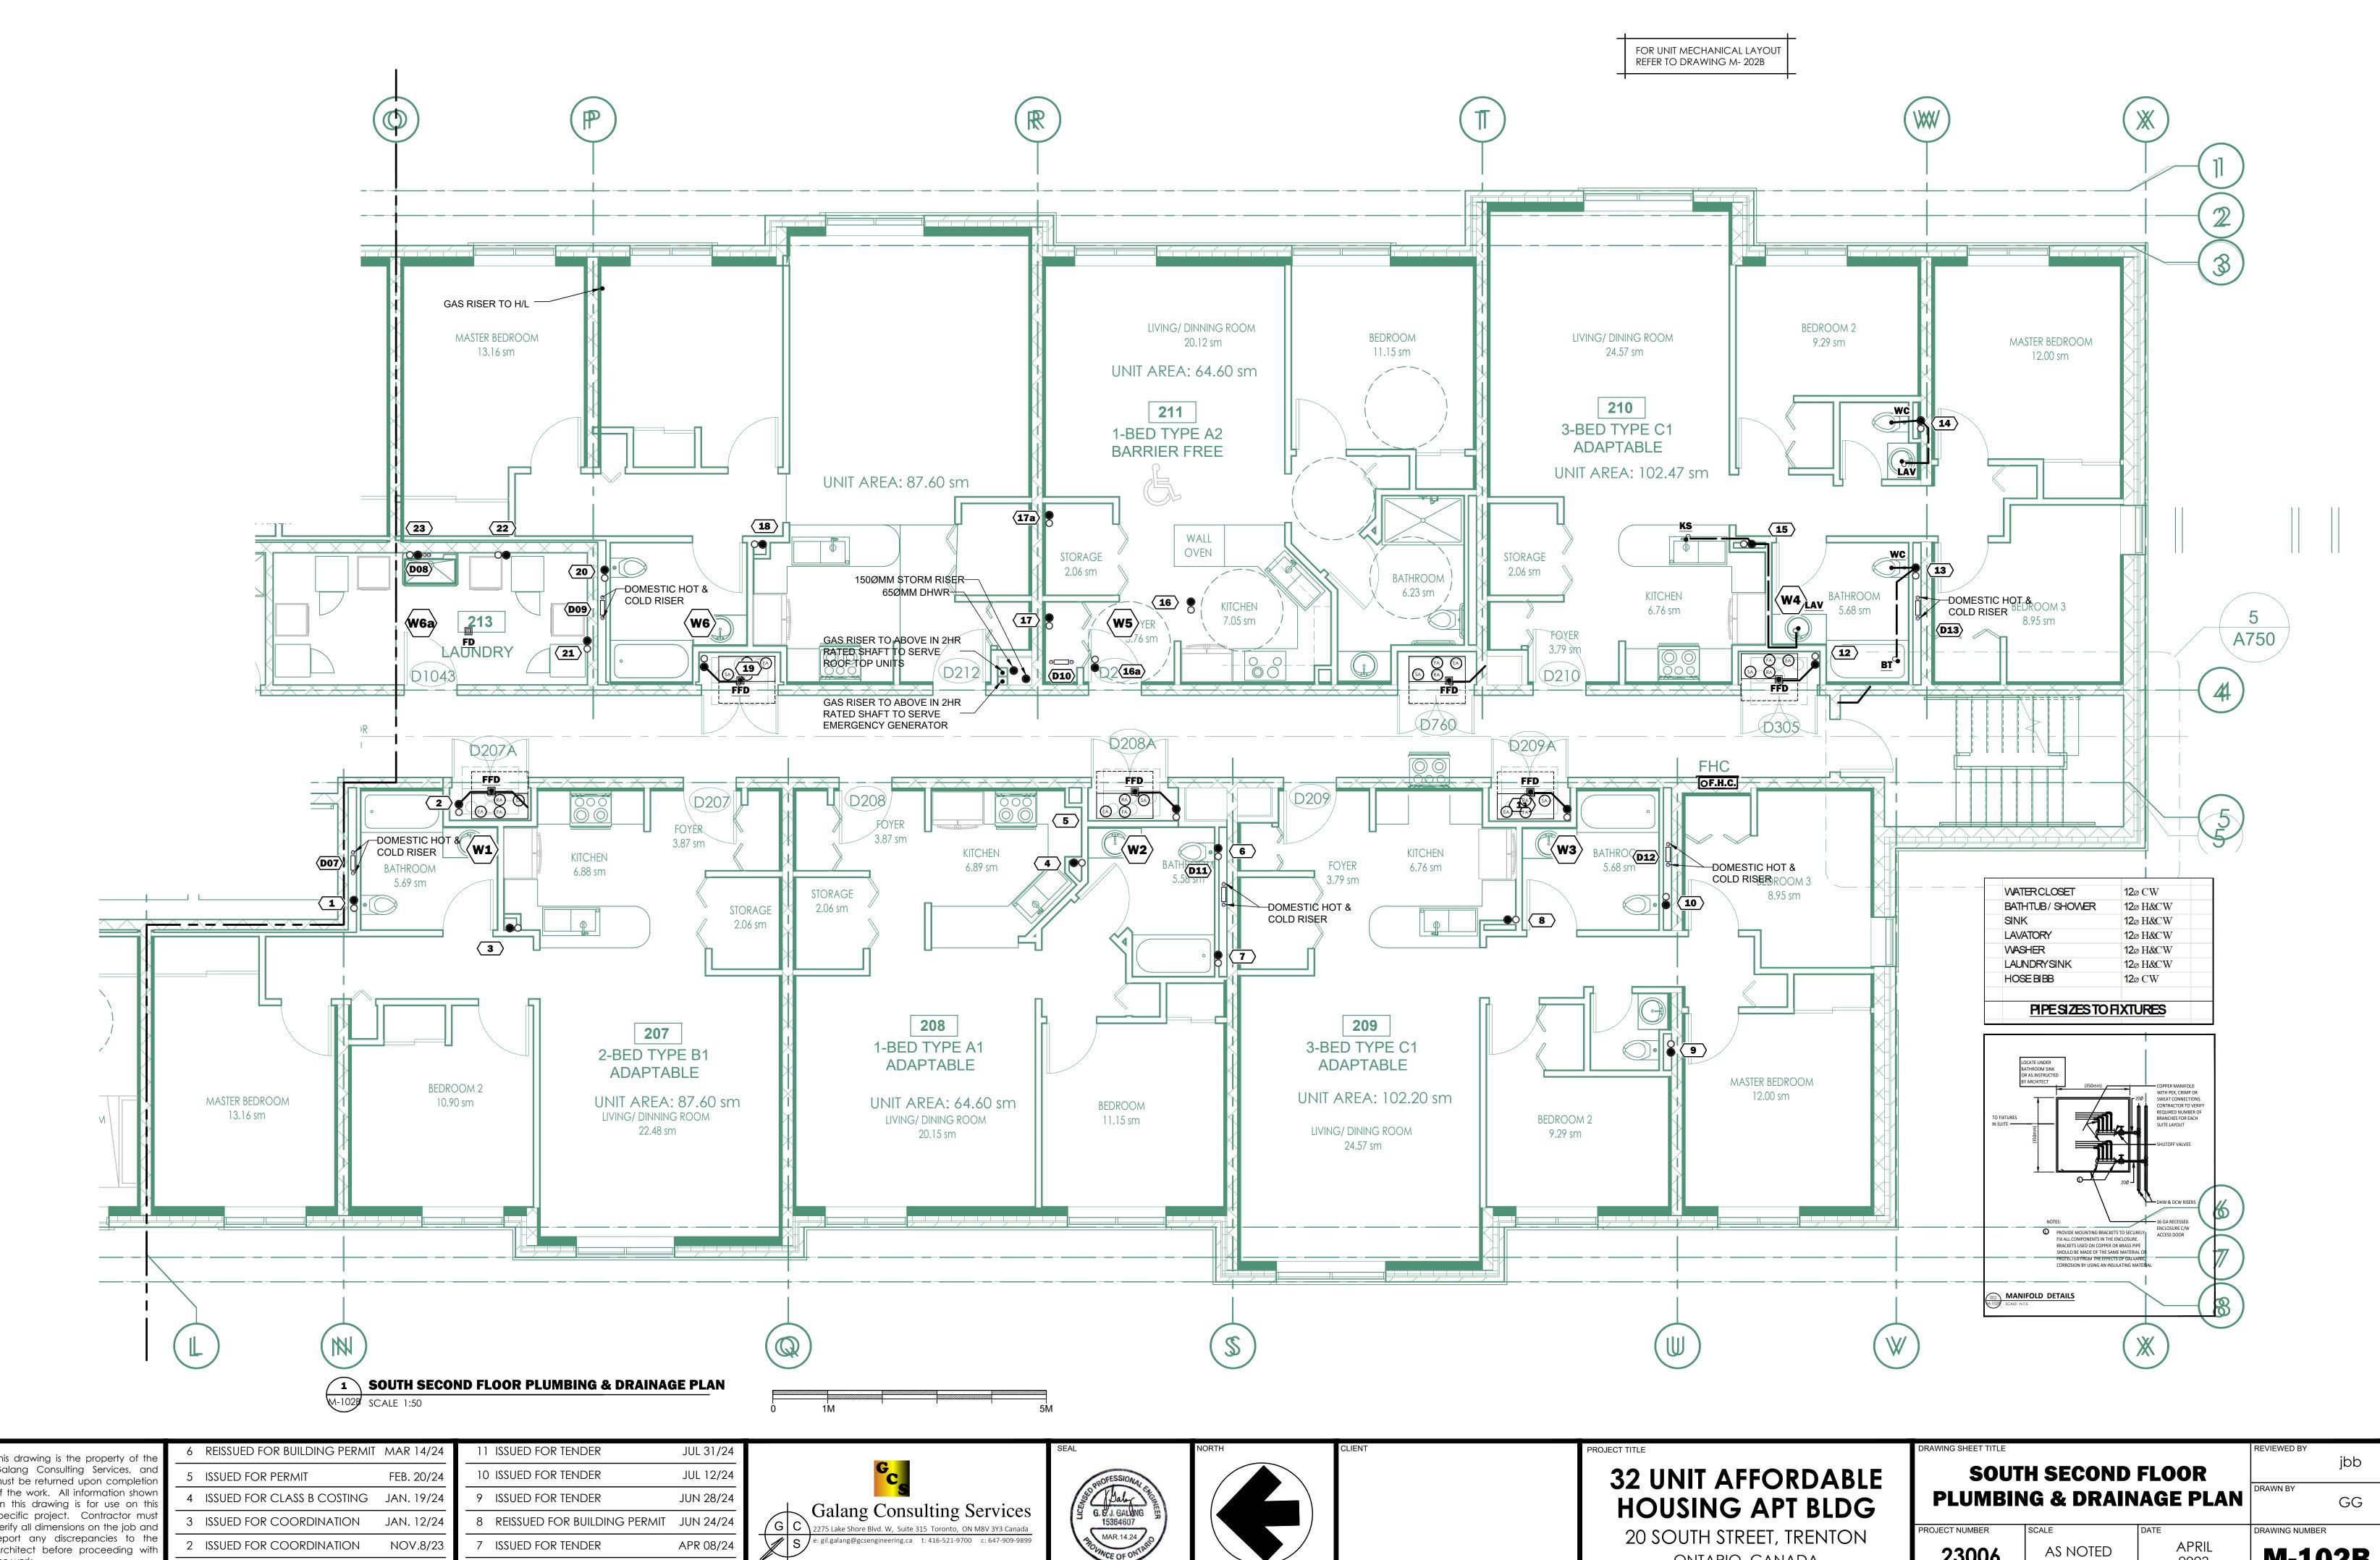
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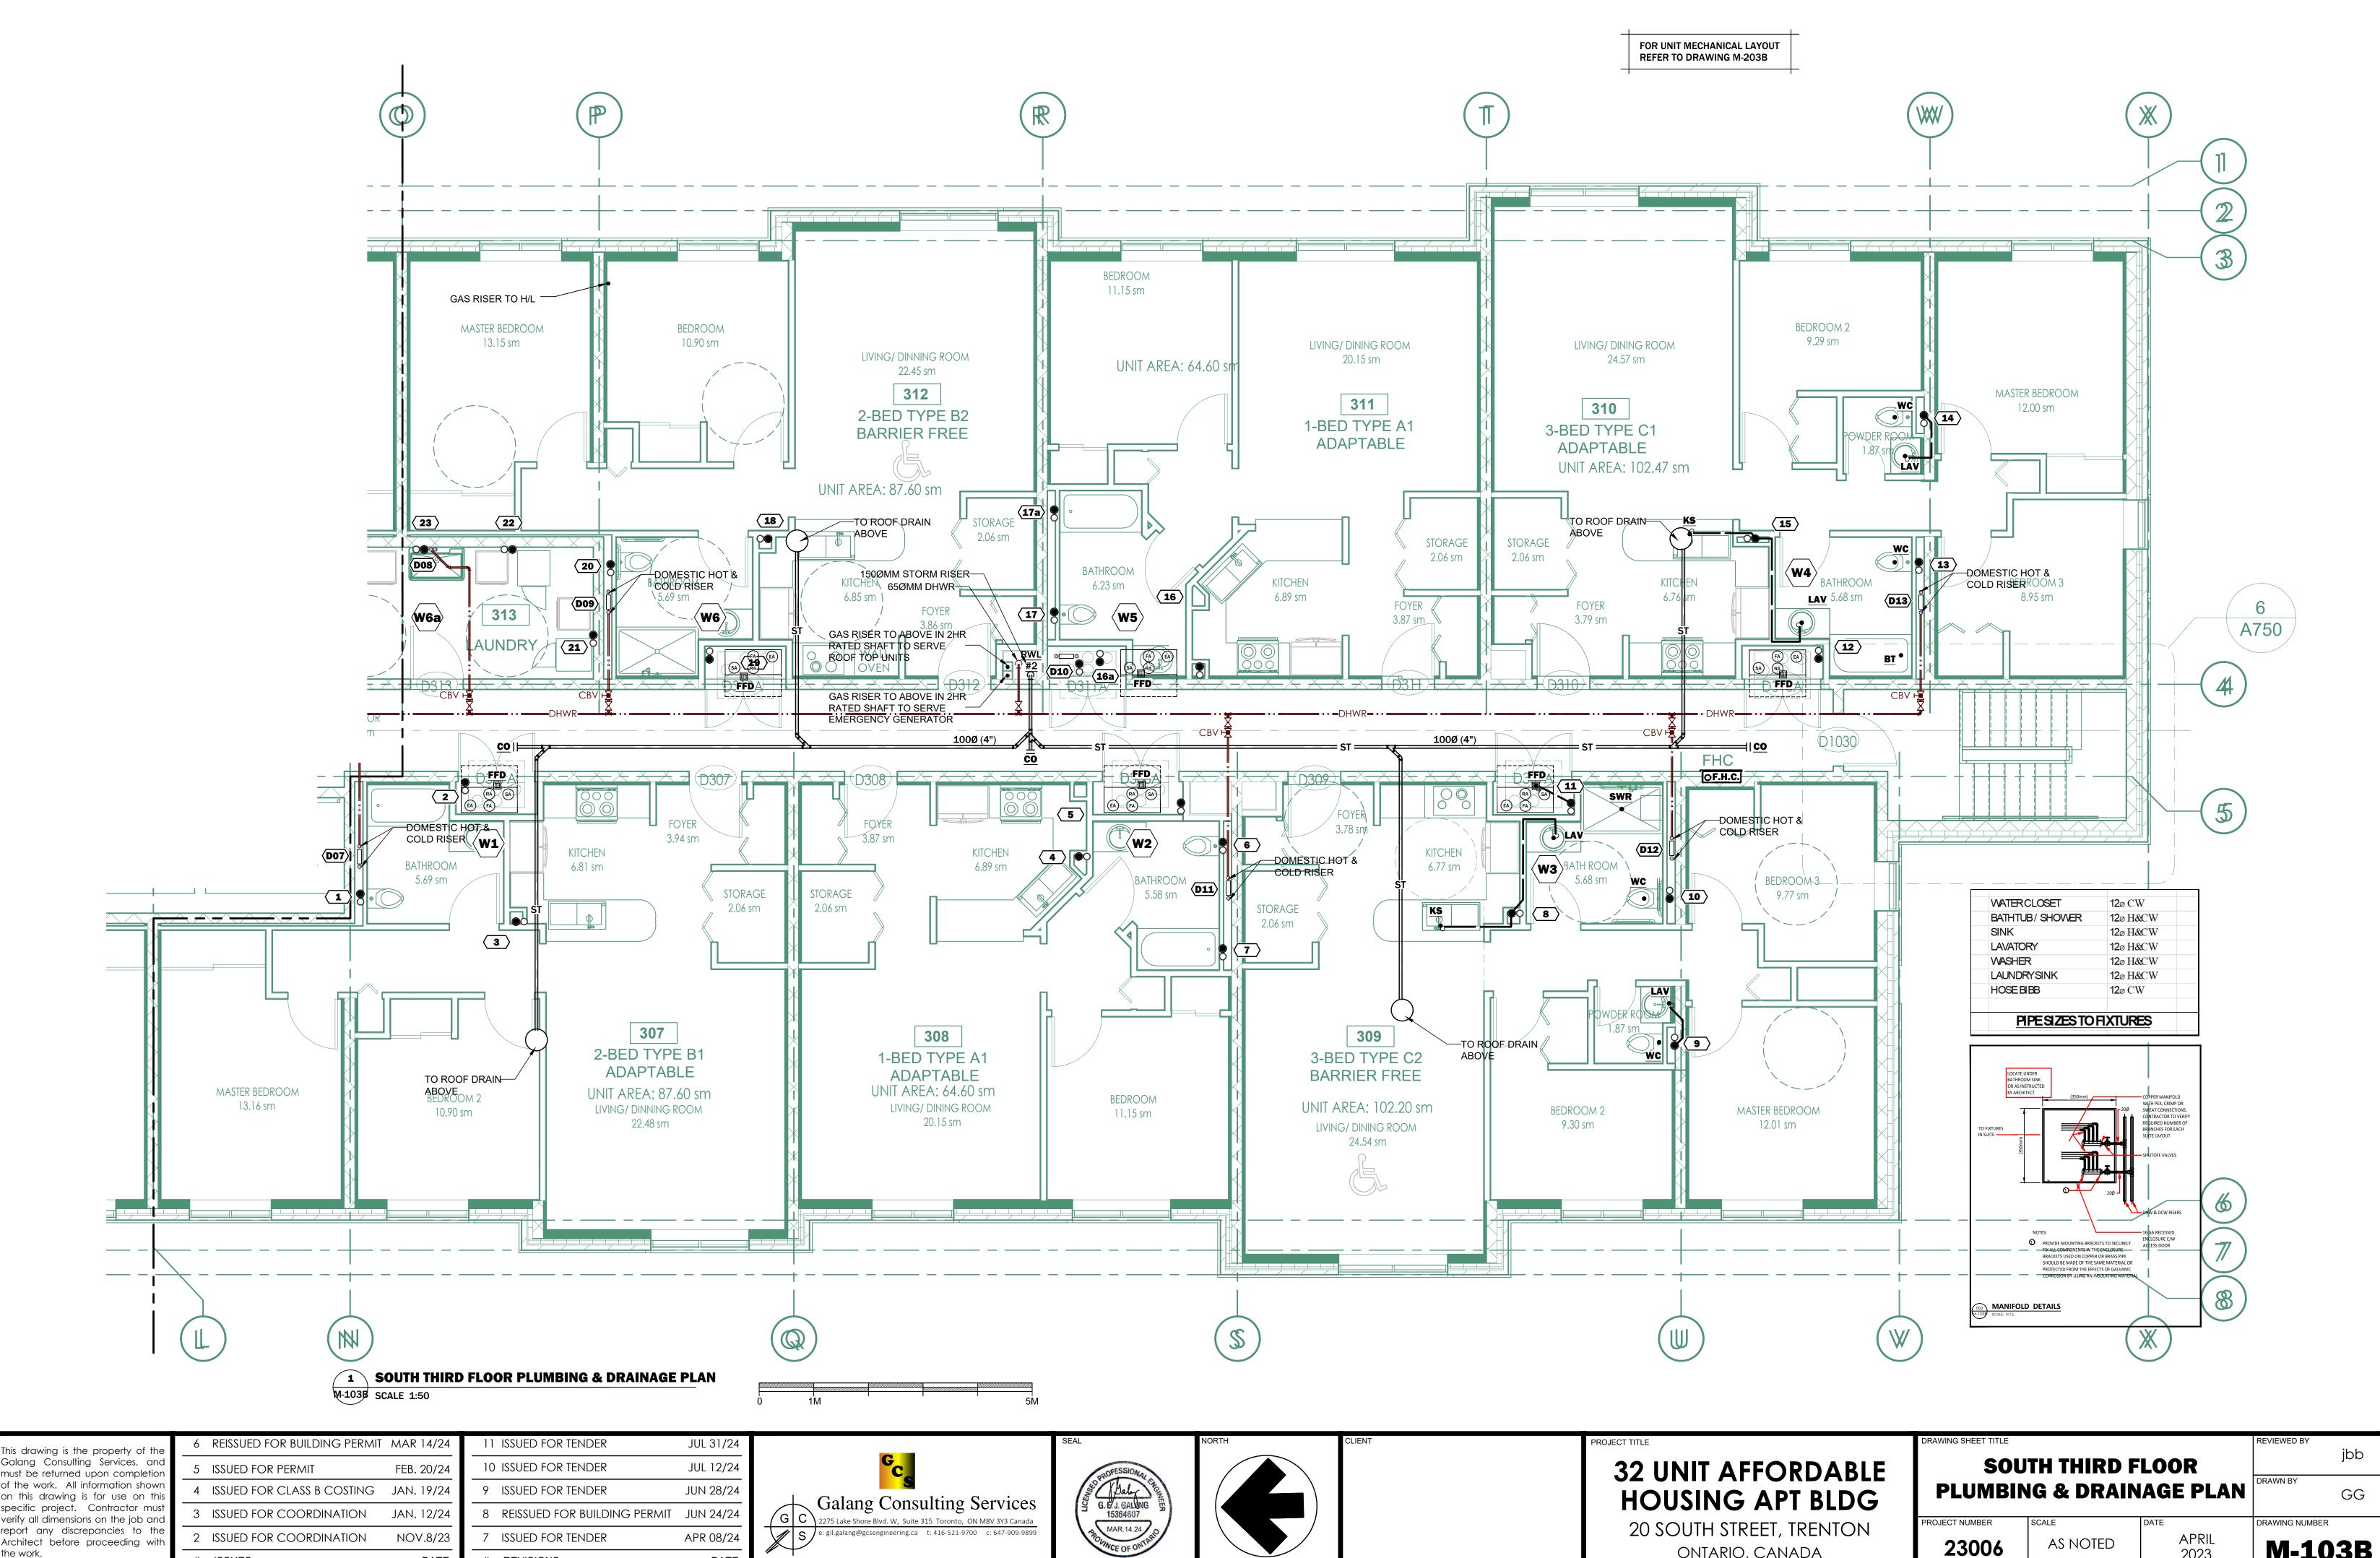
ONTARIO, CANADA

23006

AS NOTED

APRIL 2023

M-103A



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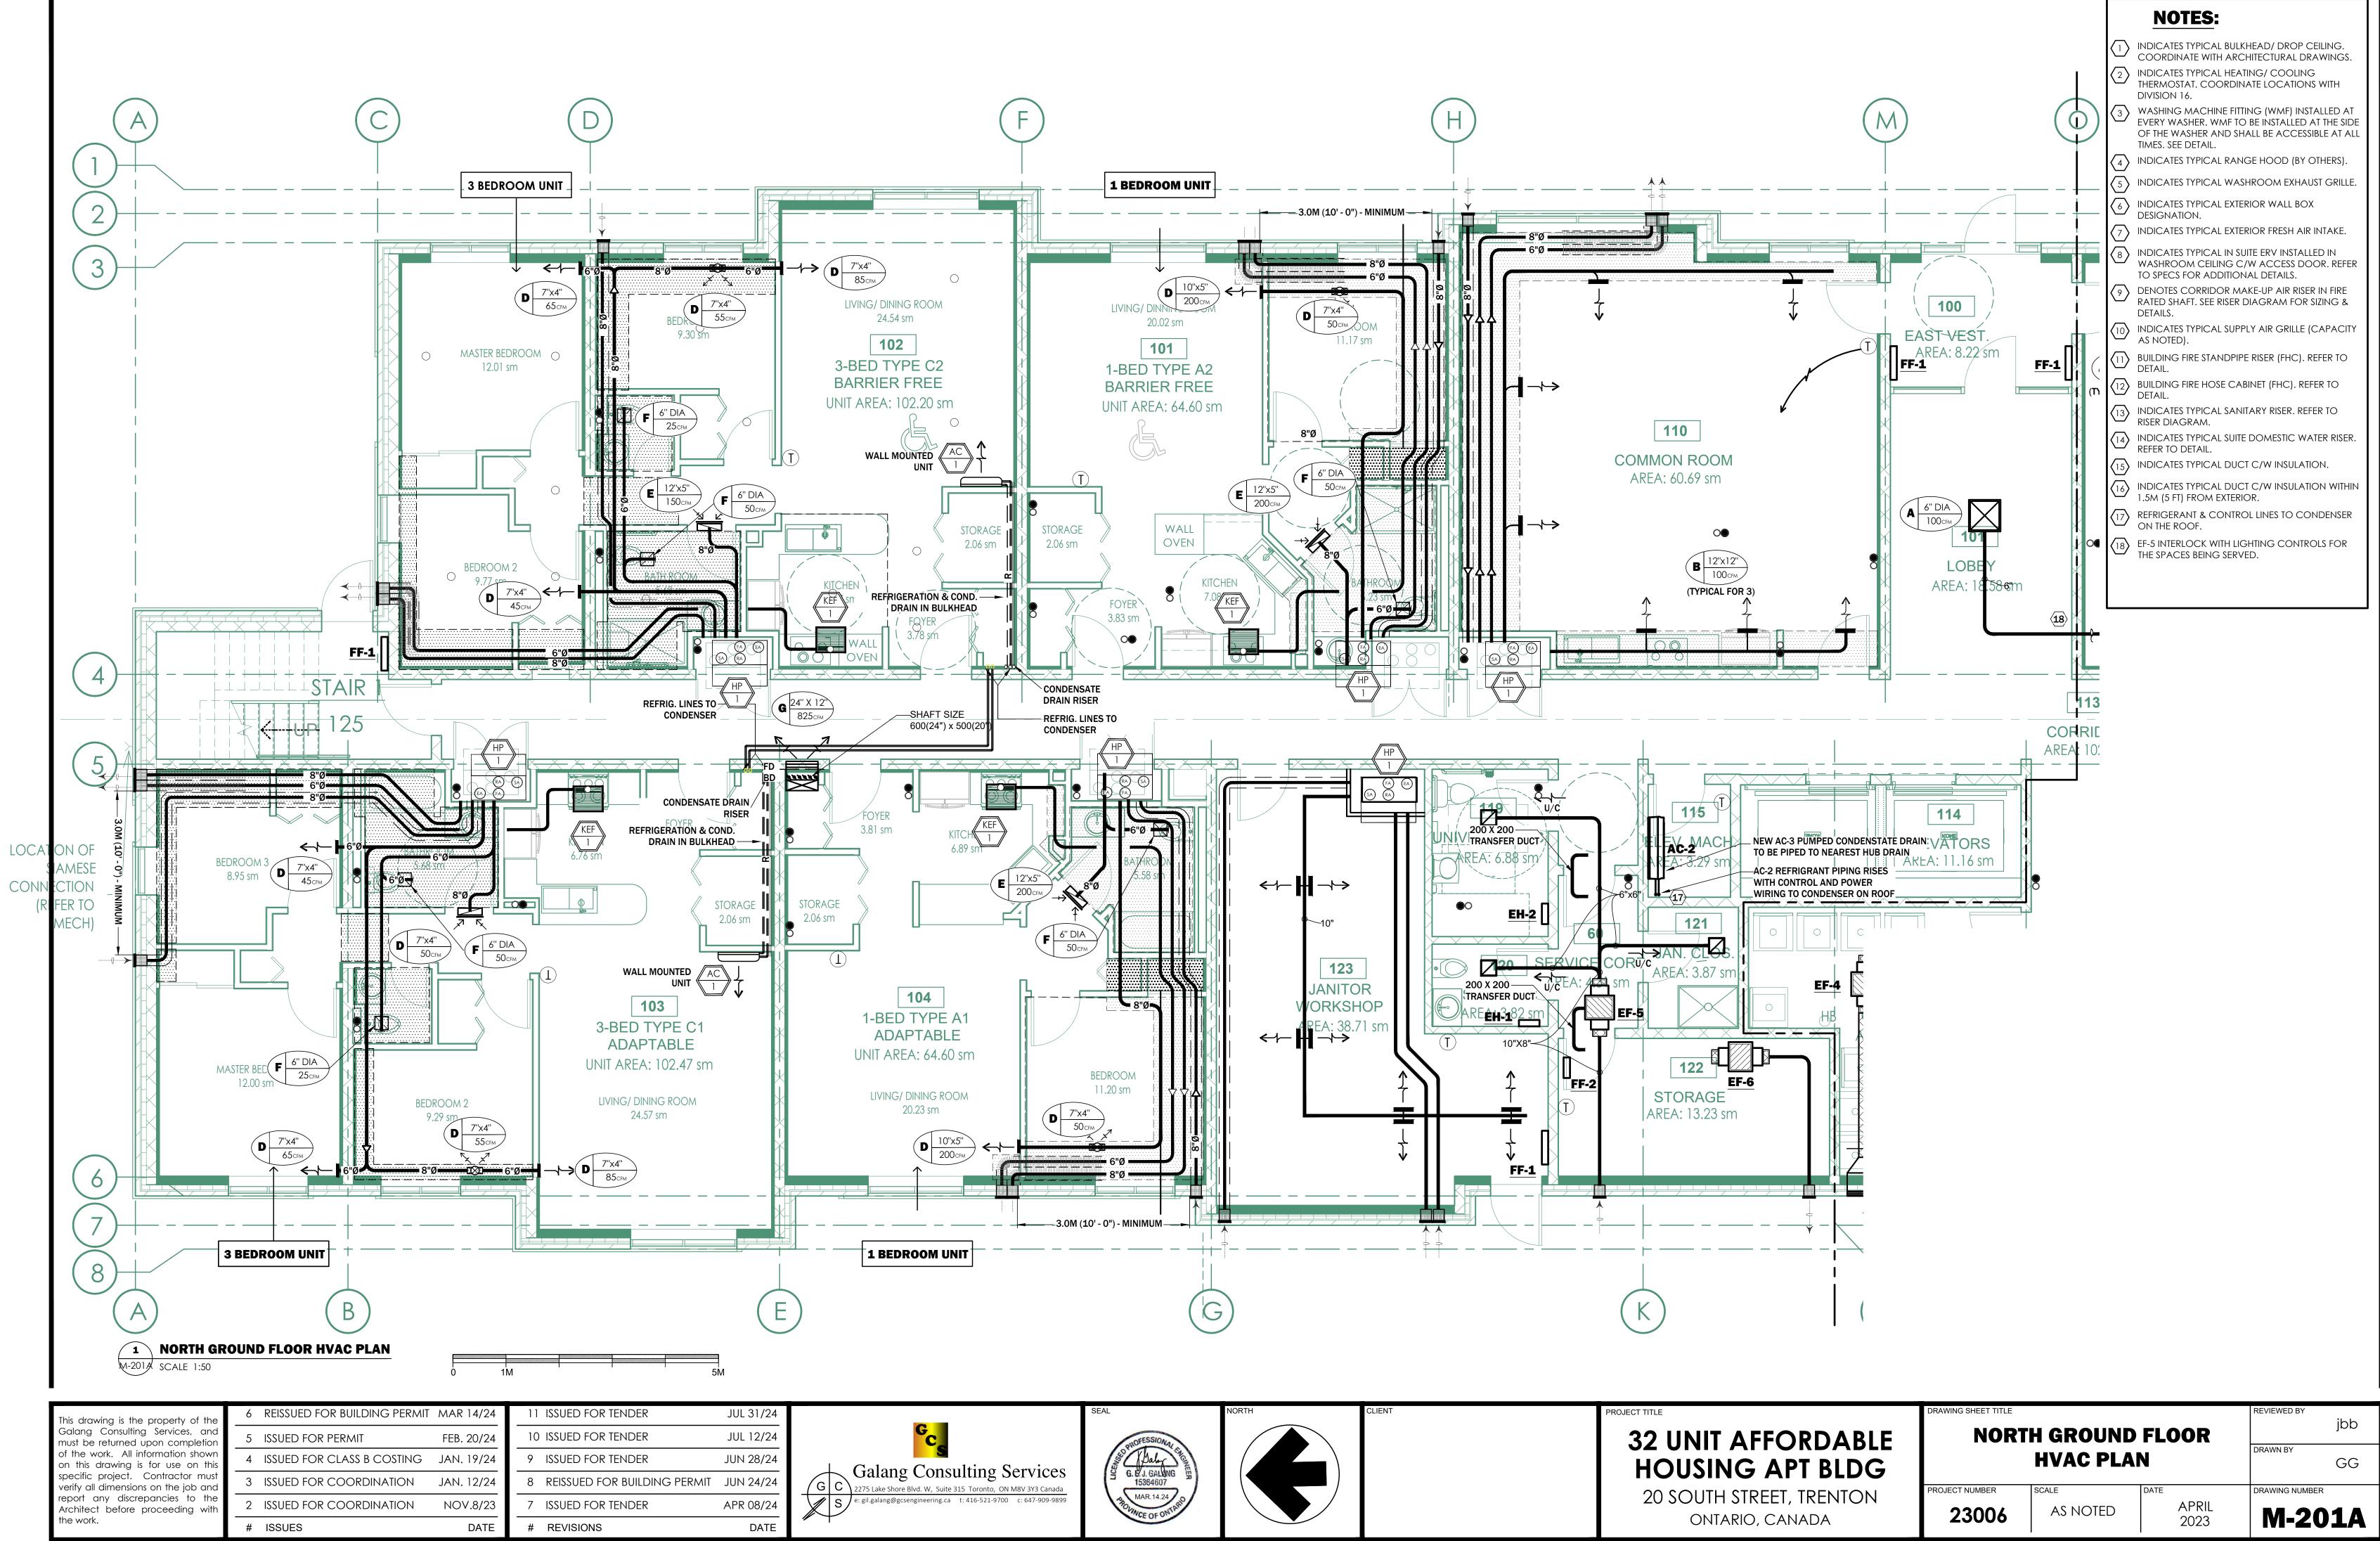
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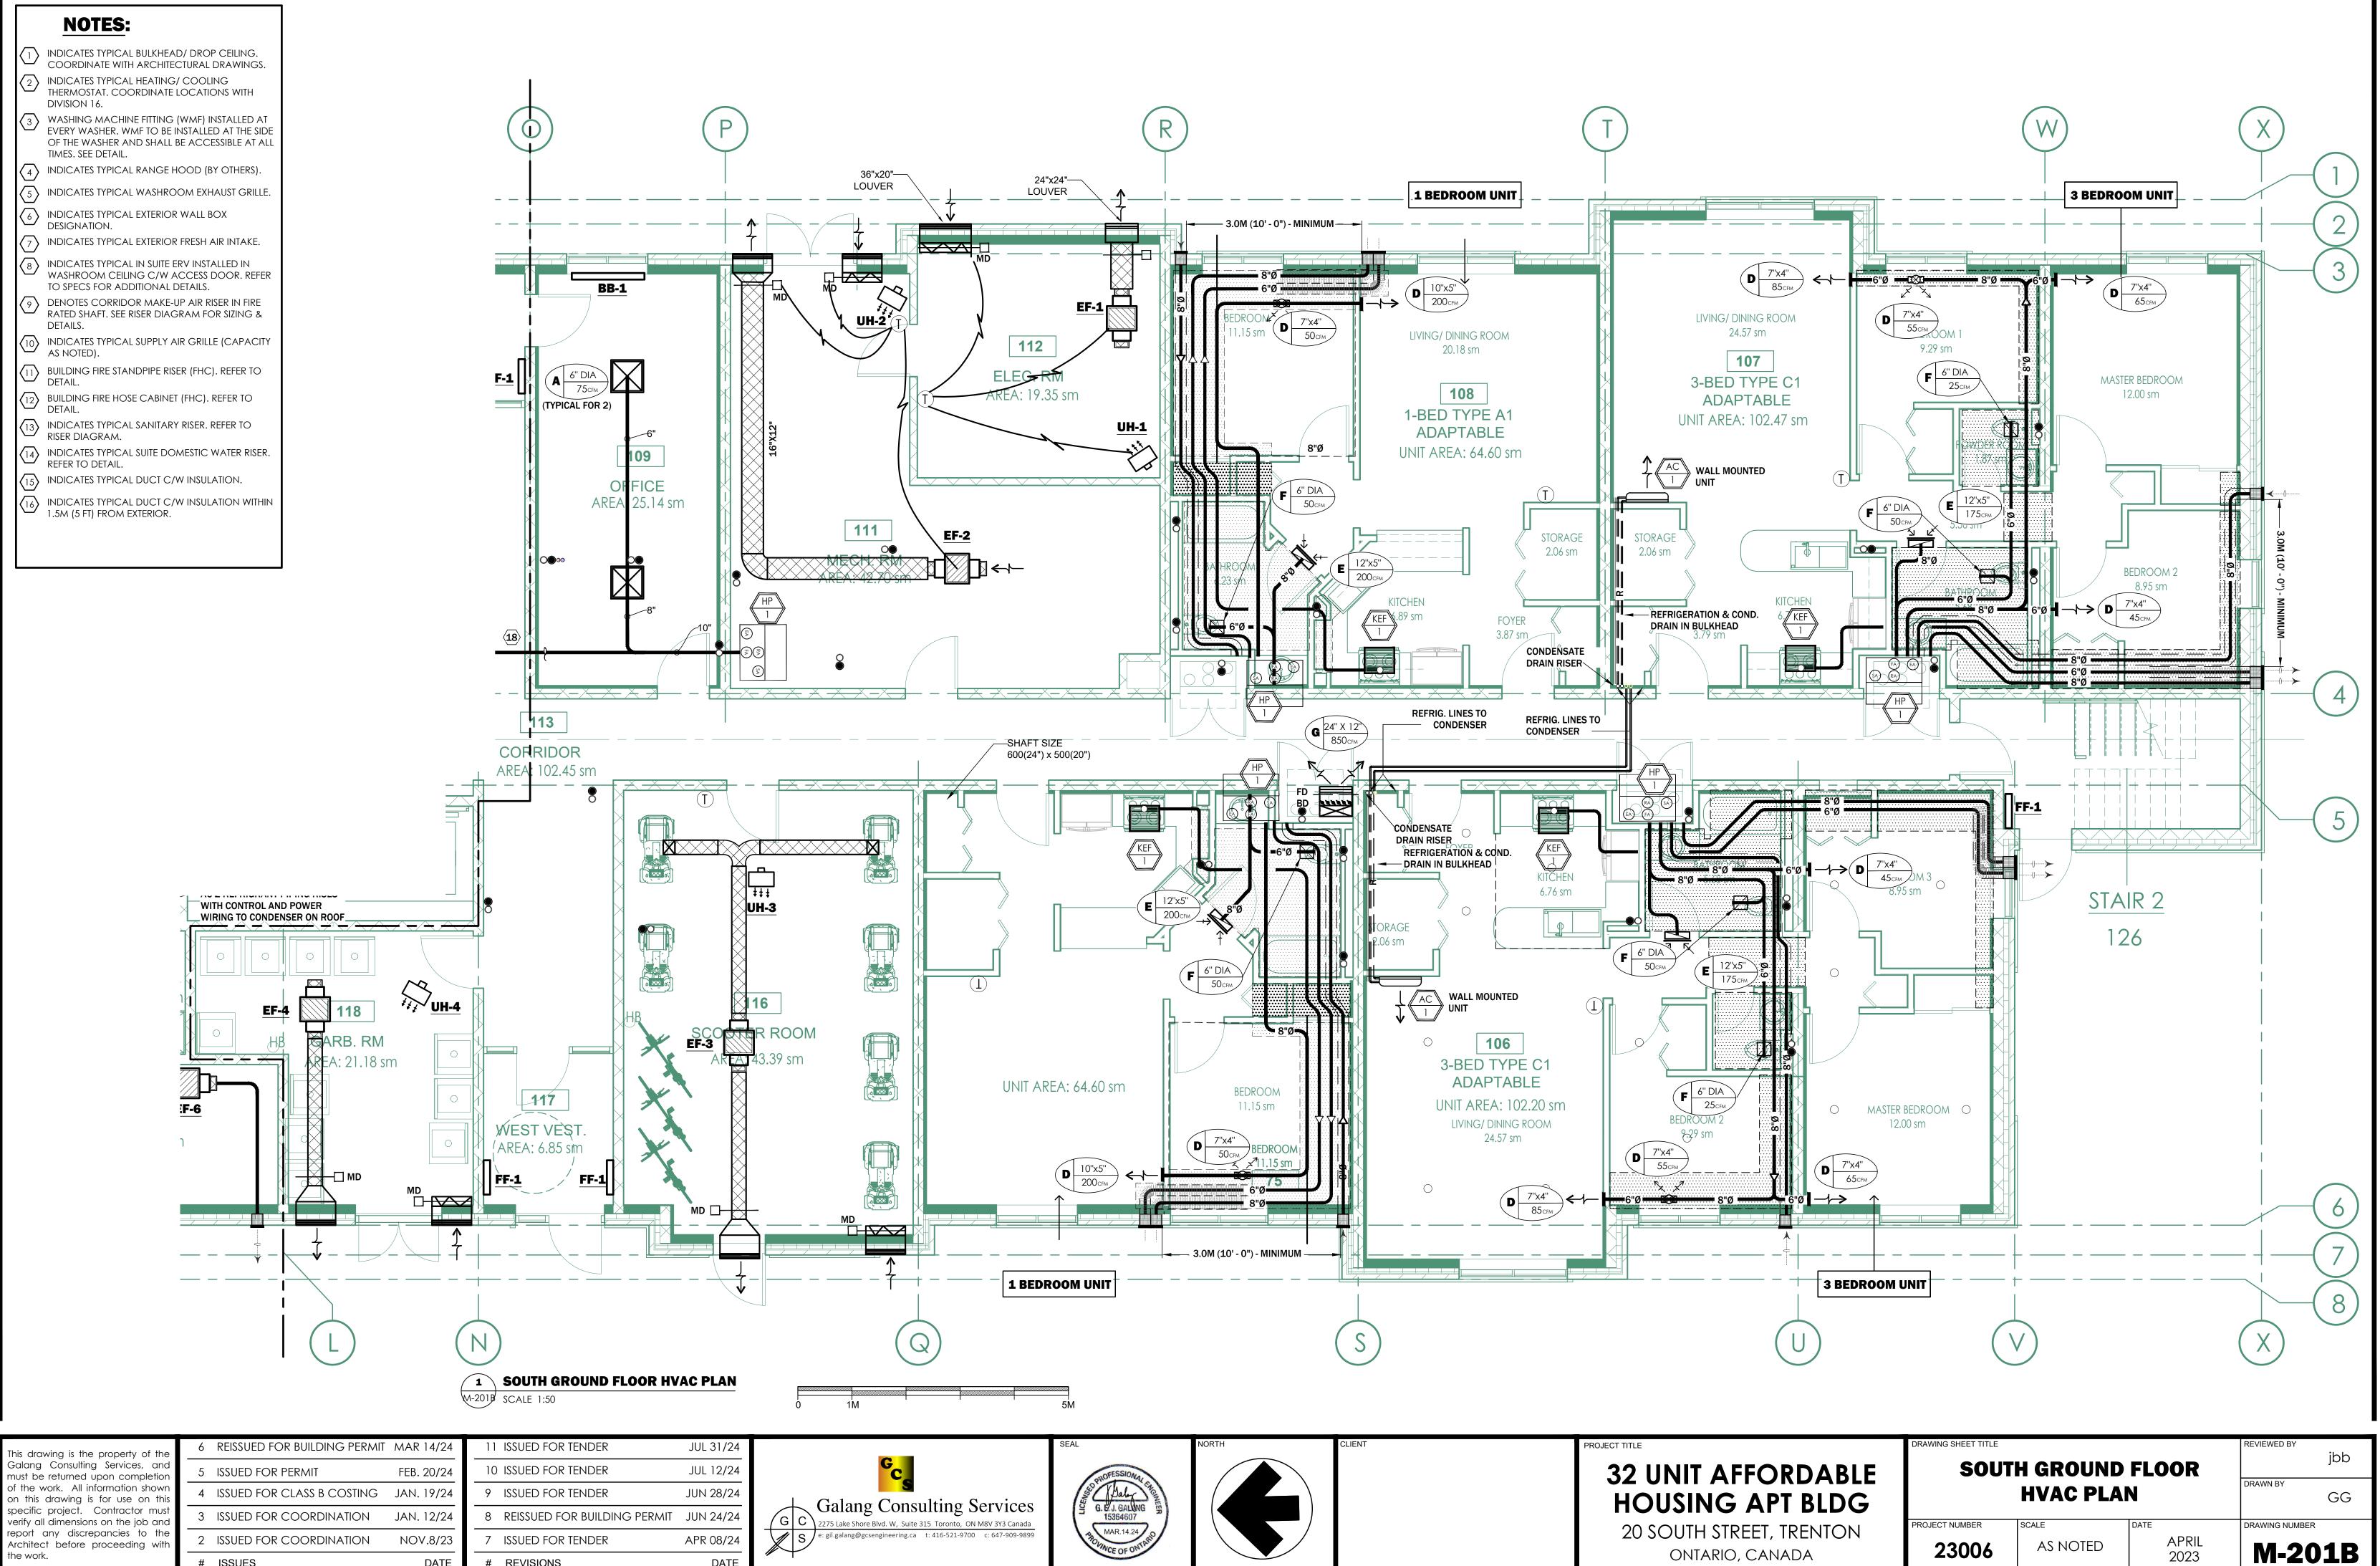
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ONTARIO, CANADA

APRIL 2023


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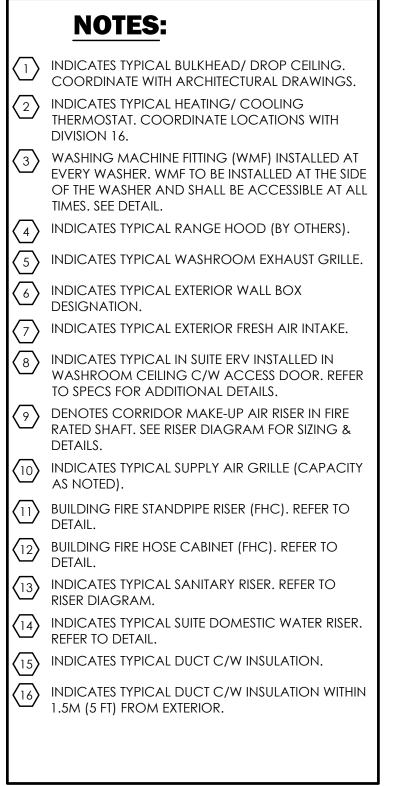



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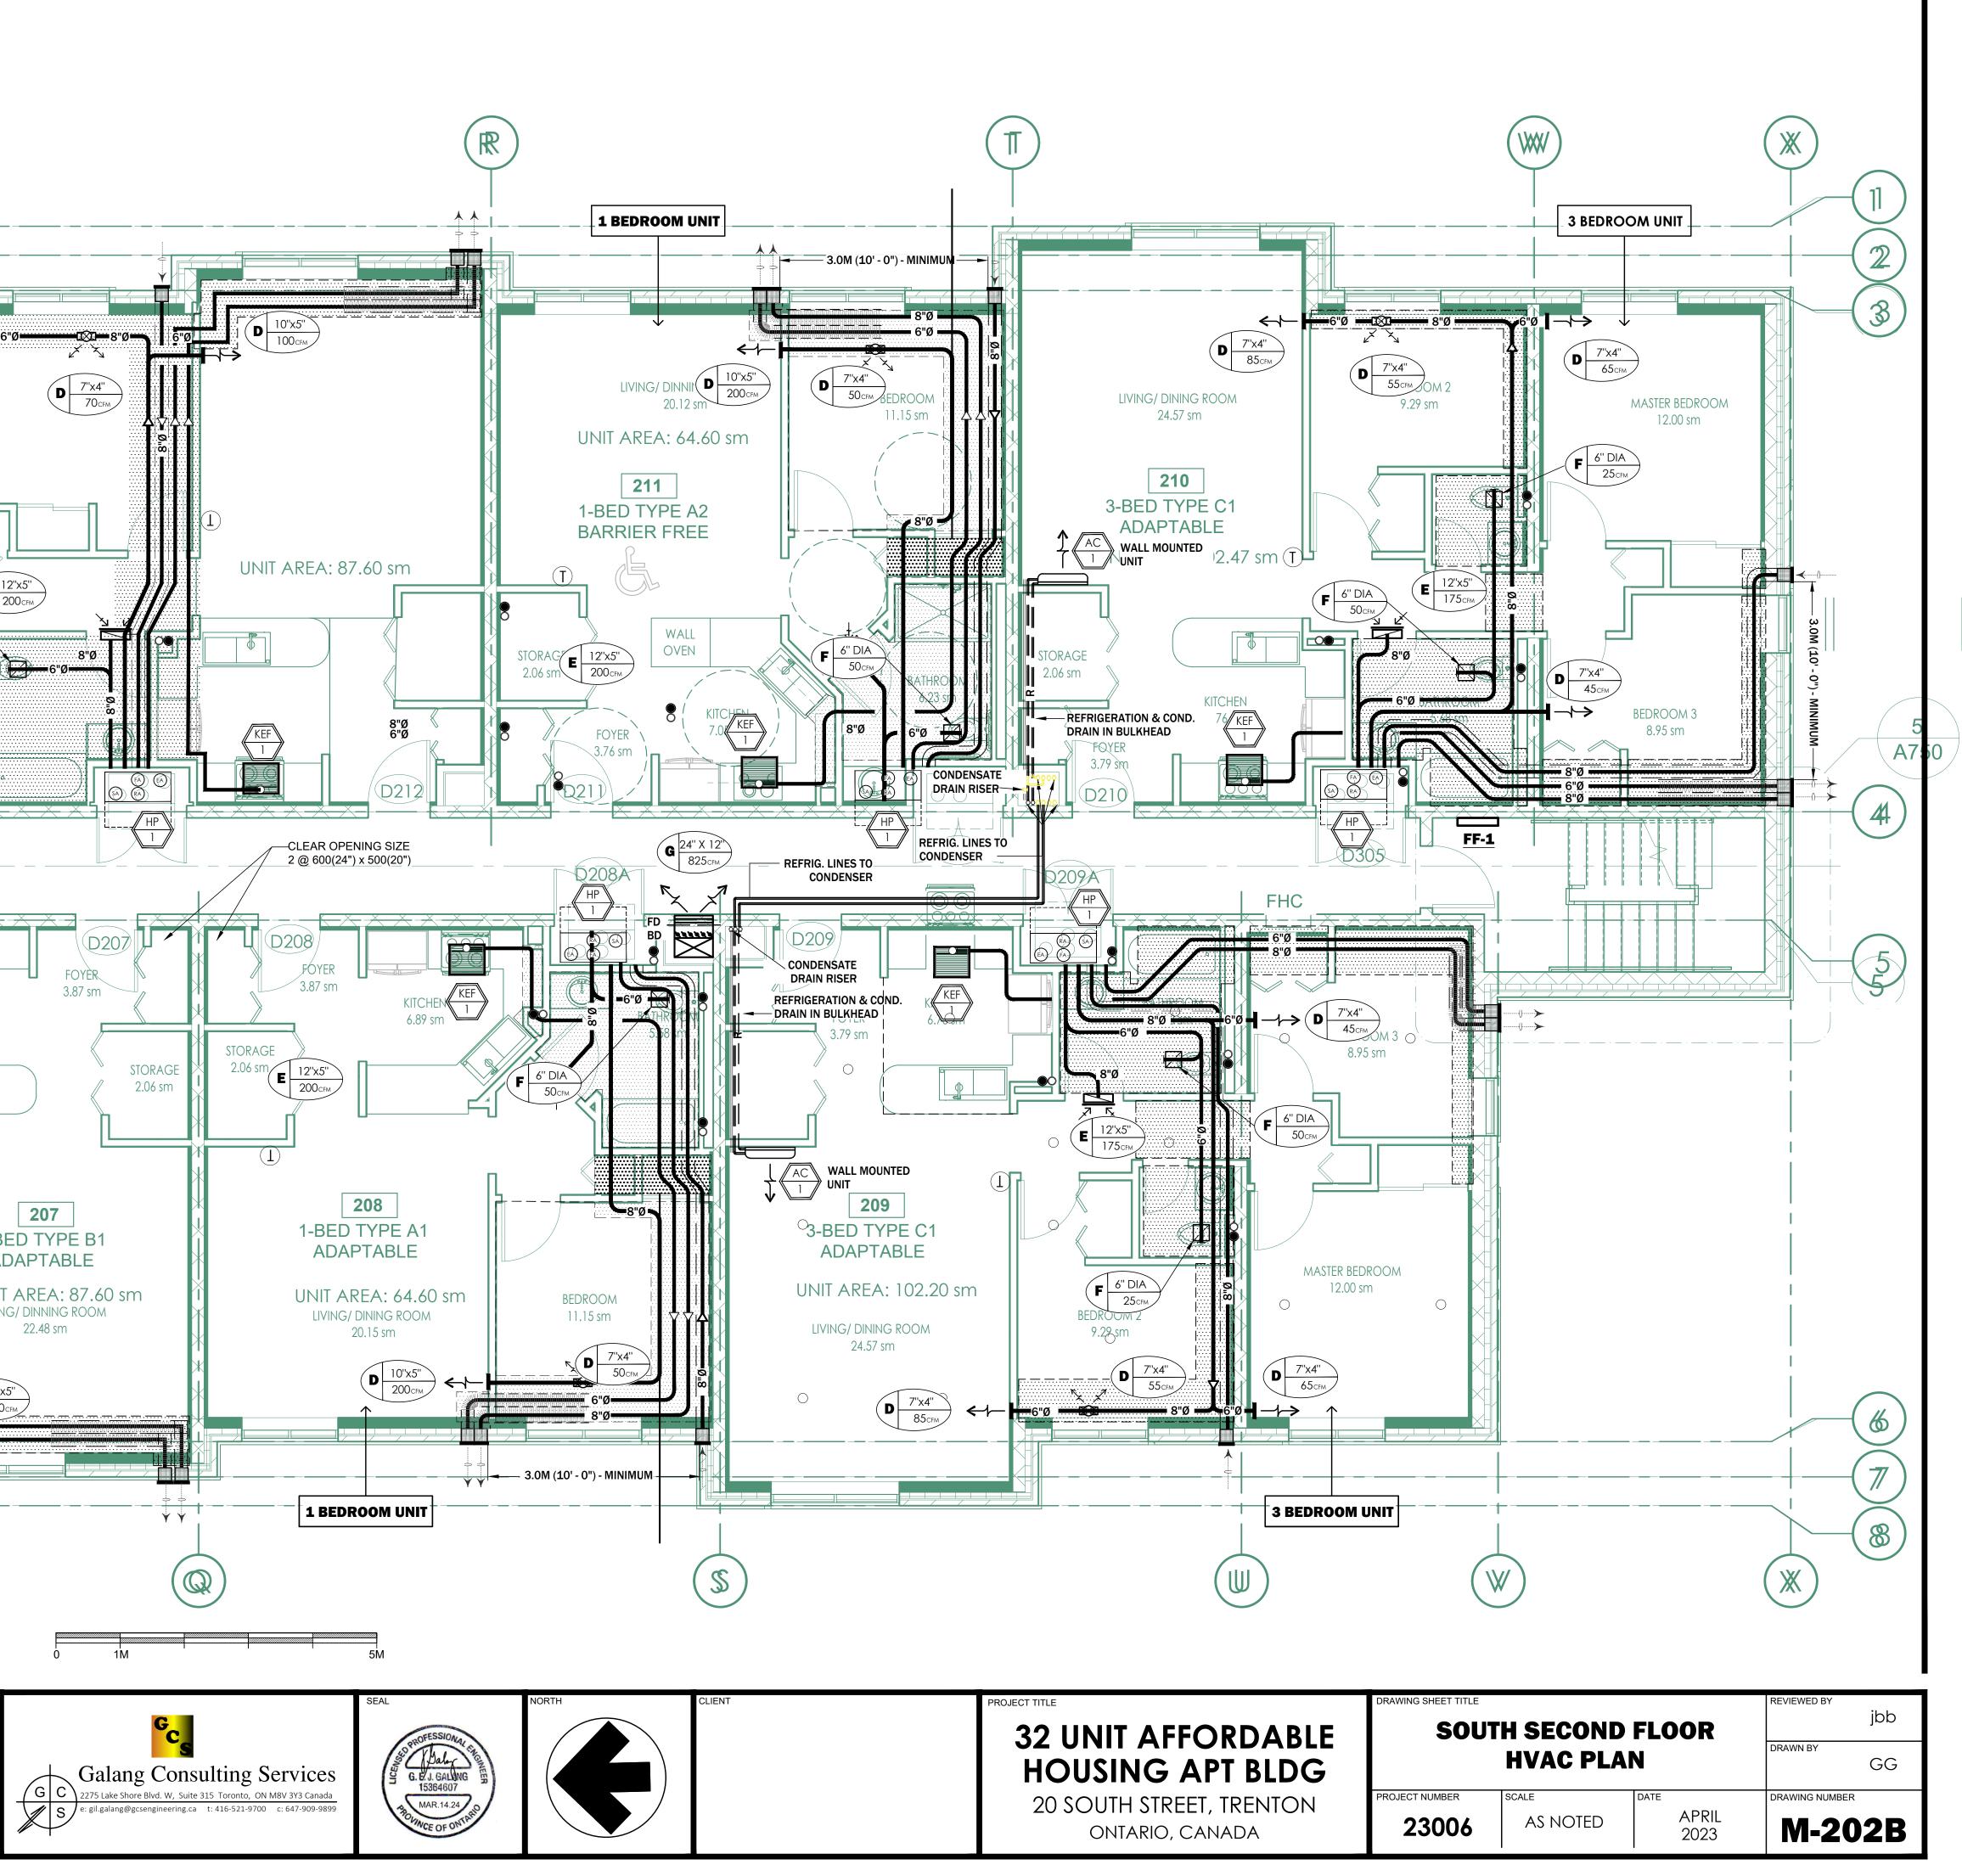






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#	ISSUES	DATE


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	8	REISSUED FOR BUILDING PERMIT	JUN 24/24	
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ONTARIO, CANADA

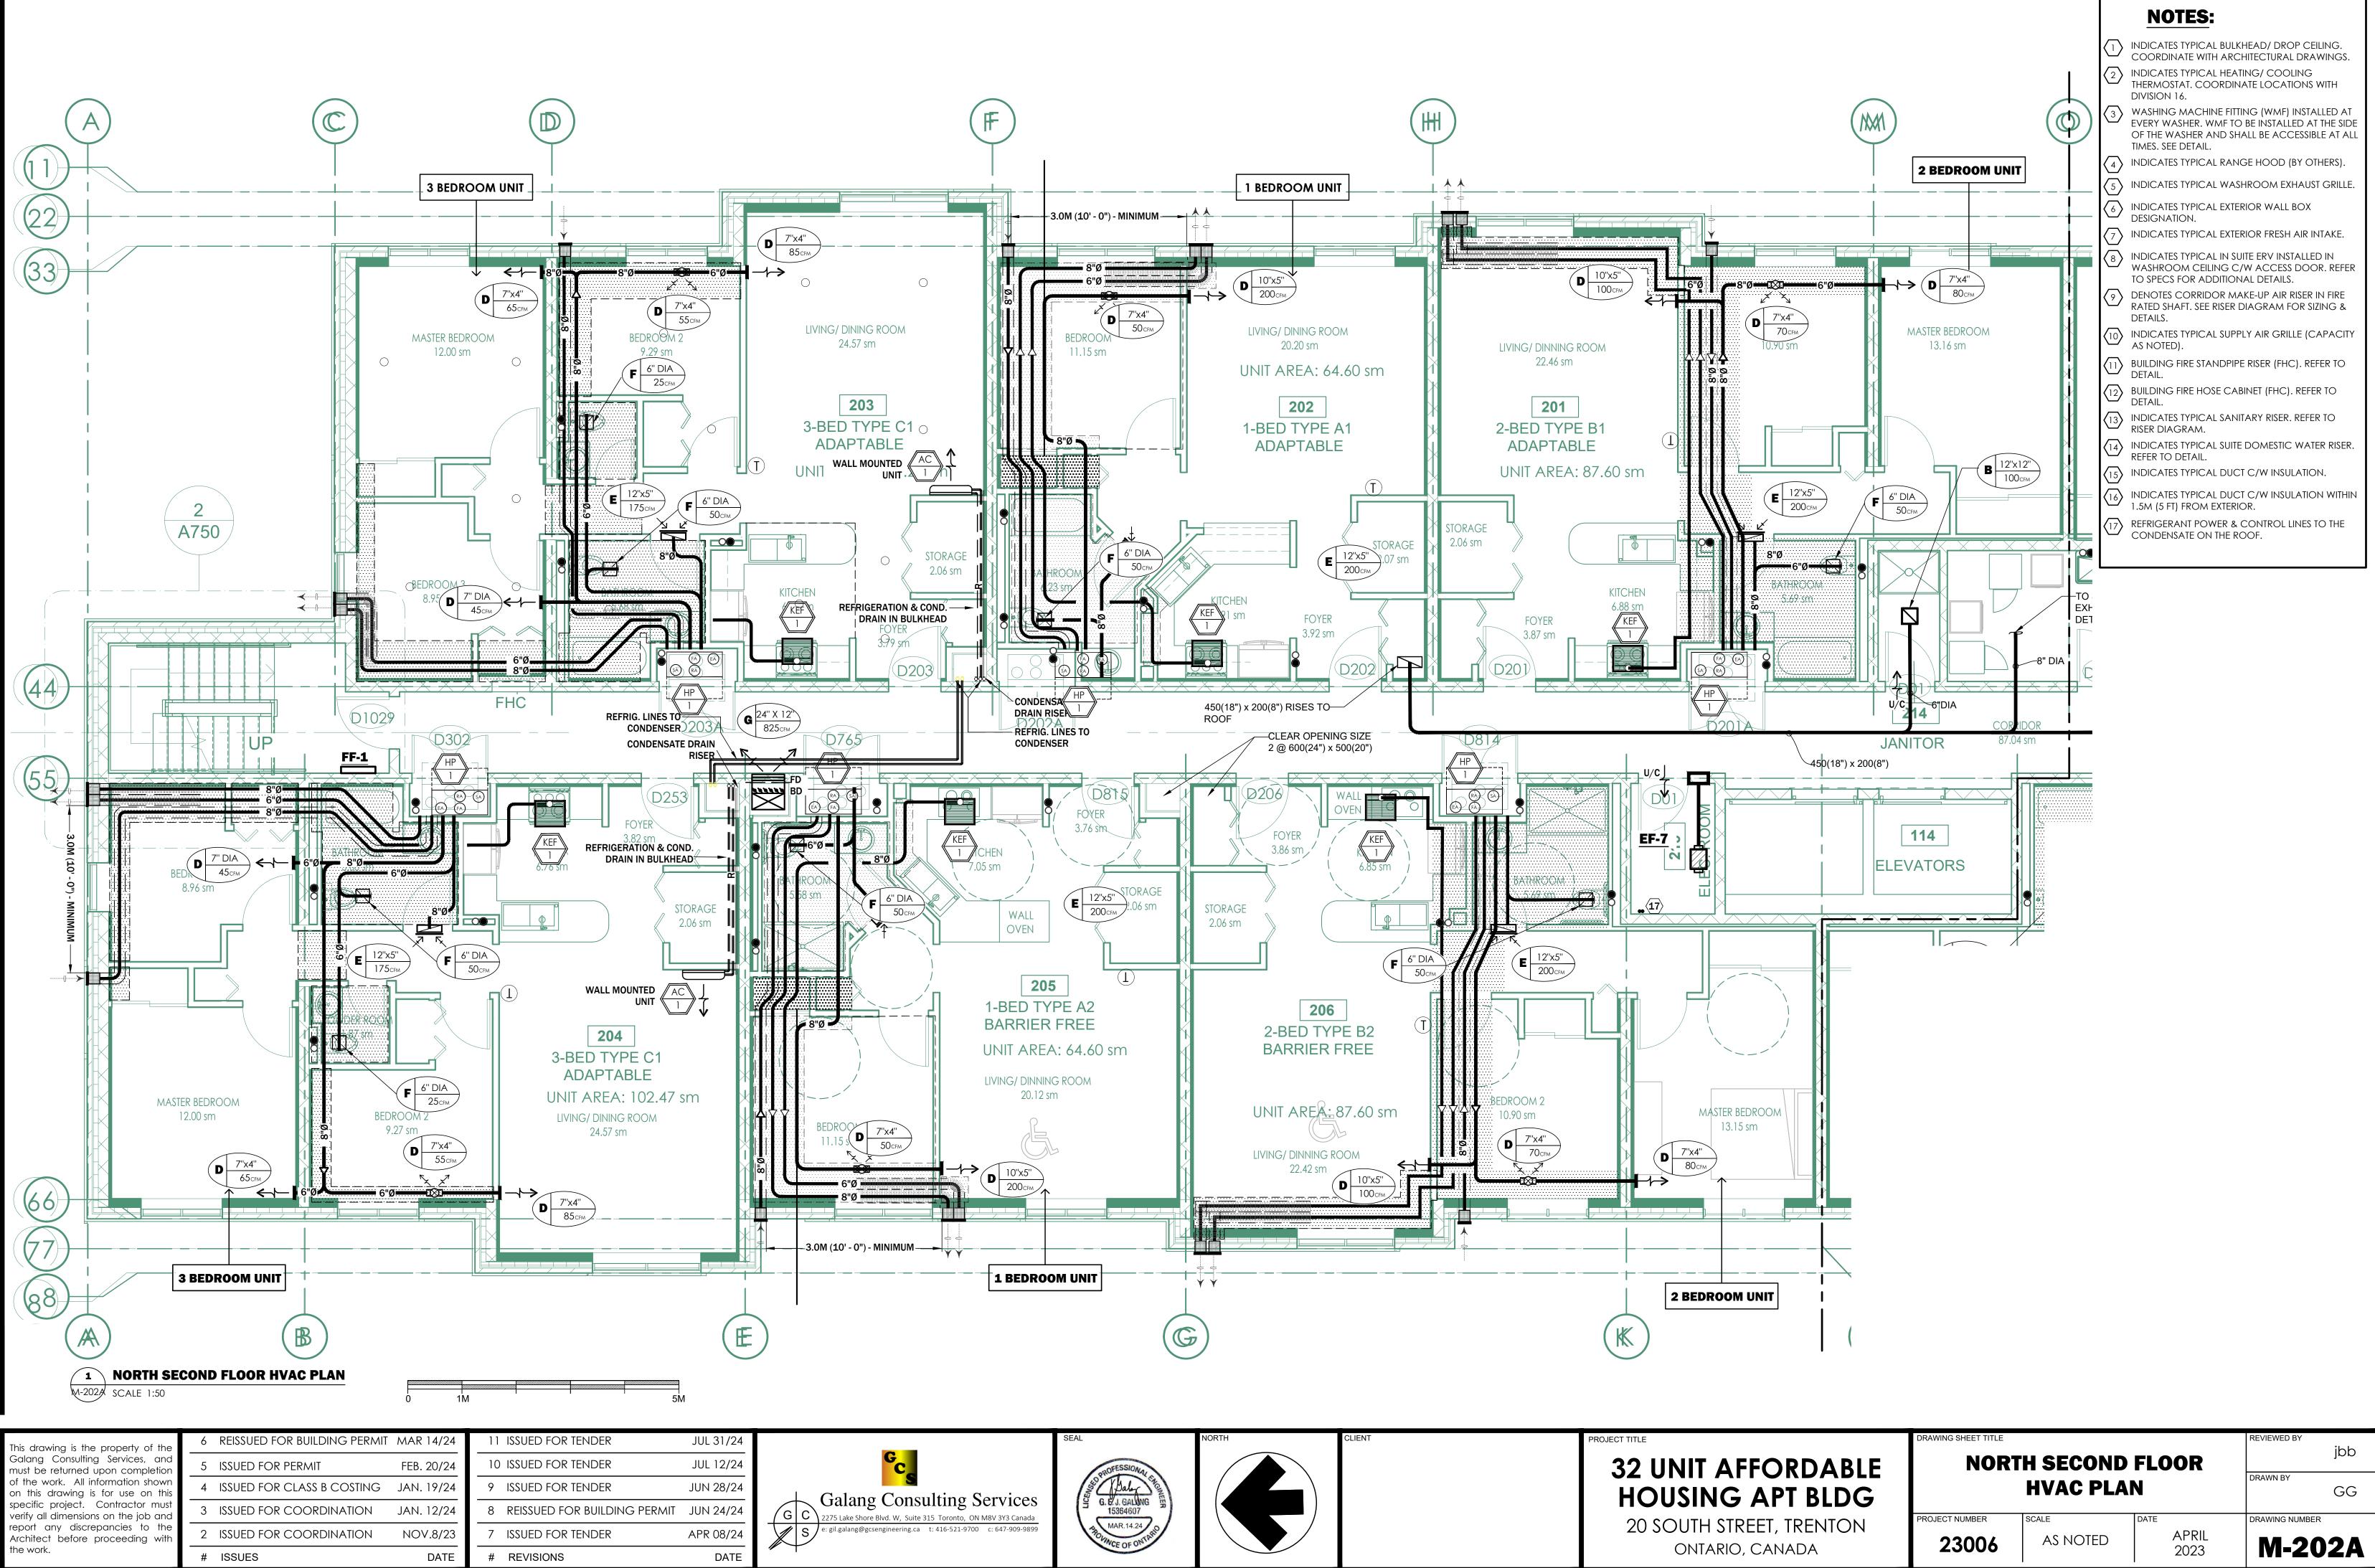23006
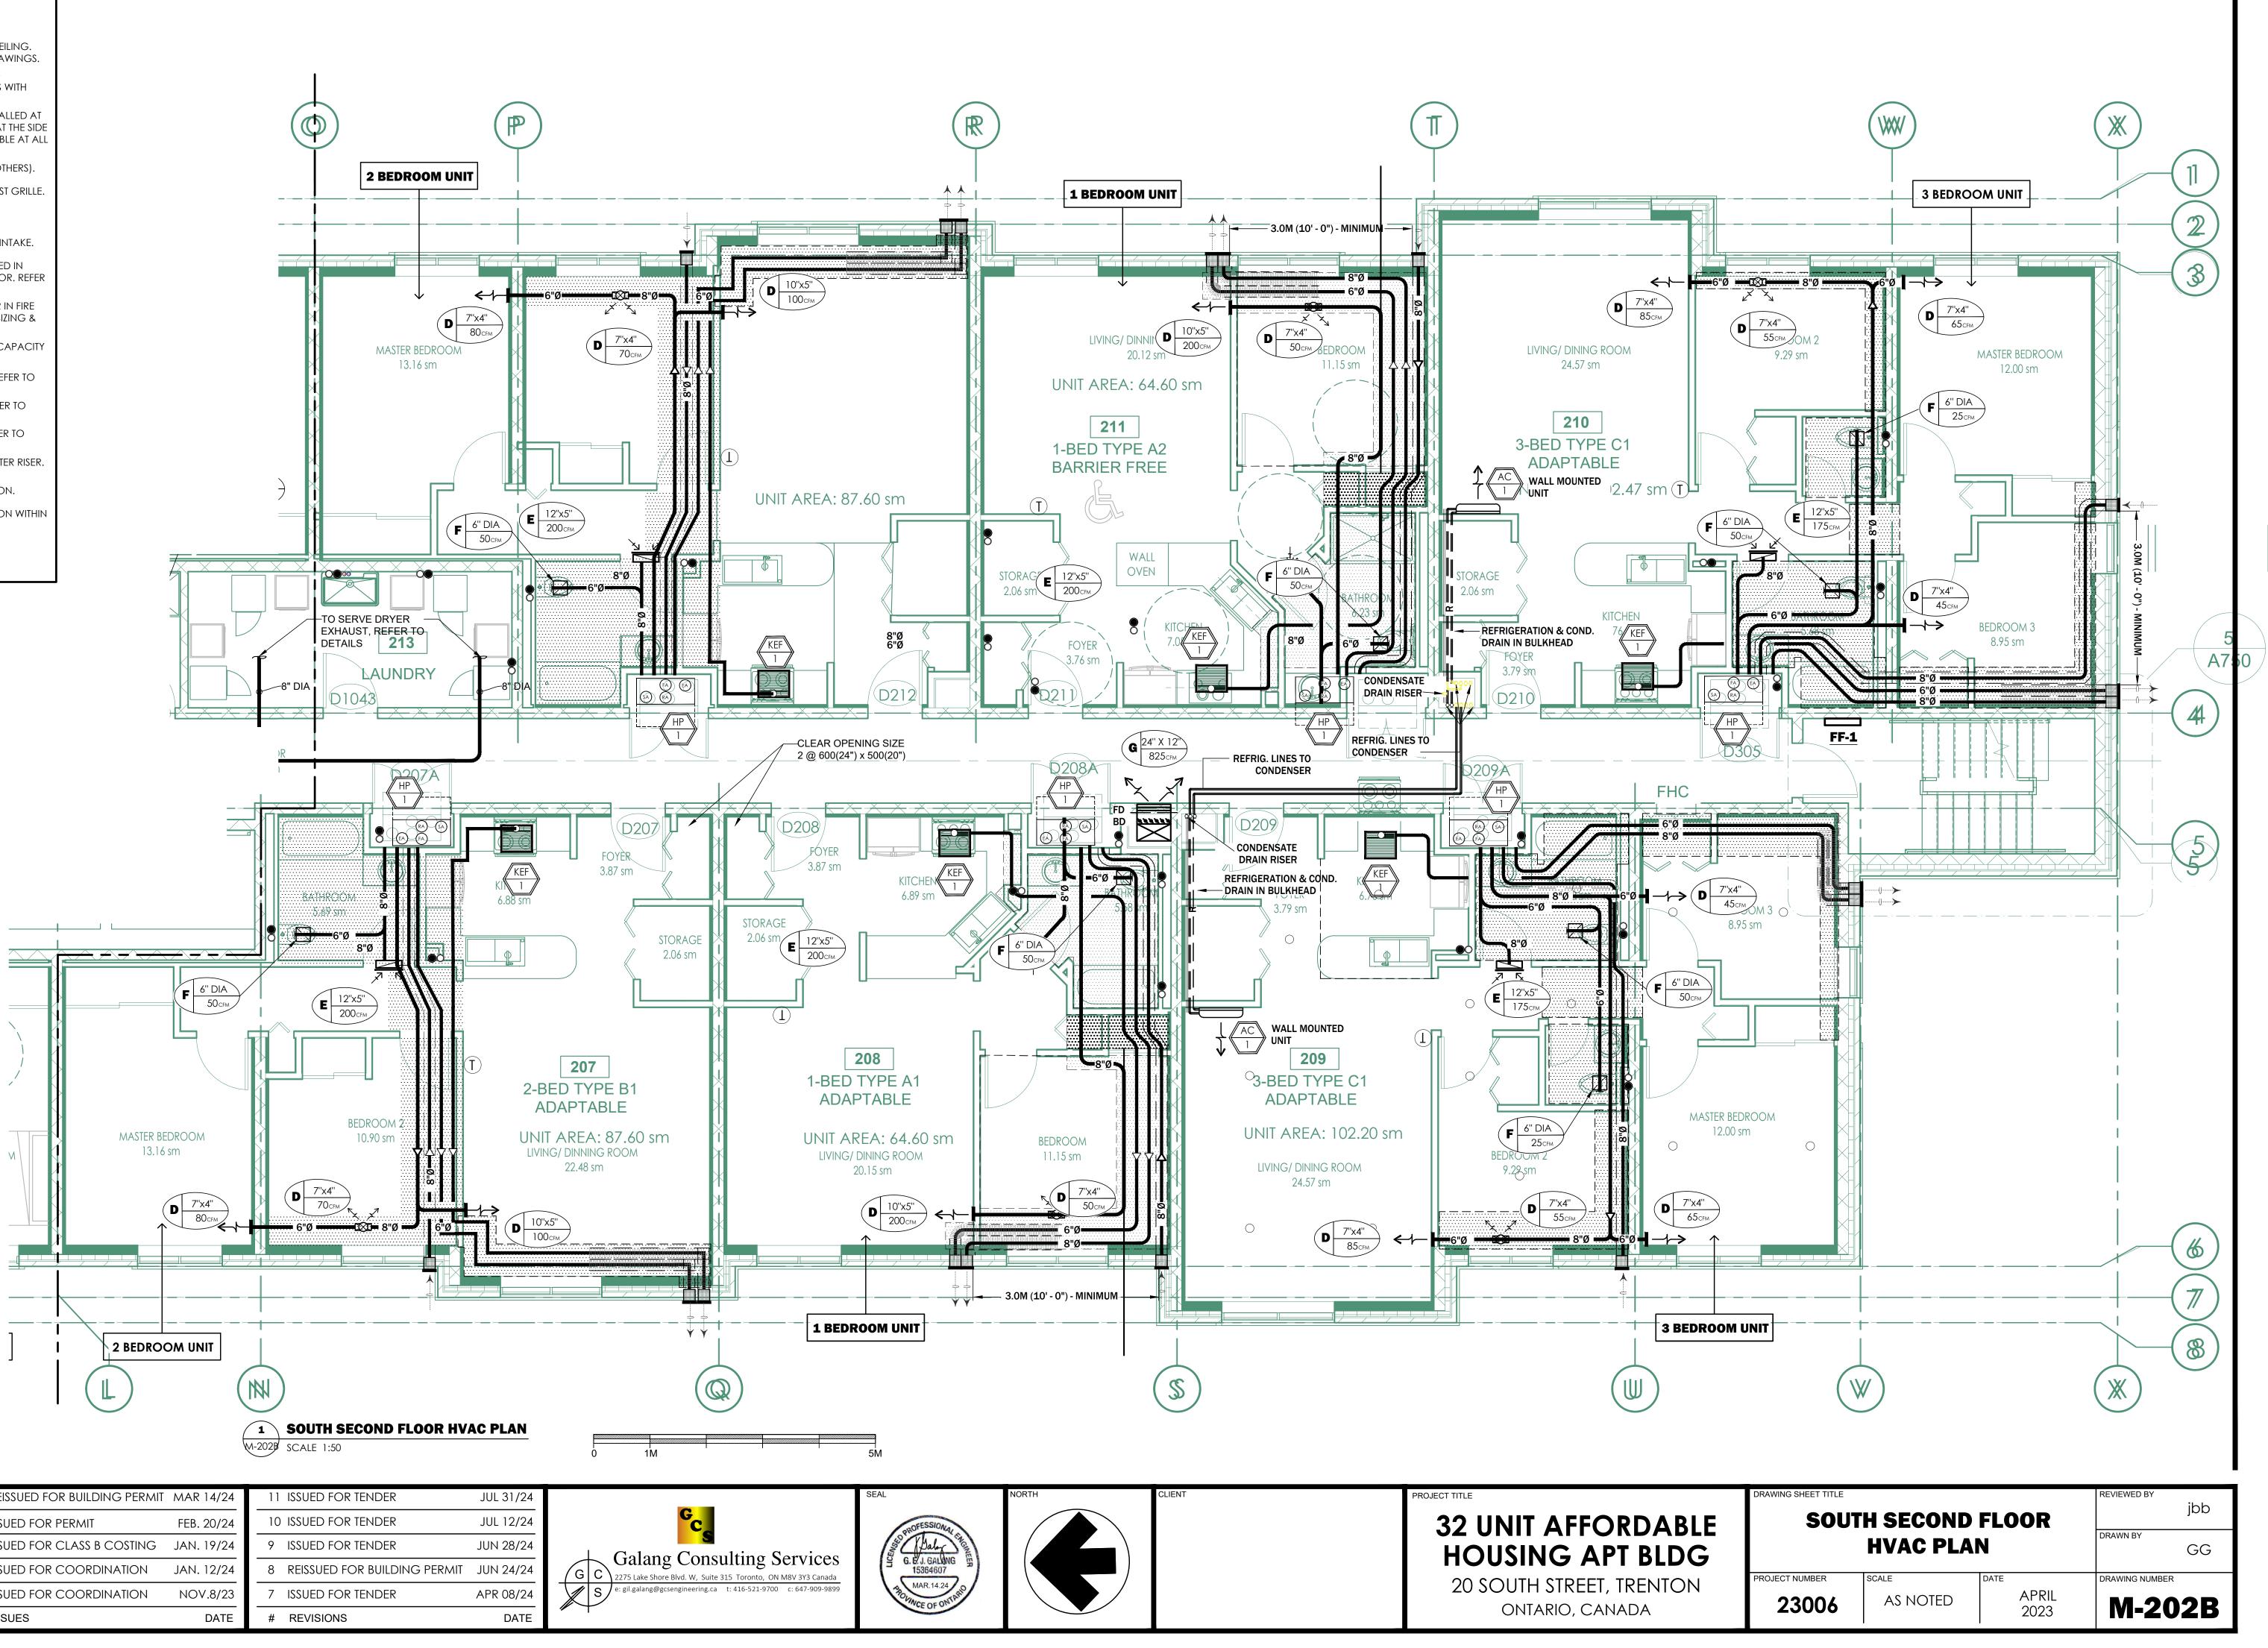
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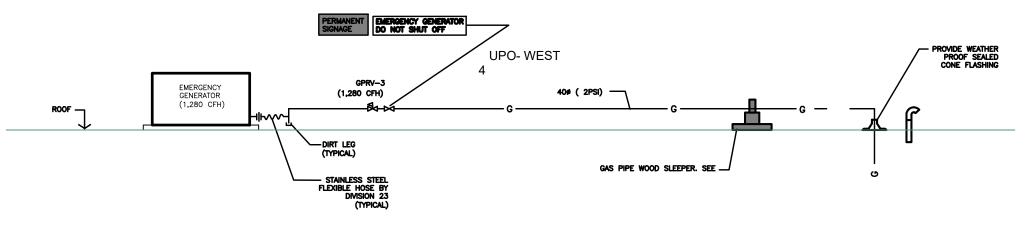


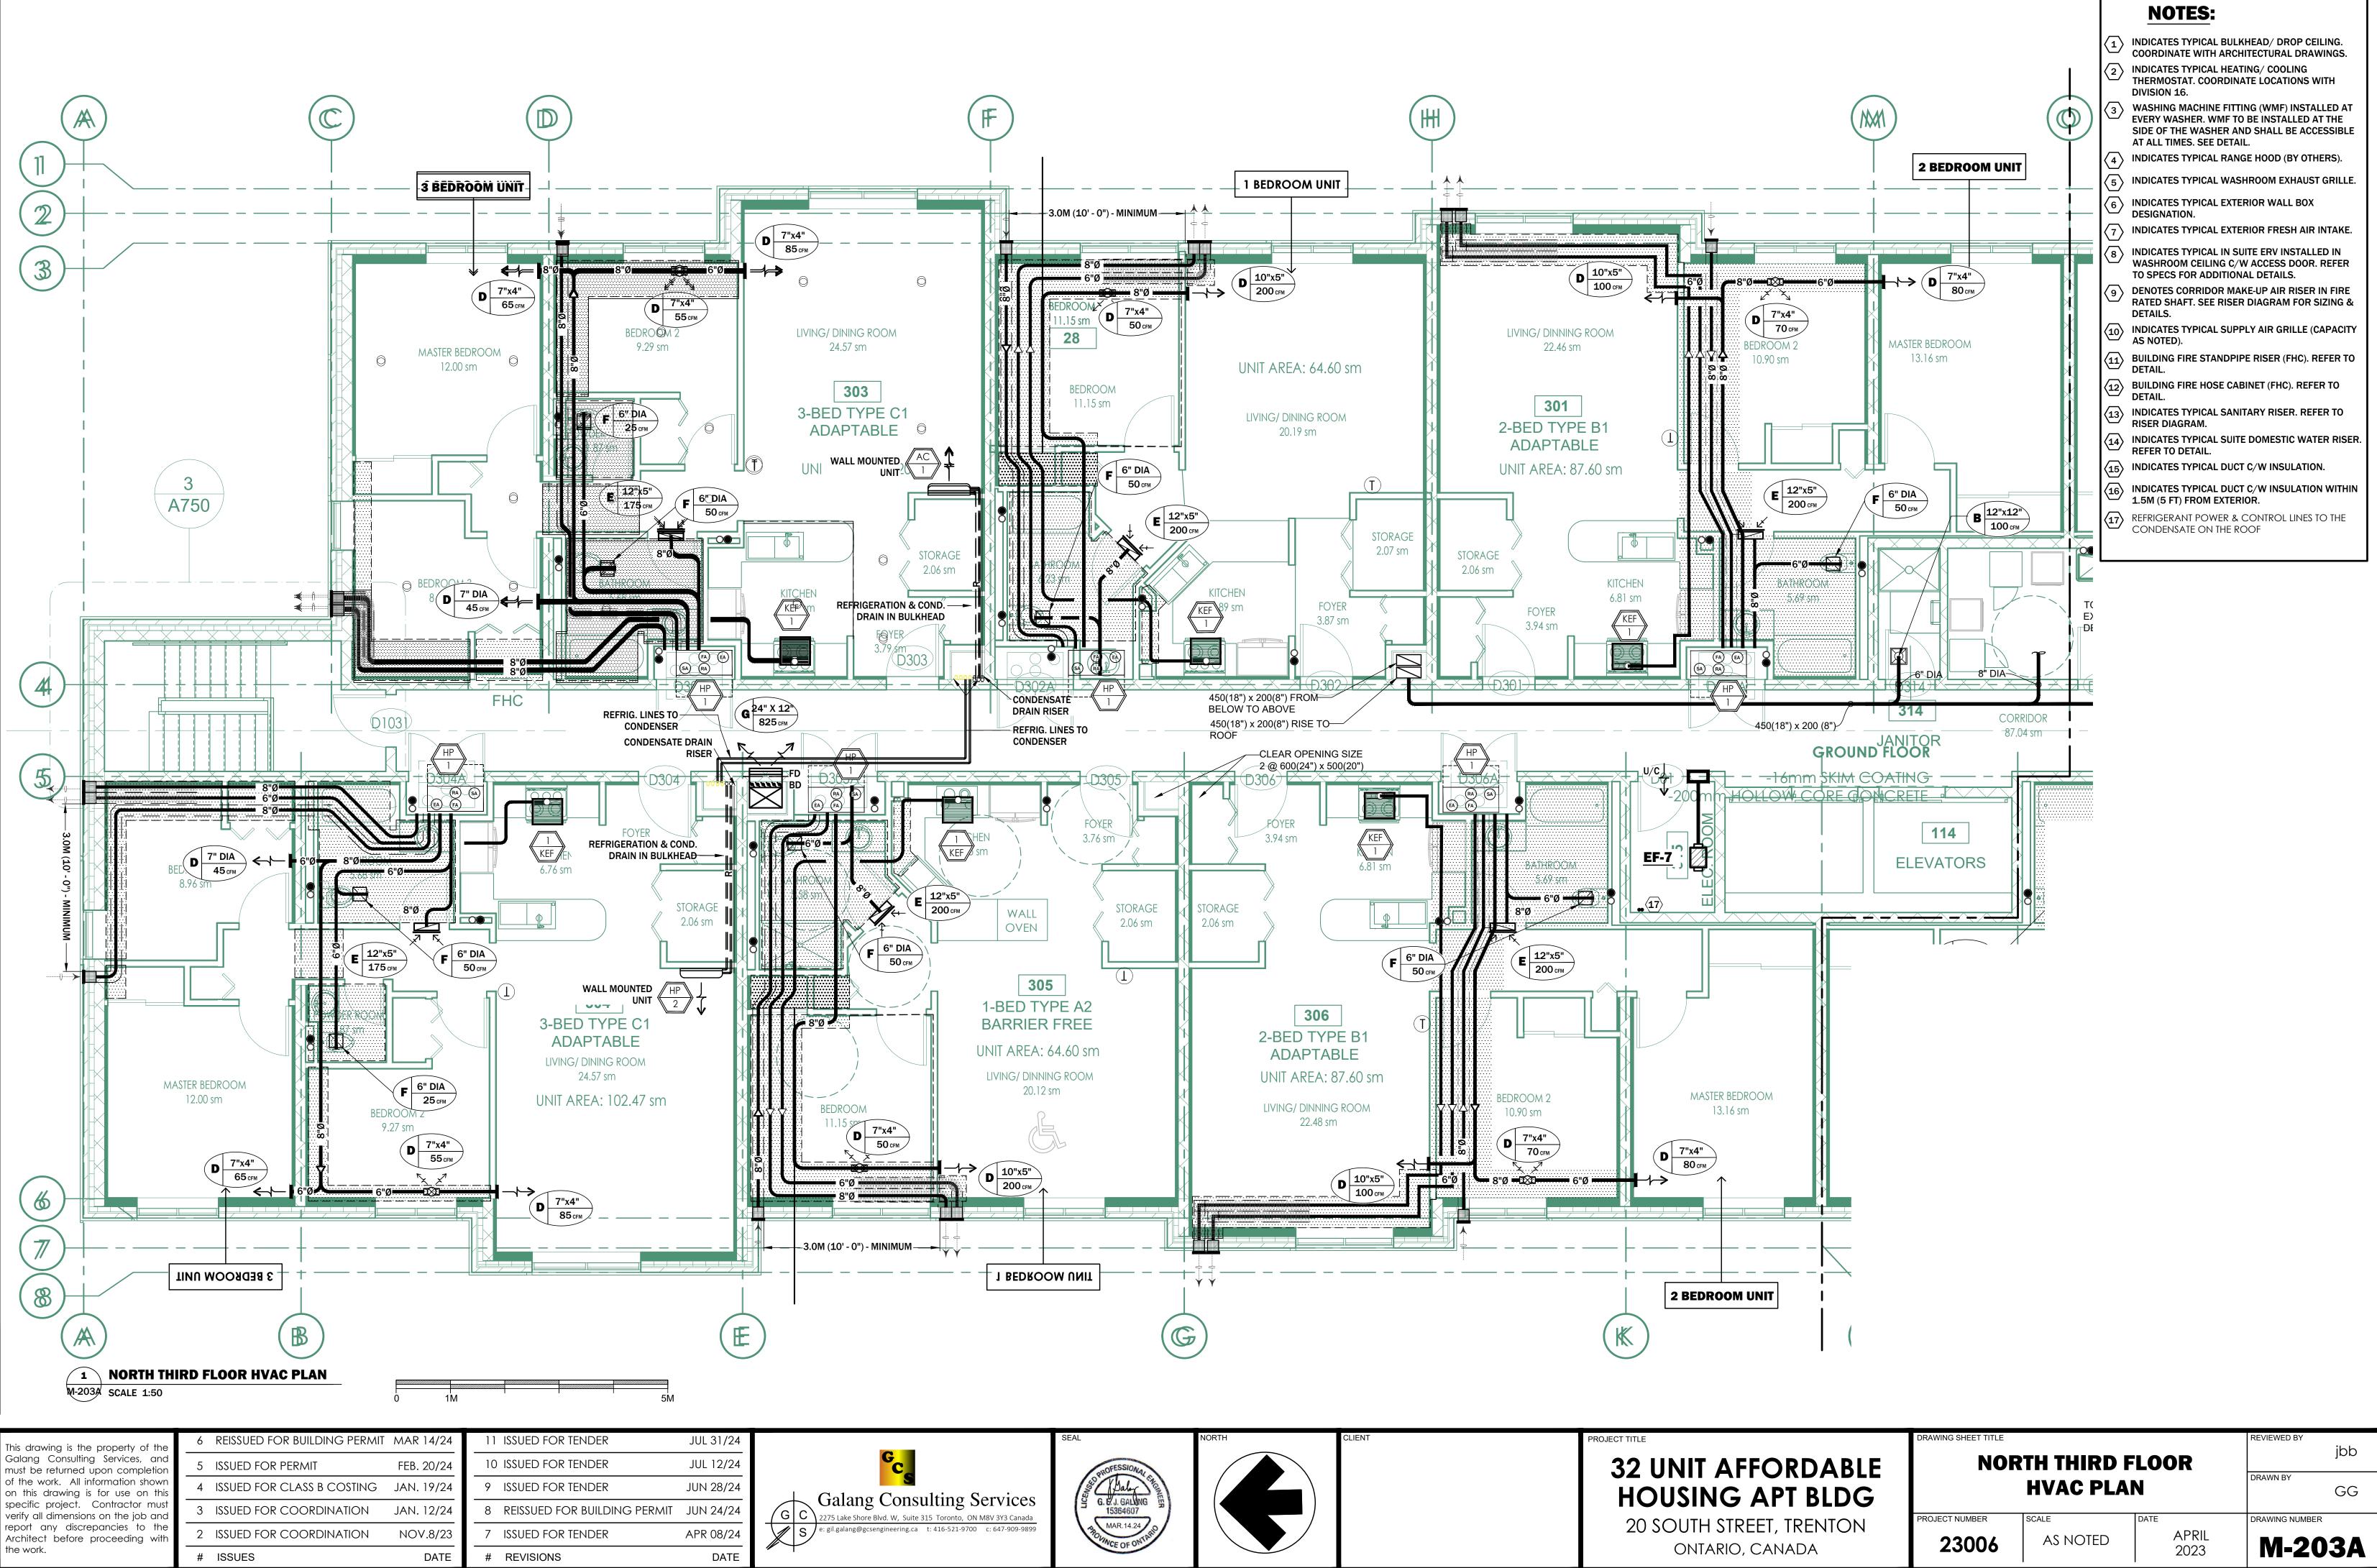
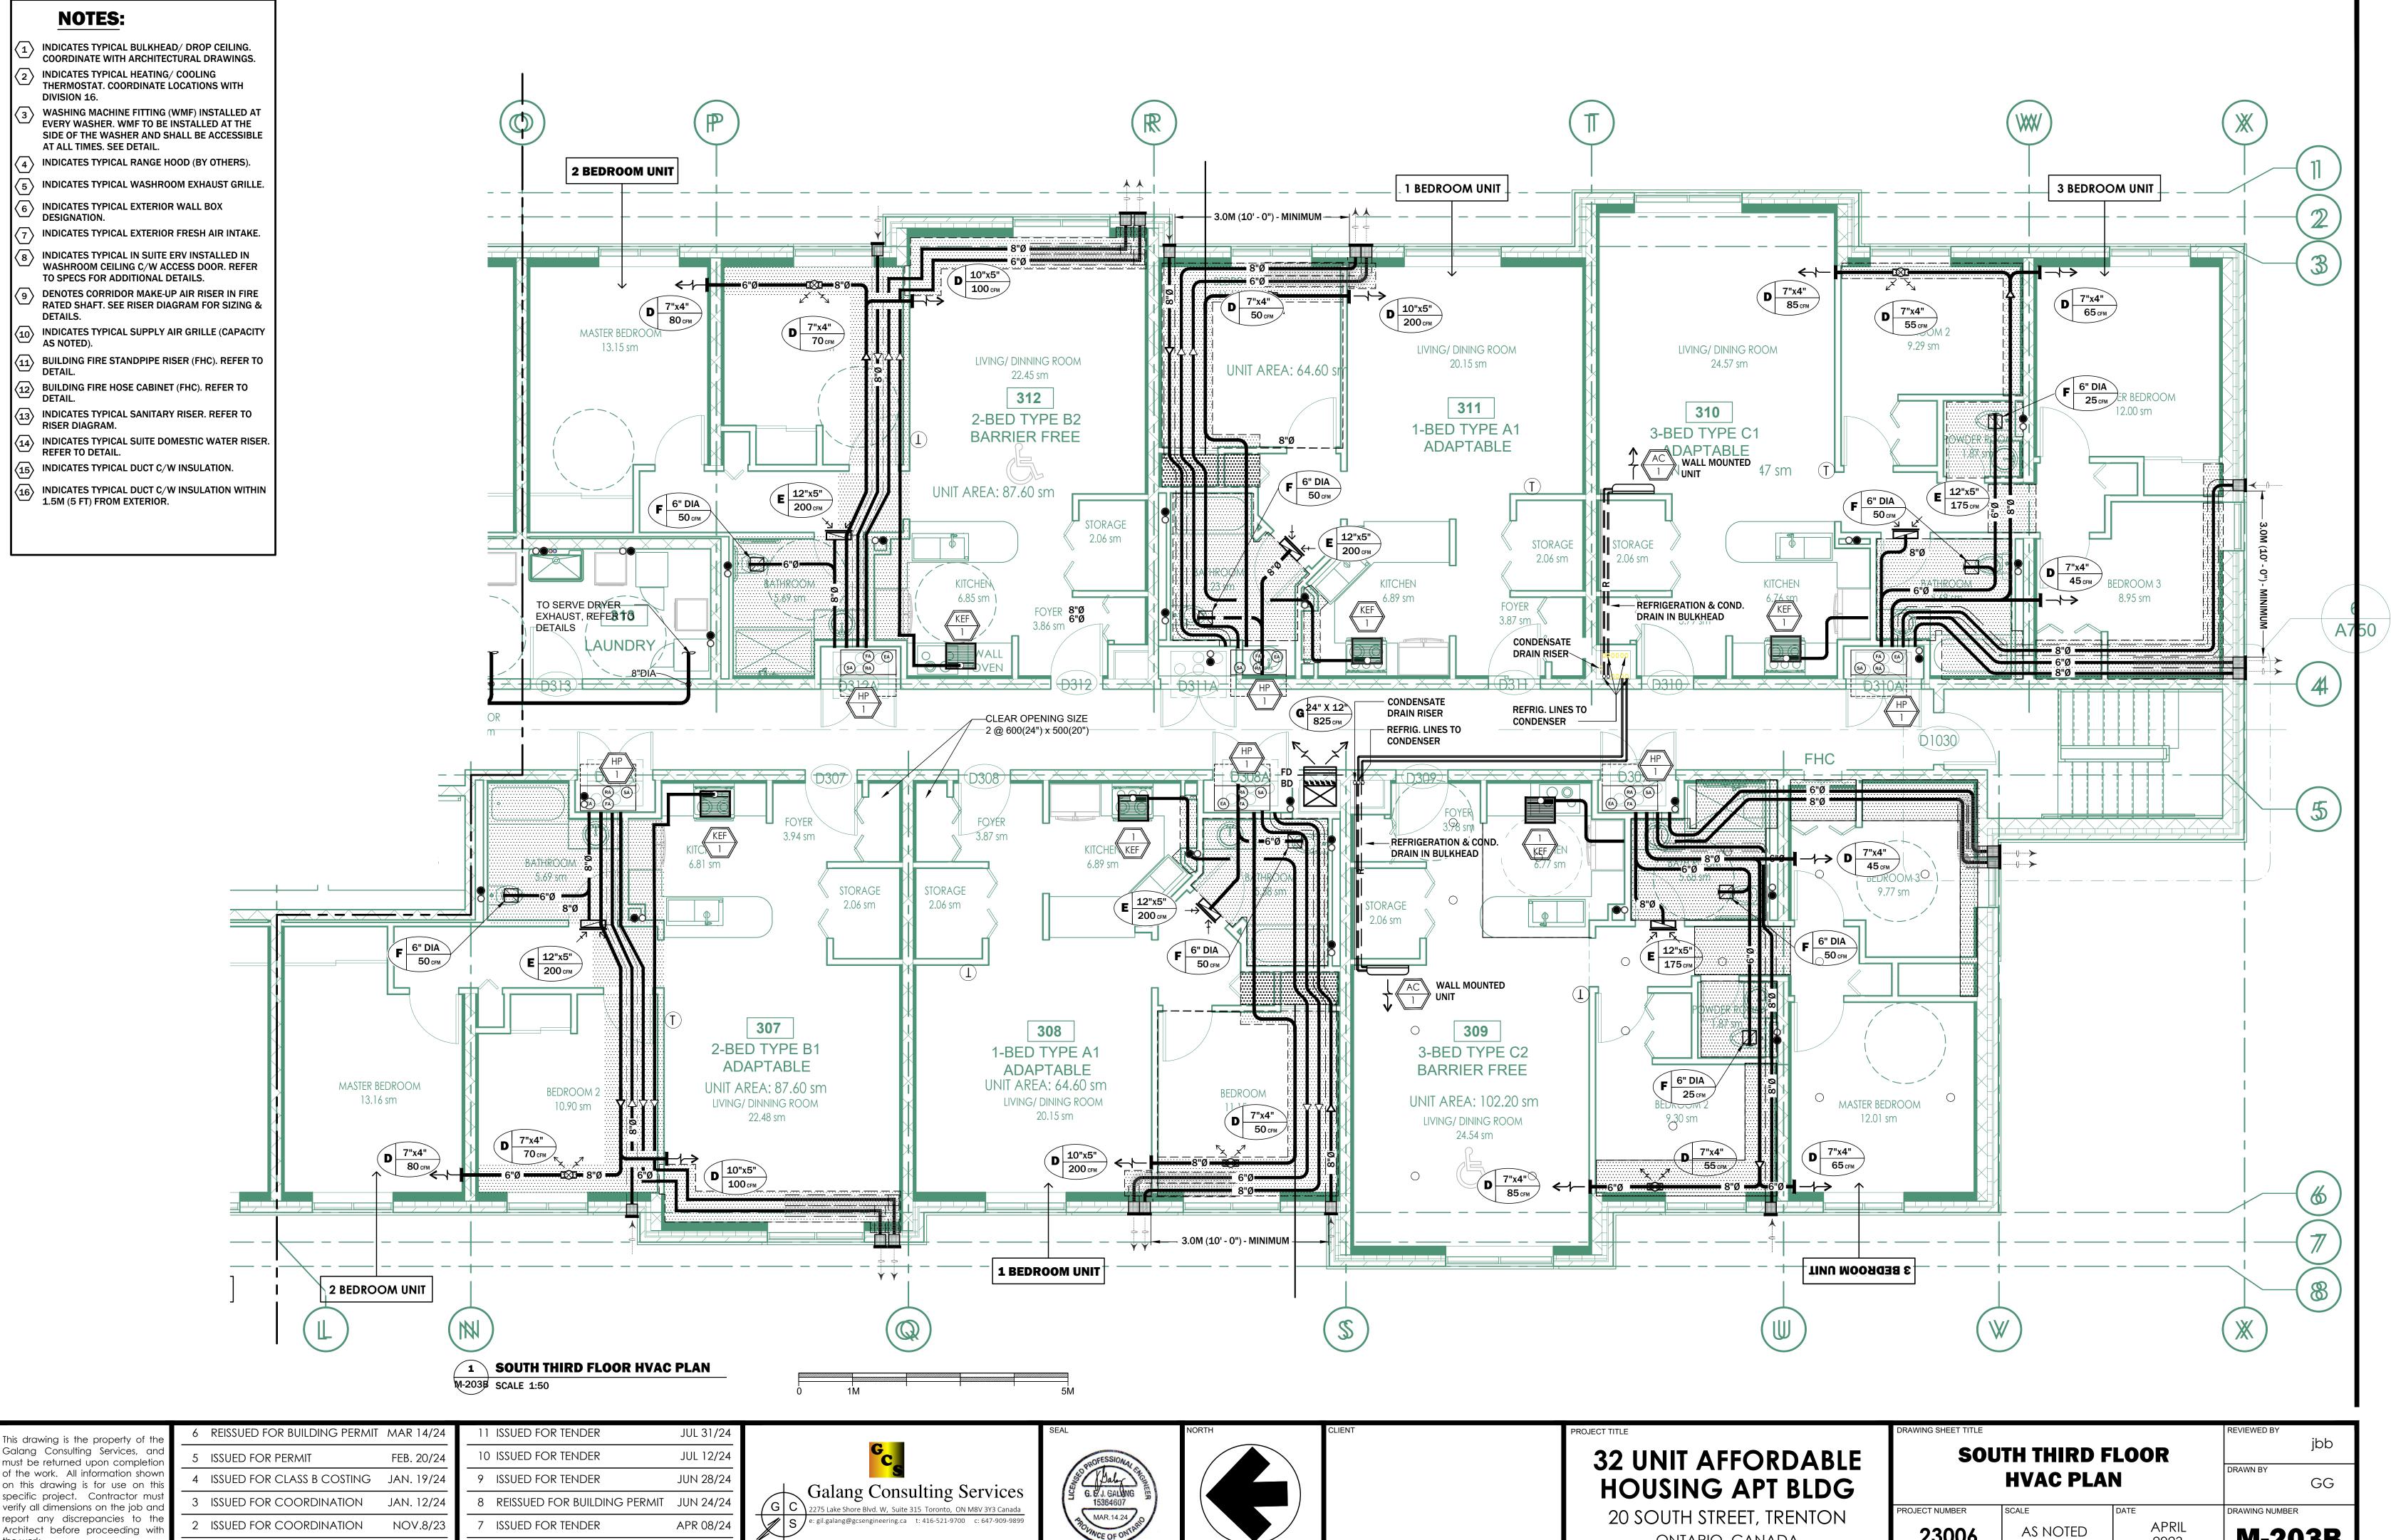
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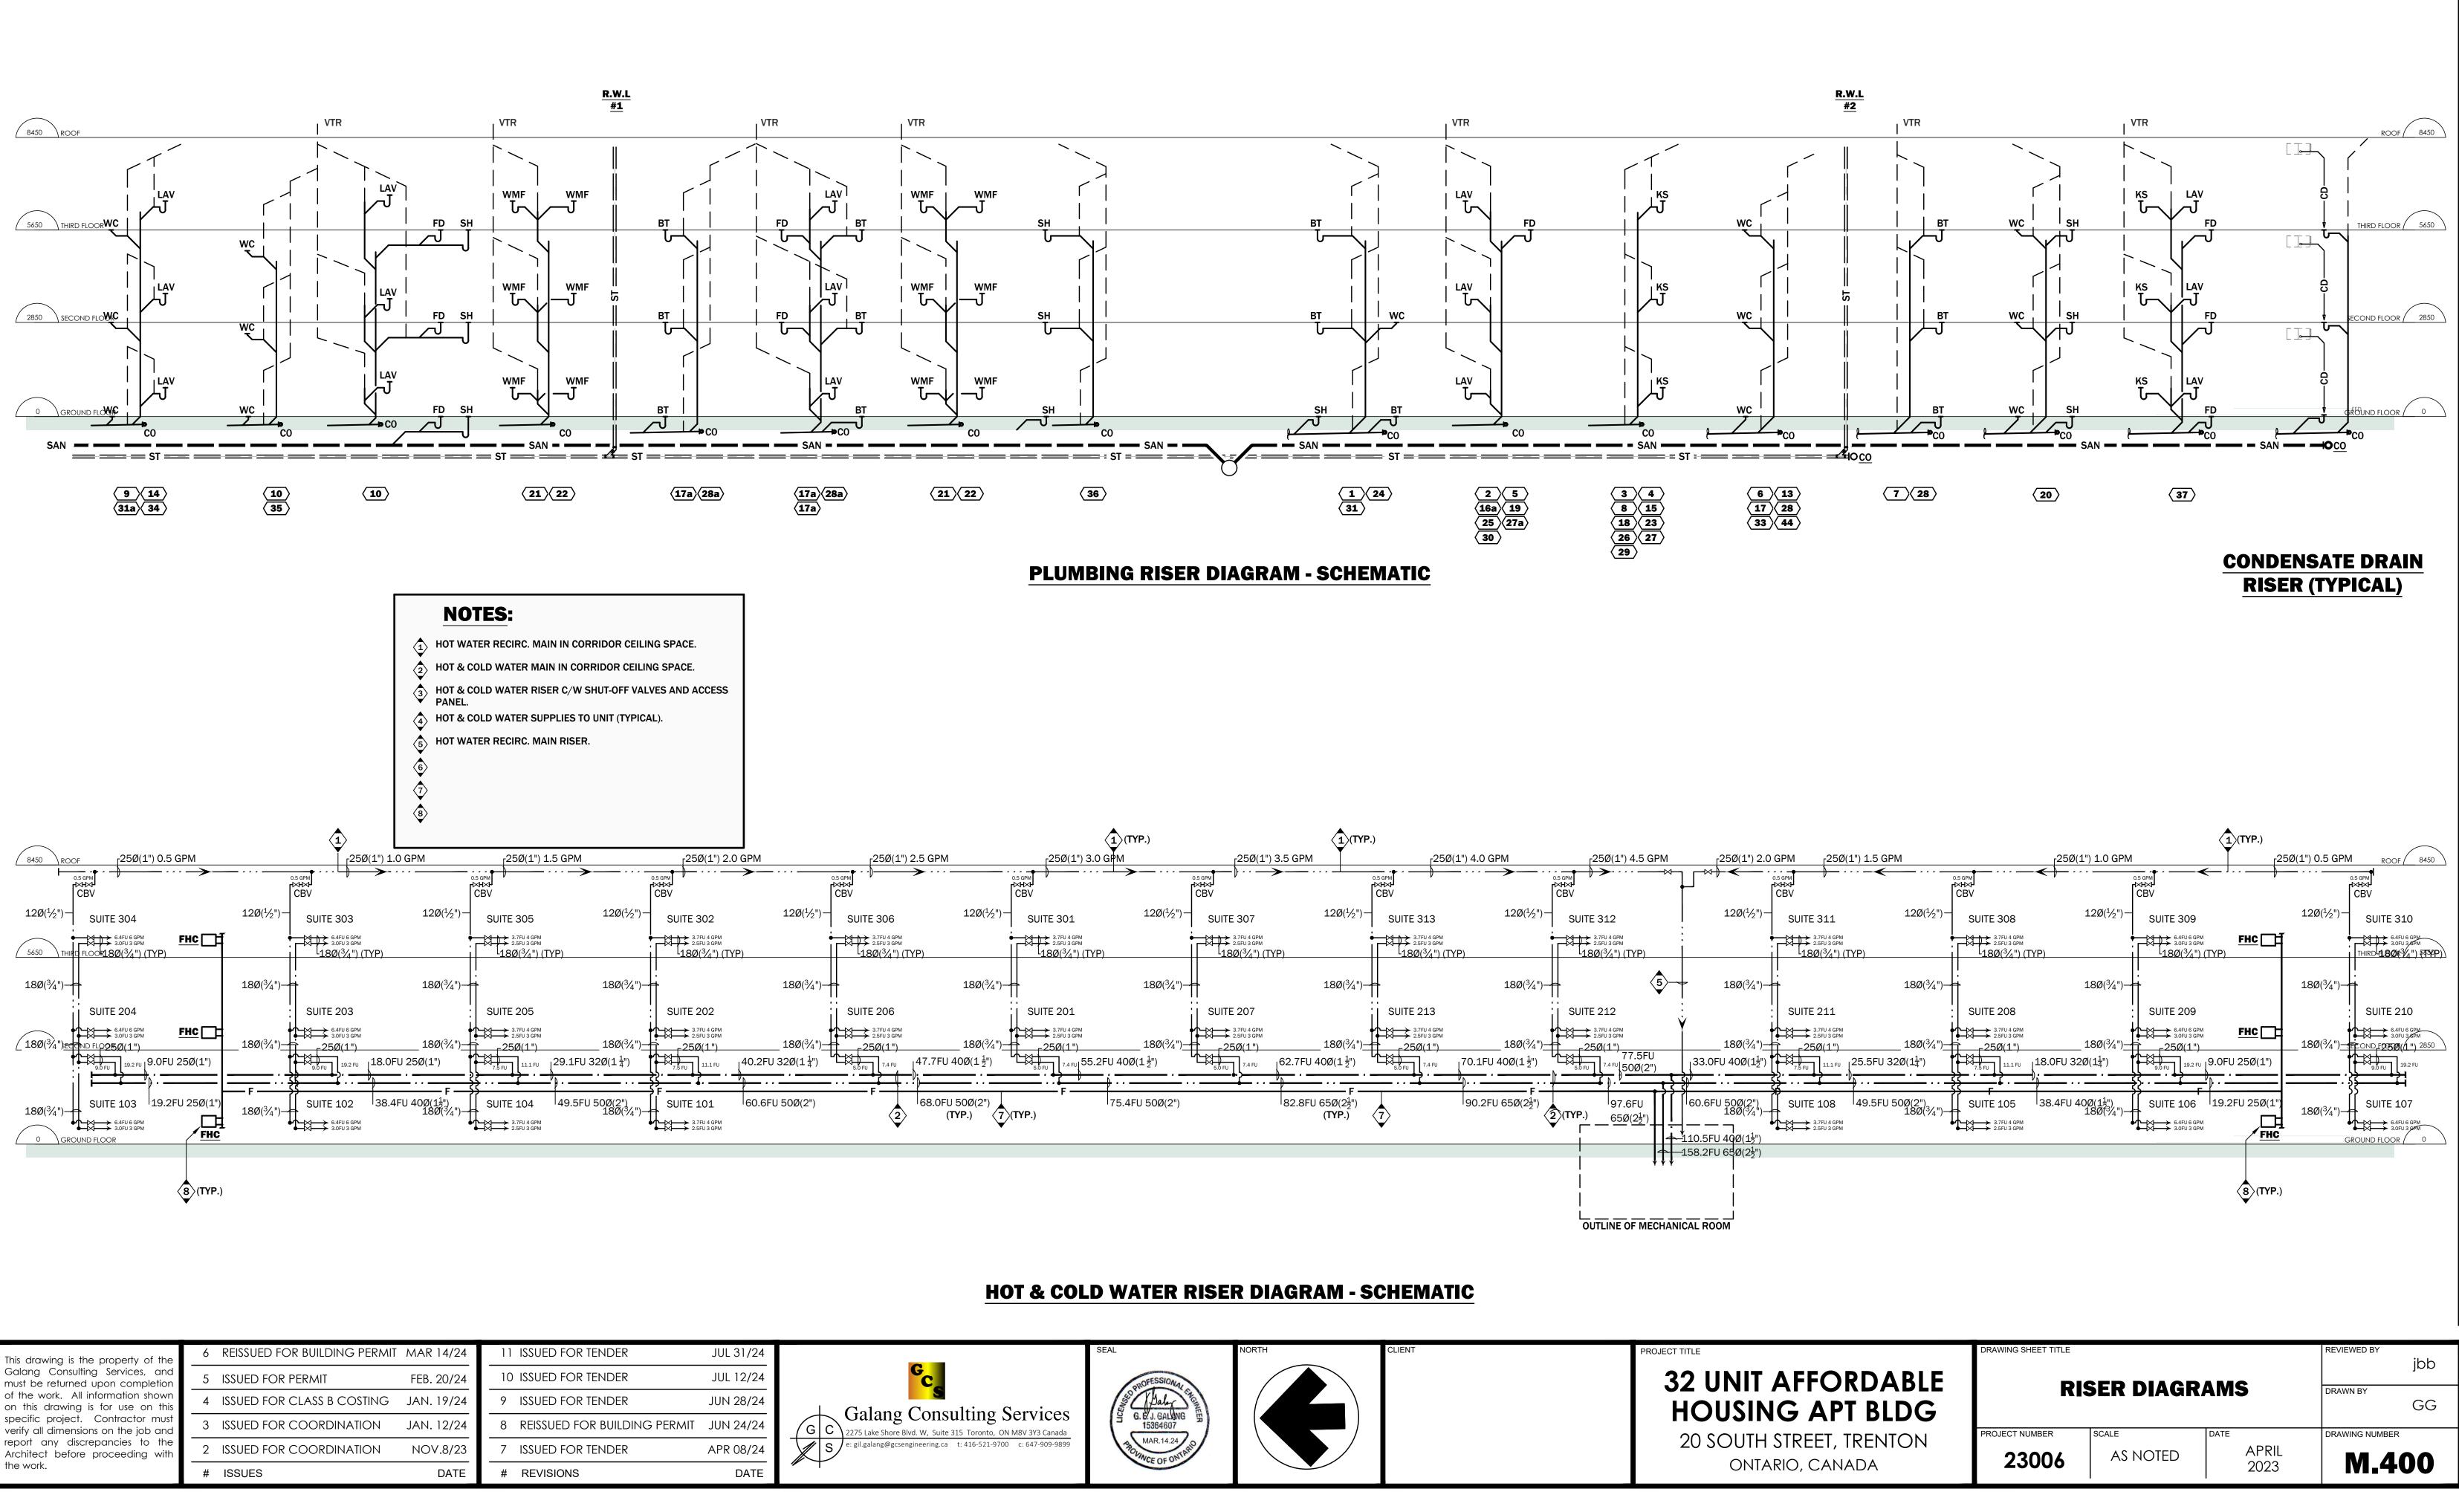


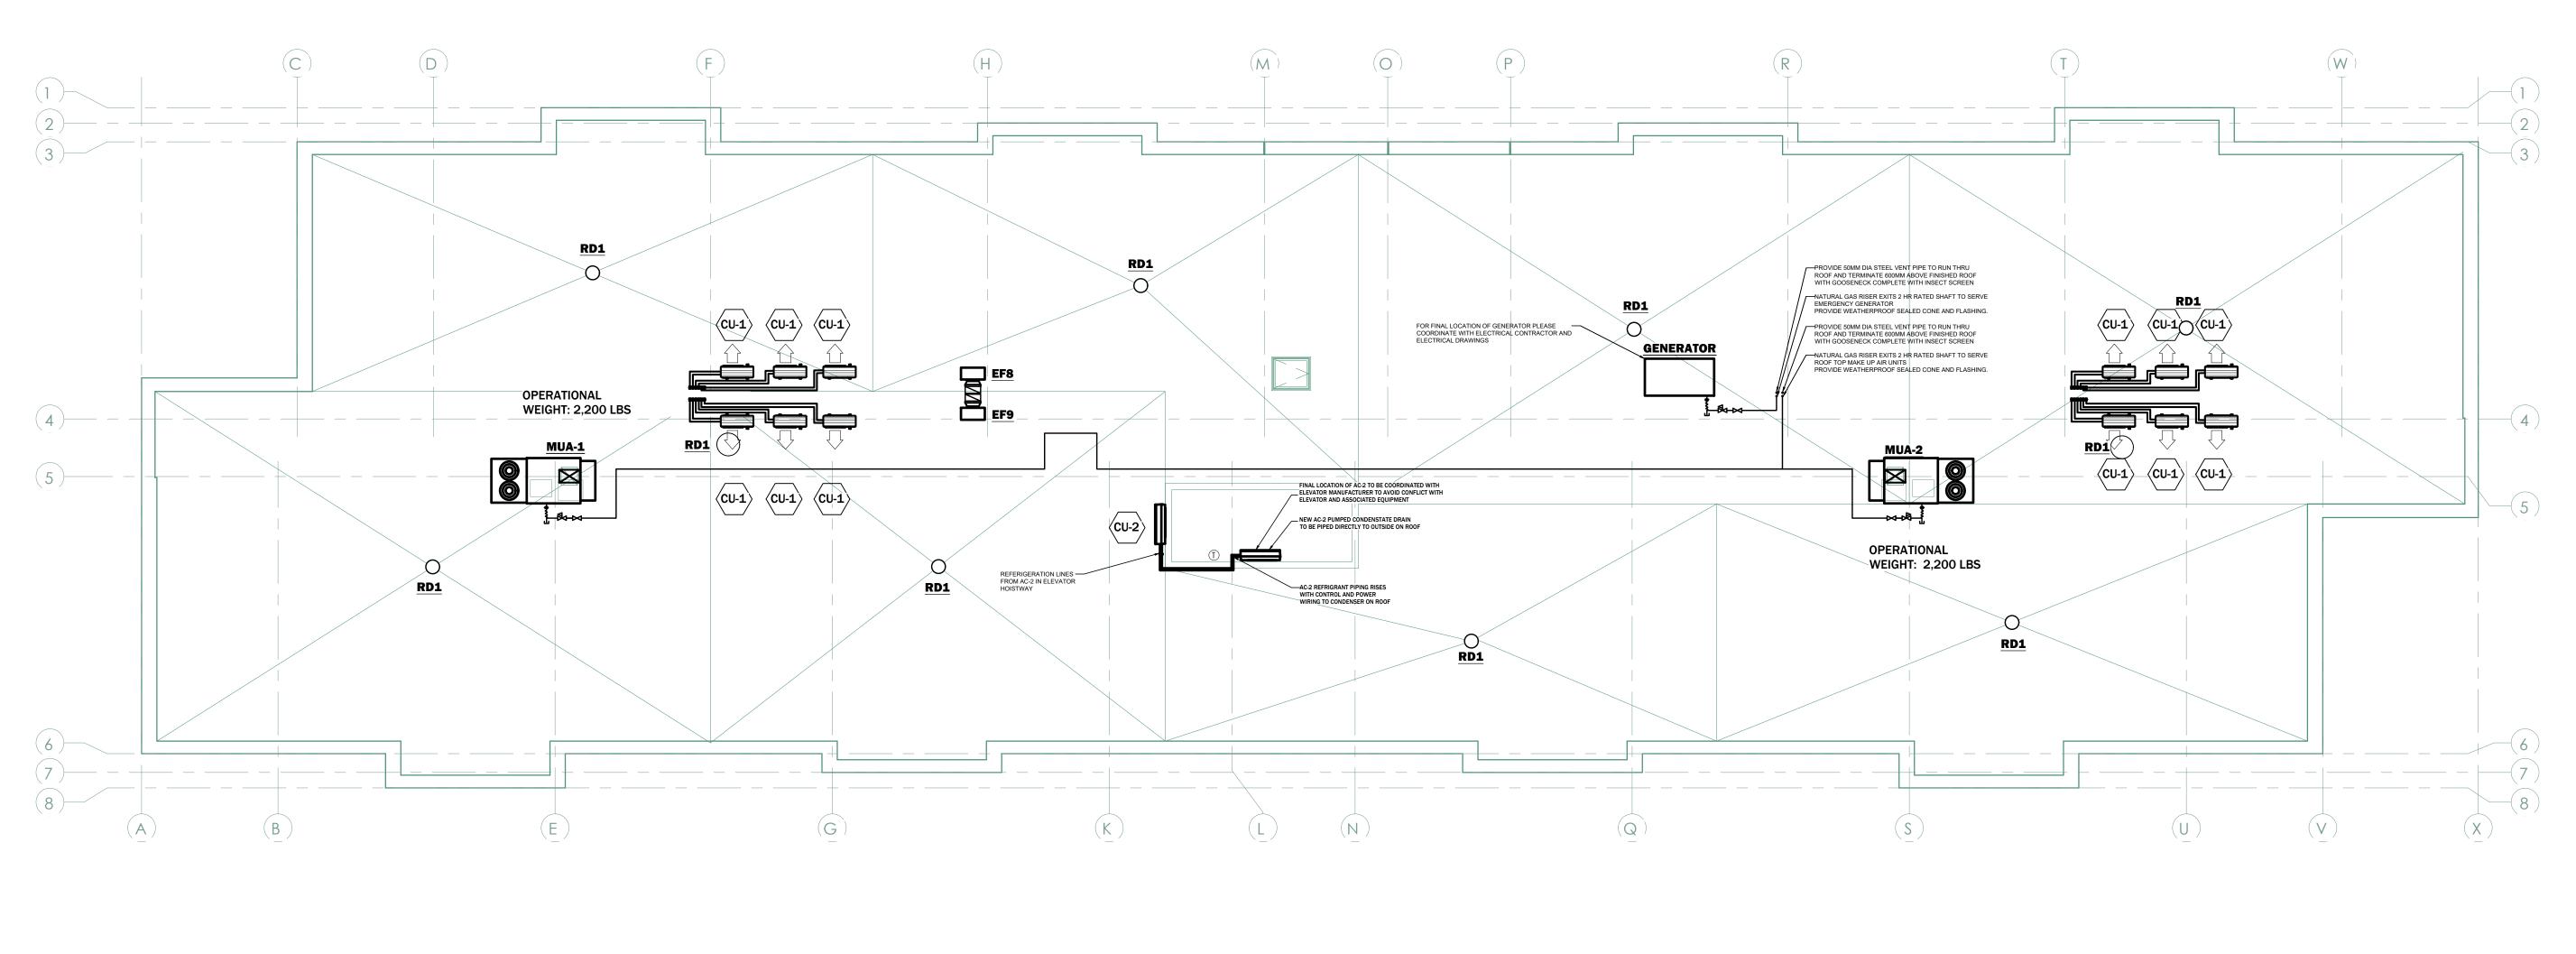
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PROJECT TITLE



JECT TITLE	DRAWING SHEET TITLE			REVIEWED BY	
32 UNIT AFFORDABLE		MECHANICA	AL.	jbb)
HOUSING APT BLDG		drawn by GG	;		
20 SOUTH STREET, TRENTON	PROJECT NUMBER	SCALE	DATE	DRAWING NUMBER	
ONTARIO, CANADA	23006	AS NOTED	APRIL 2023	M-300	



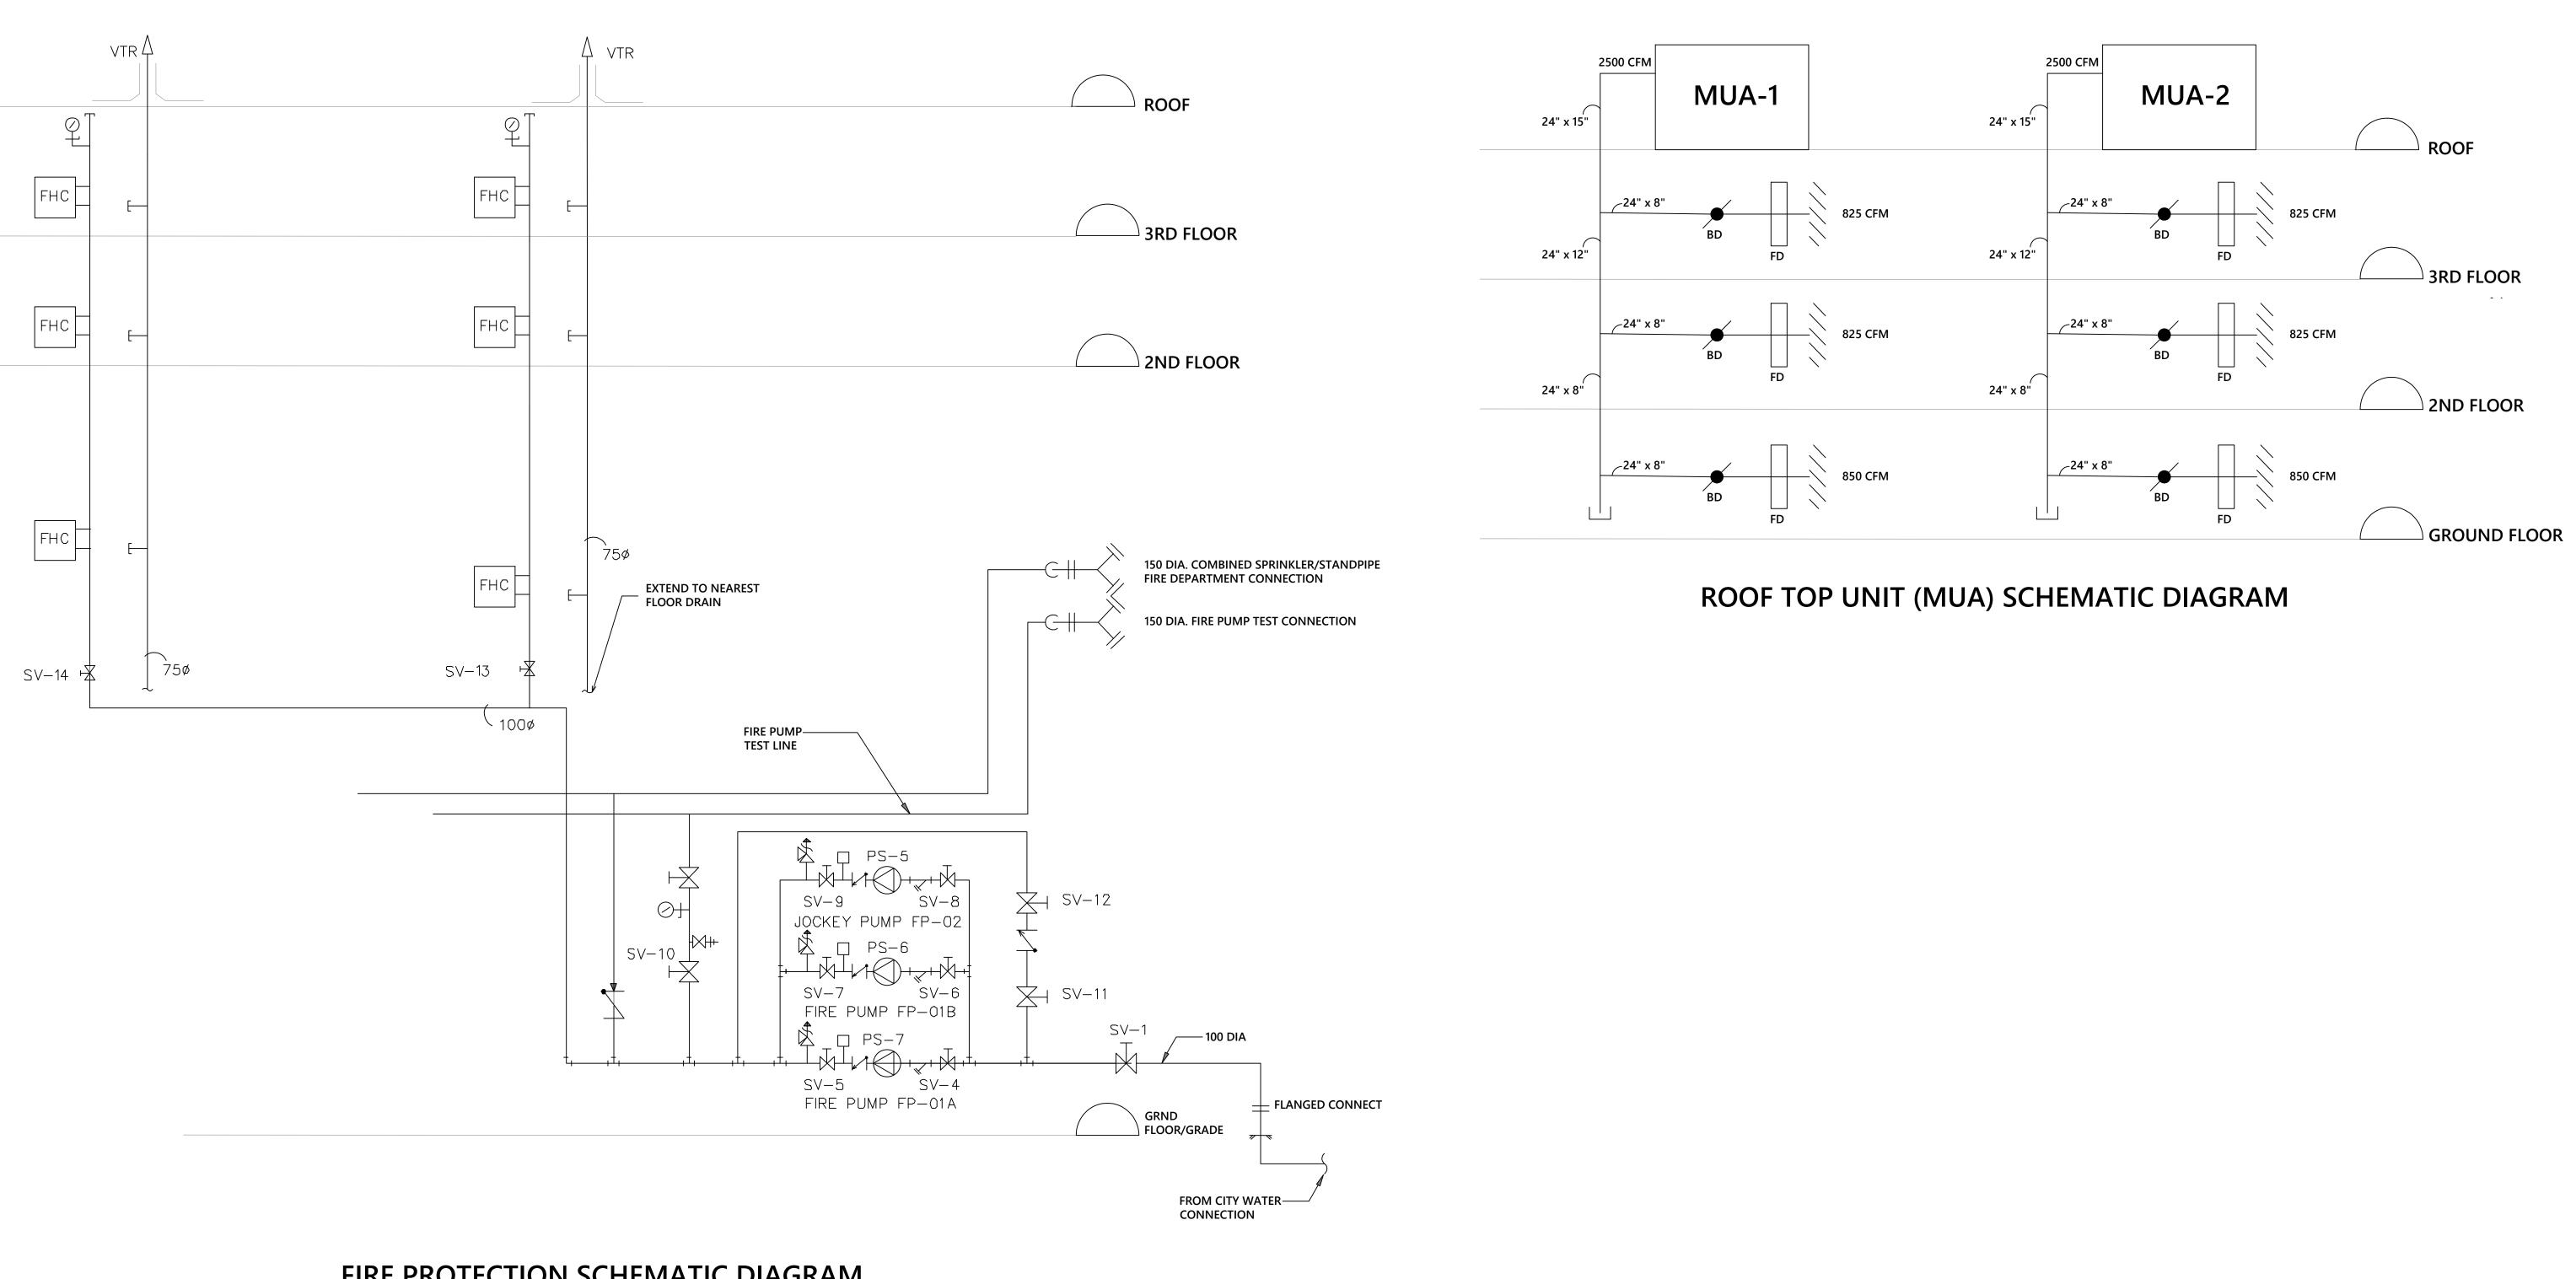

FIRE PROTECTION SCHEMATIC DIAGRAM

the work.	#	RESSURED FOR BUILDING PERMIT	MAR D4X1212	# REVISIONS DATE
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specific project. Contractor must verify all dimensions on the job and	3	REISSUED FOR BUILDING PERMIT	JUN 24/24	
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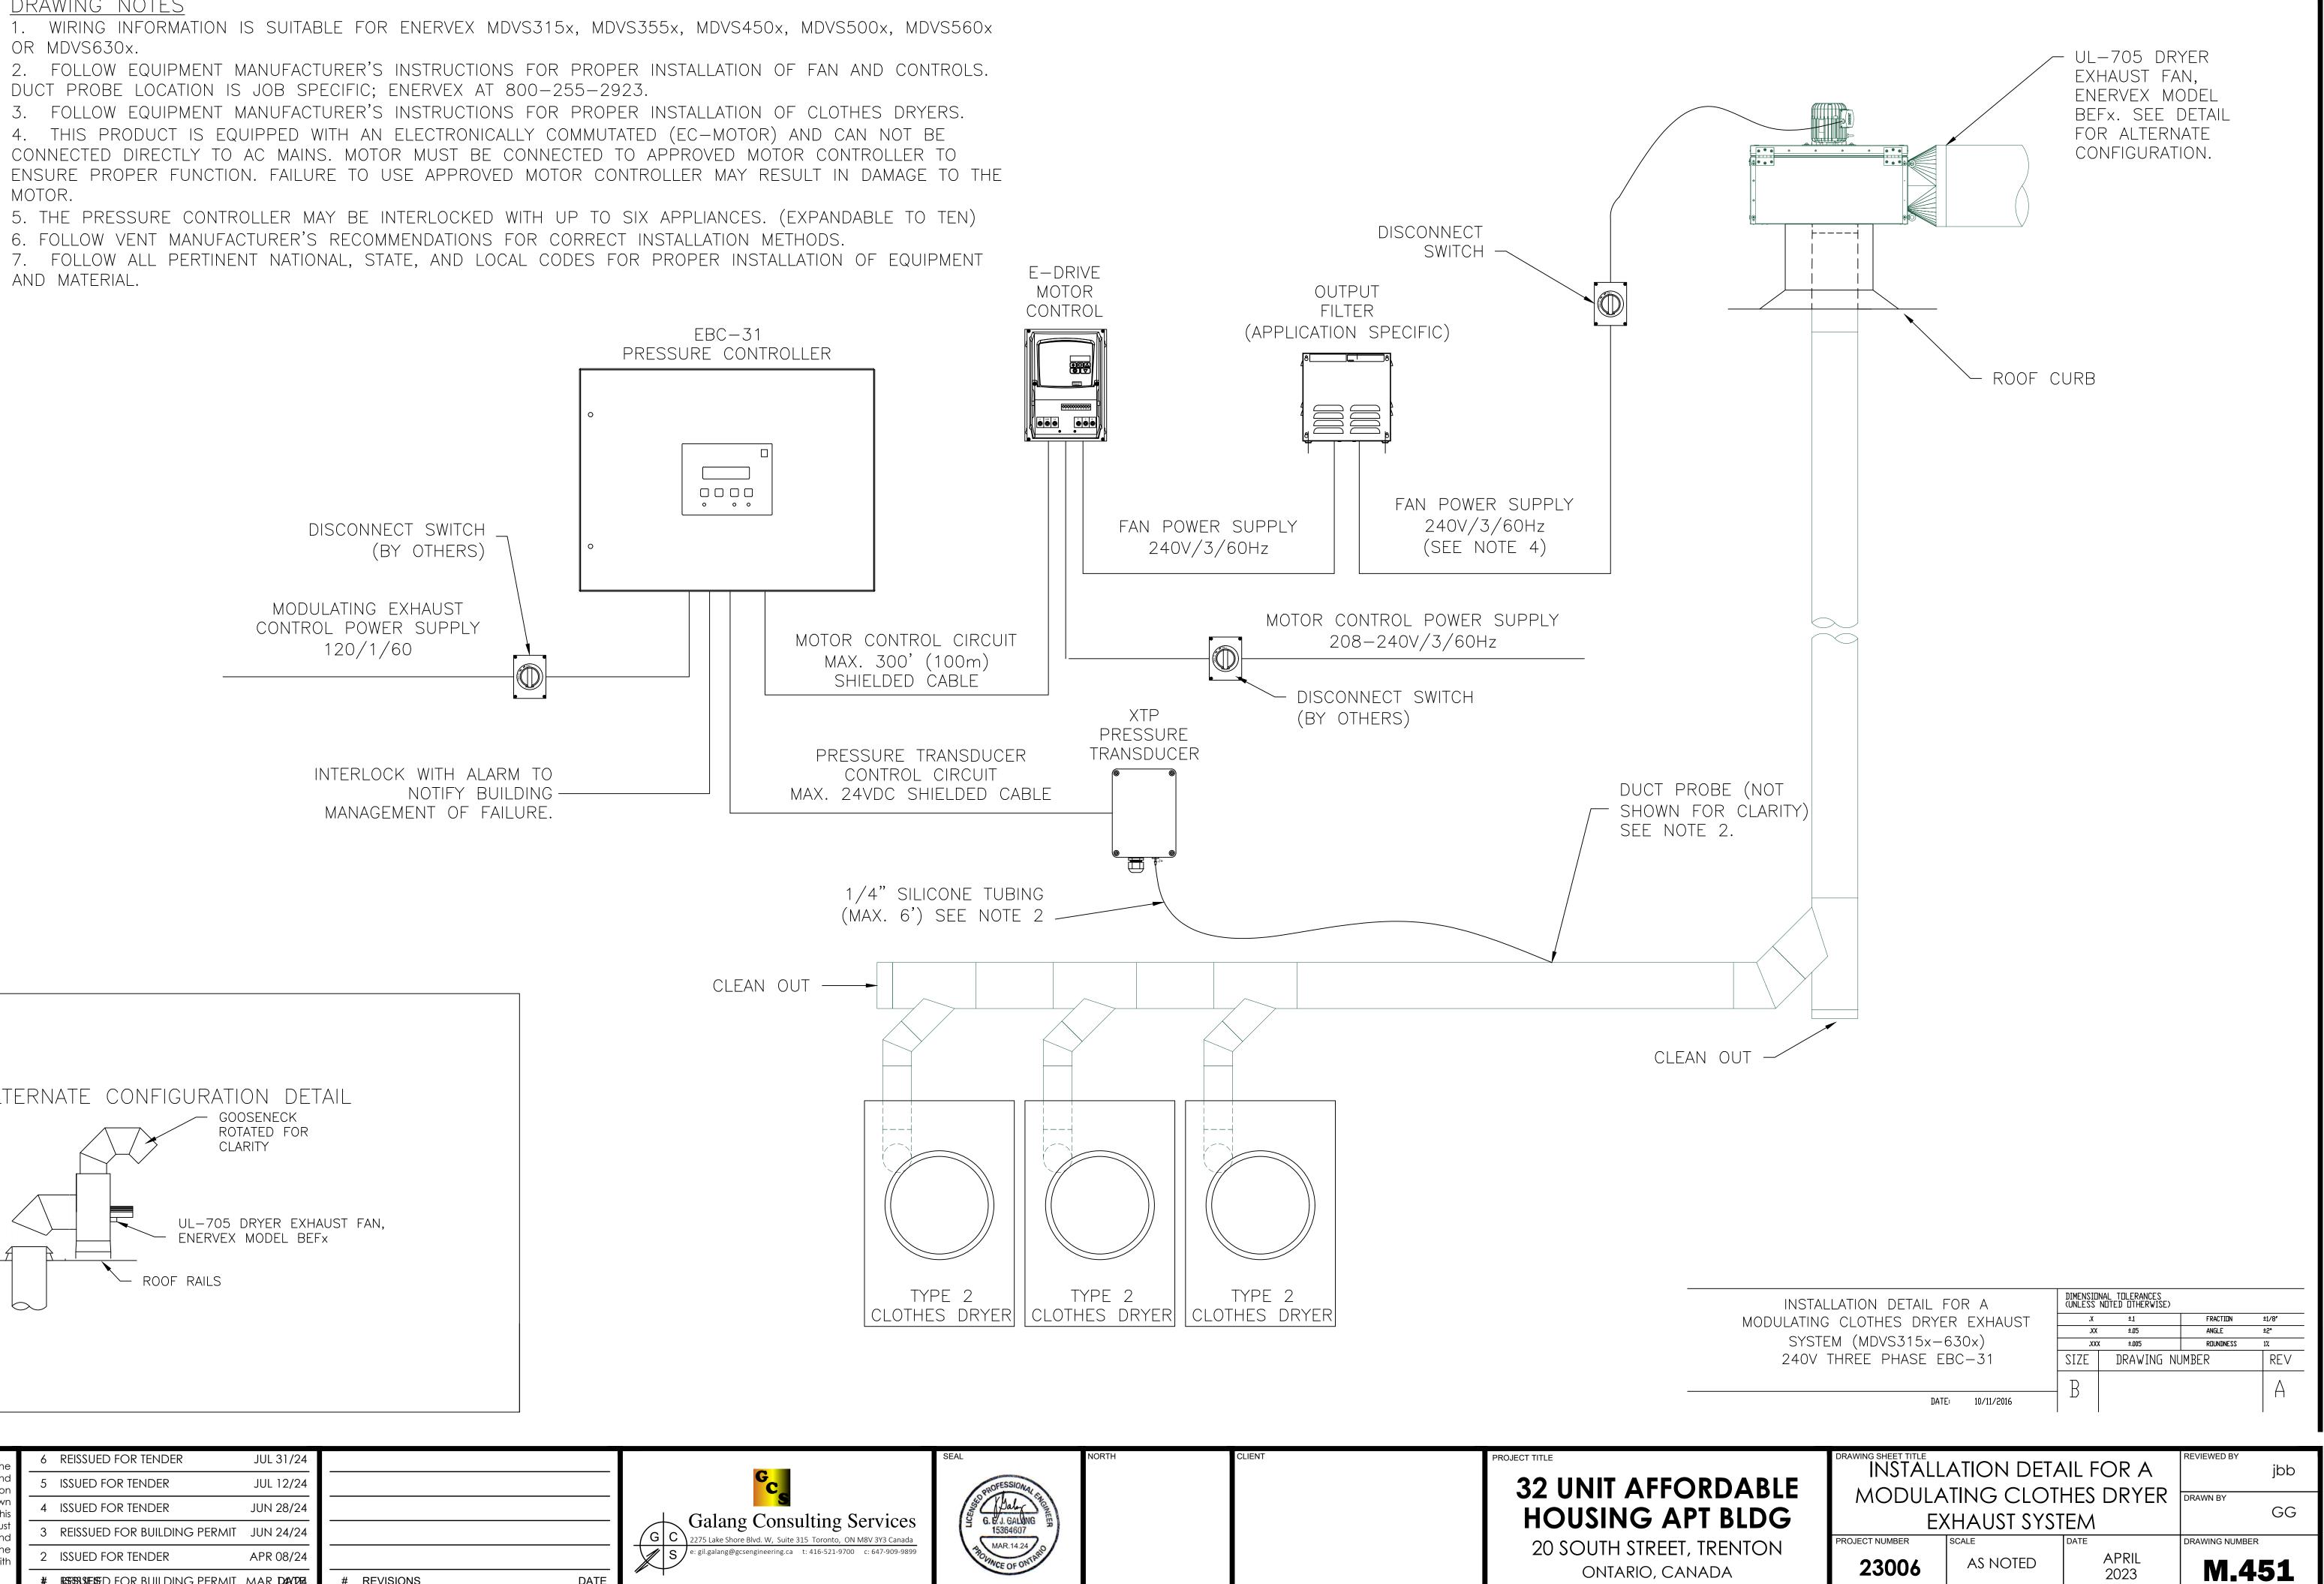
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SING APT BLDG		GG		
UTH STREET, TRENTON ONTARIO, CANADA	PROJECT NUMBER	AS NOTED	APRIL 2023	DRAWING NUMBER

DRAWING NOTES

OR MDVS630x.

DUCT PROBE LOCATION IS JOB SPECIFIC; ENERVEX AT 800-255-2923. MOTOR.


6. FOLLOW VENT MANUFACTURER'S RECOMMENDATIONS FOR CORRECT INSTALLATION METHODS. AND MATERIAL.




ALTERNATE CONFIGURATION DETAIL GOOSENECK ROTATED FOR CLARITY
UL-705 DRYER EXHAUST FAN, ENERVEX MODEL BEFx ROOF RAILS

This drawing is the property of the	6	REISSUED FOR TENDER	JUL 31/24		
Galang Consulting Services, and must be returned upon completion	5	ISSUED FOR TENDER	JUL 12/24		
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NORTH

SEAL

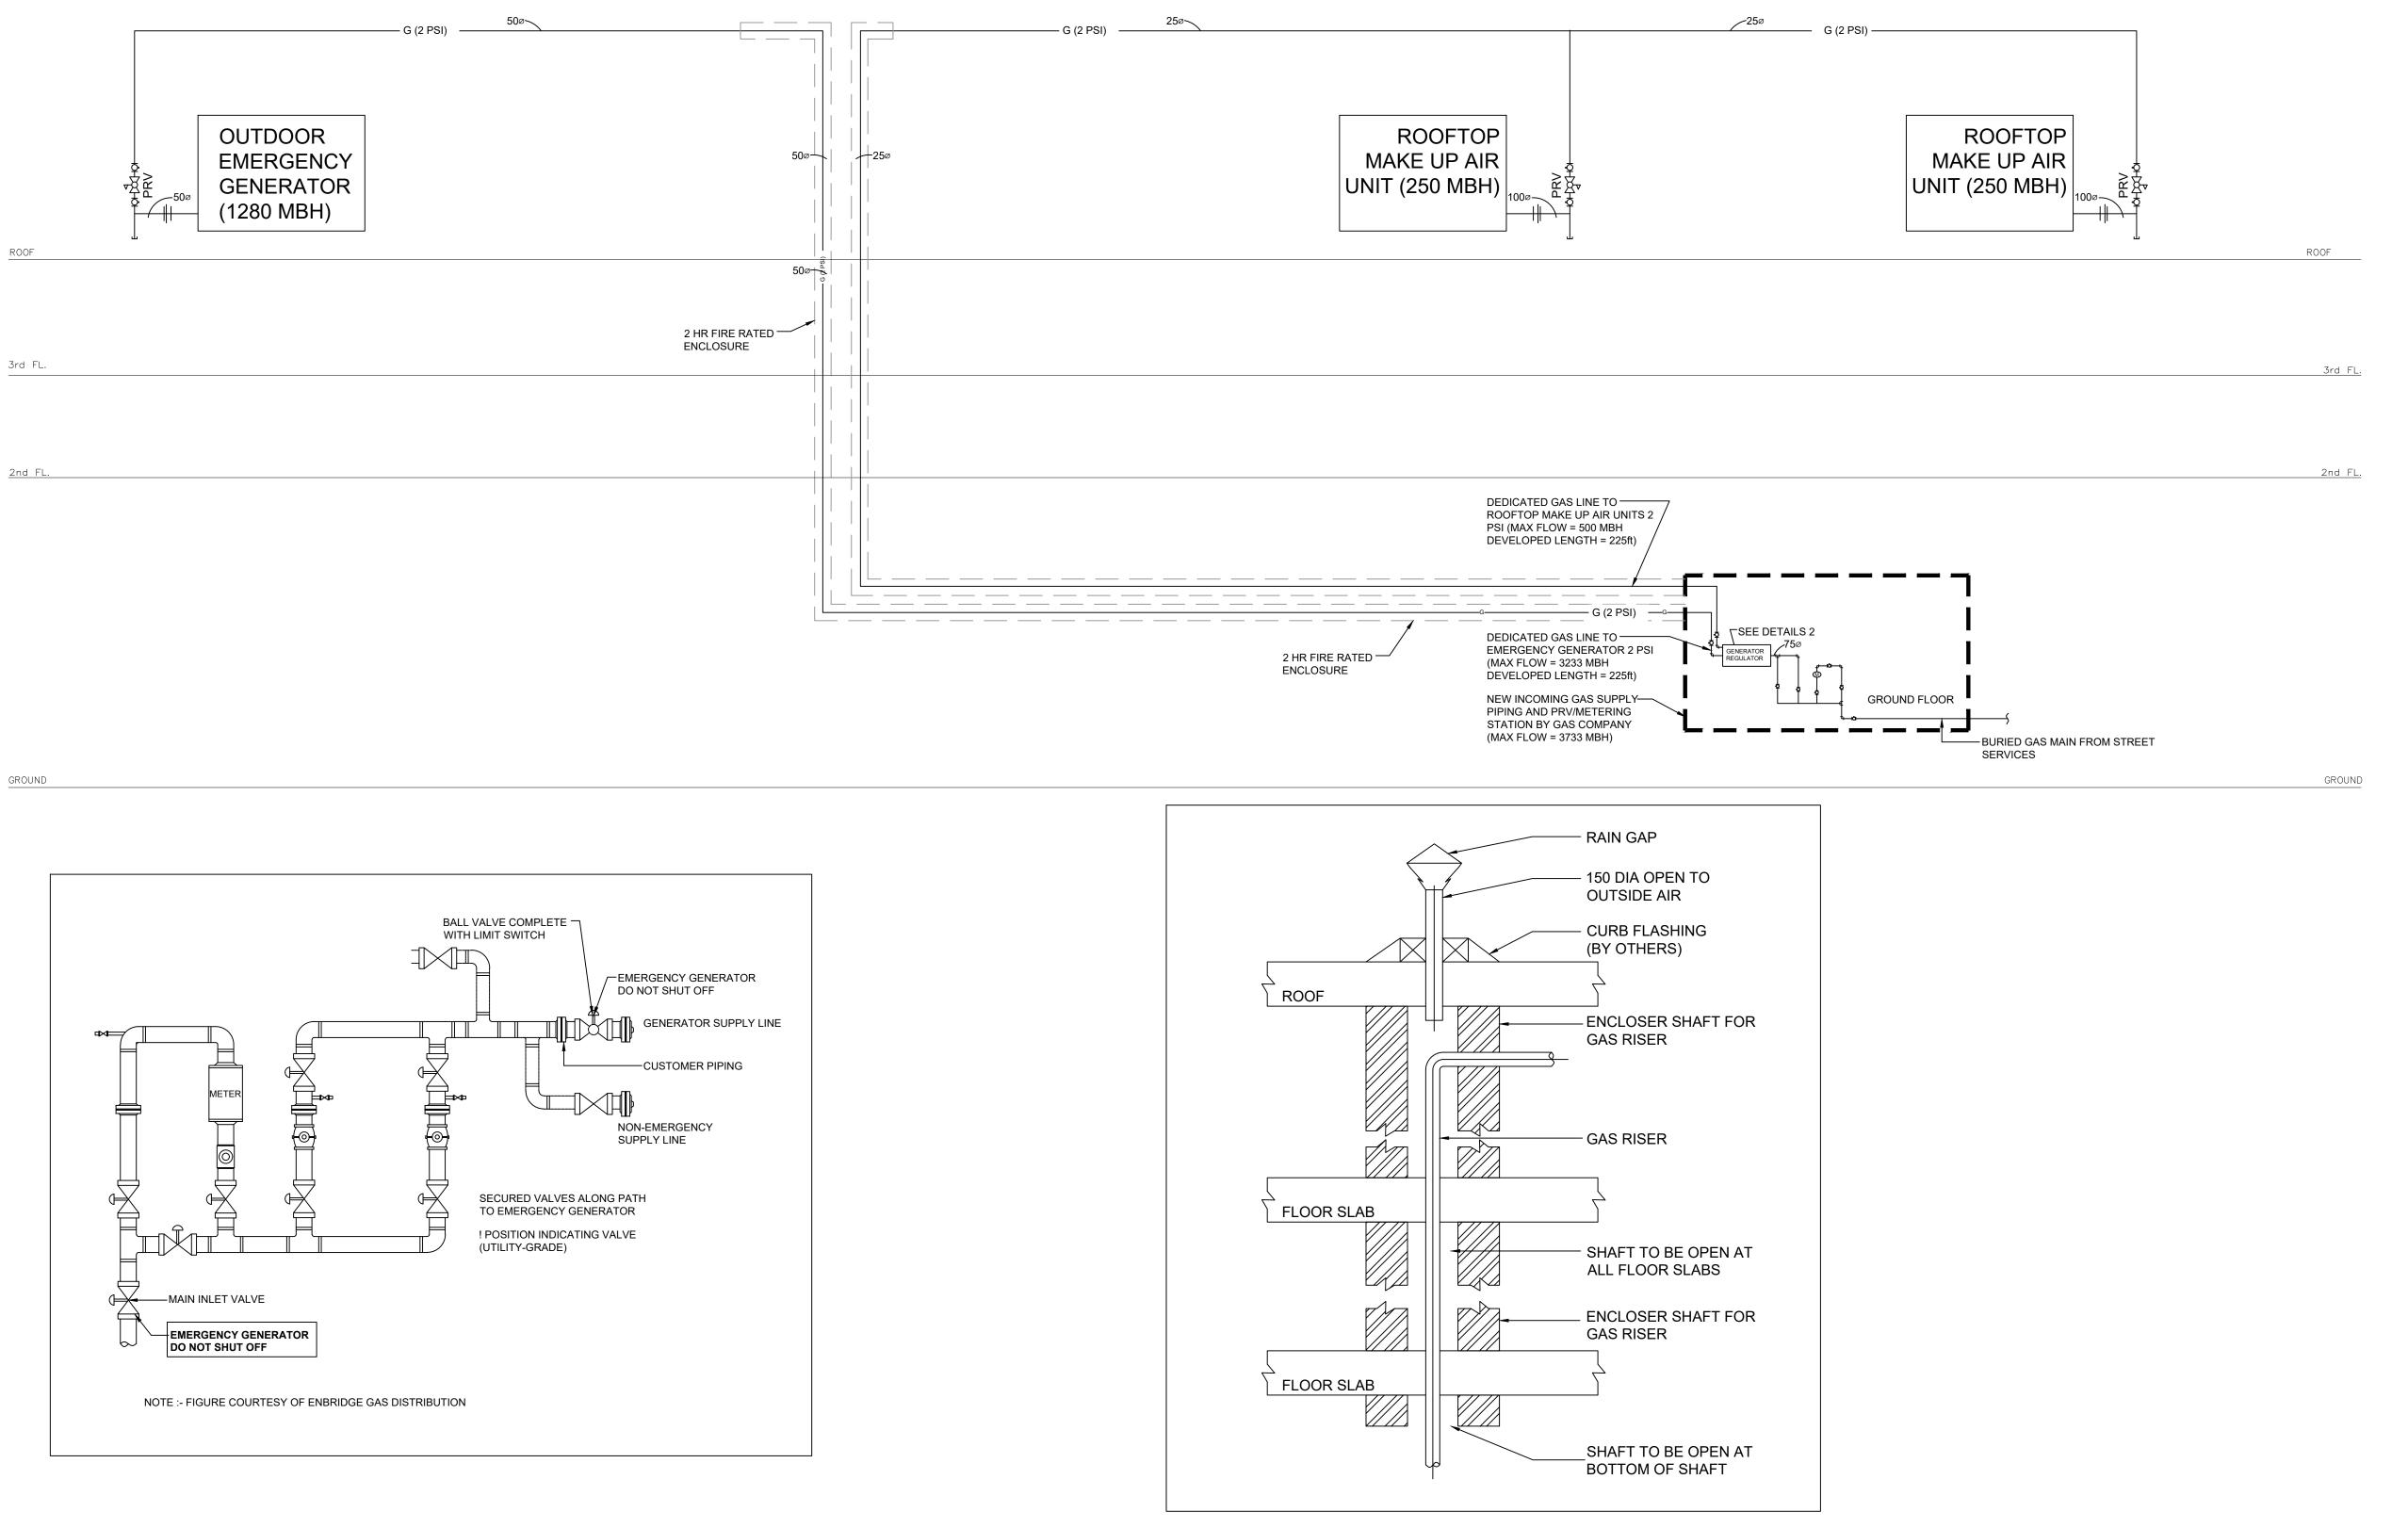G. E. J. GALONG 15364607

MAR.14.24
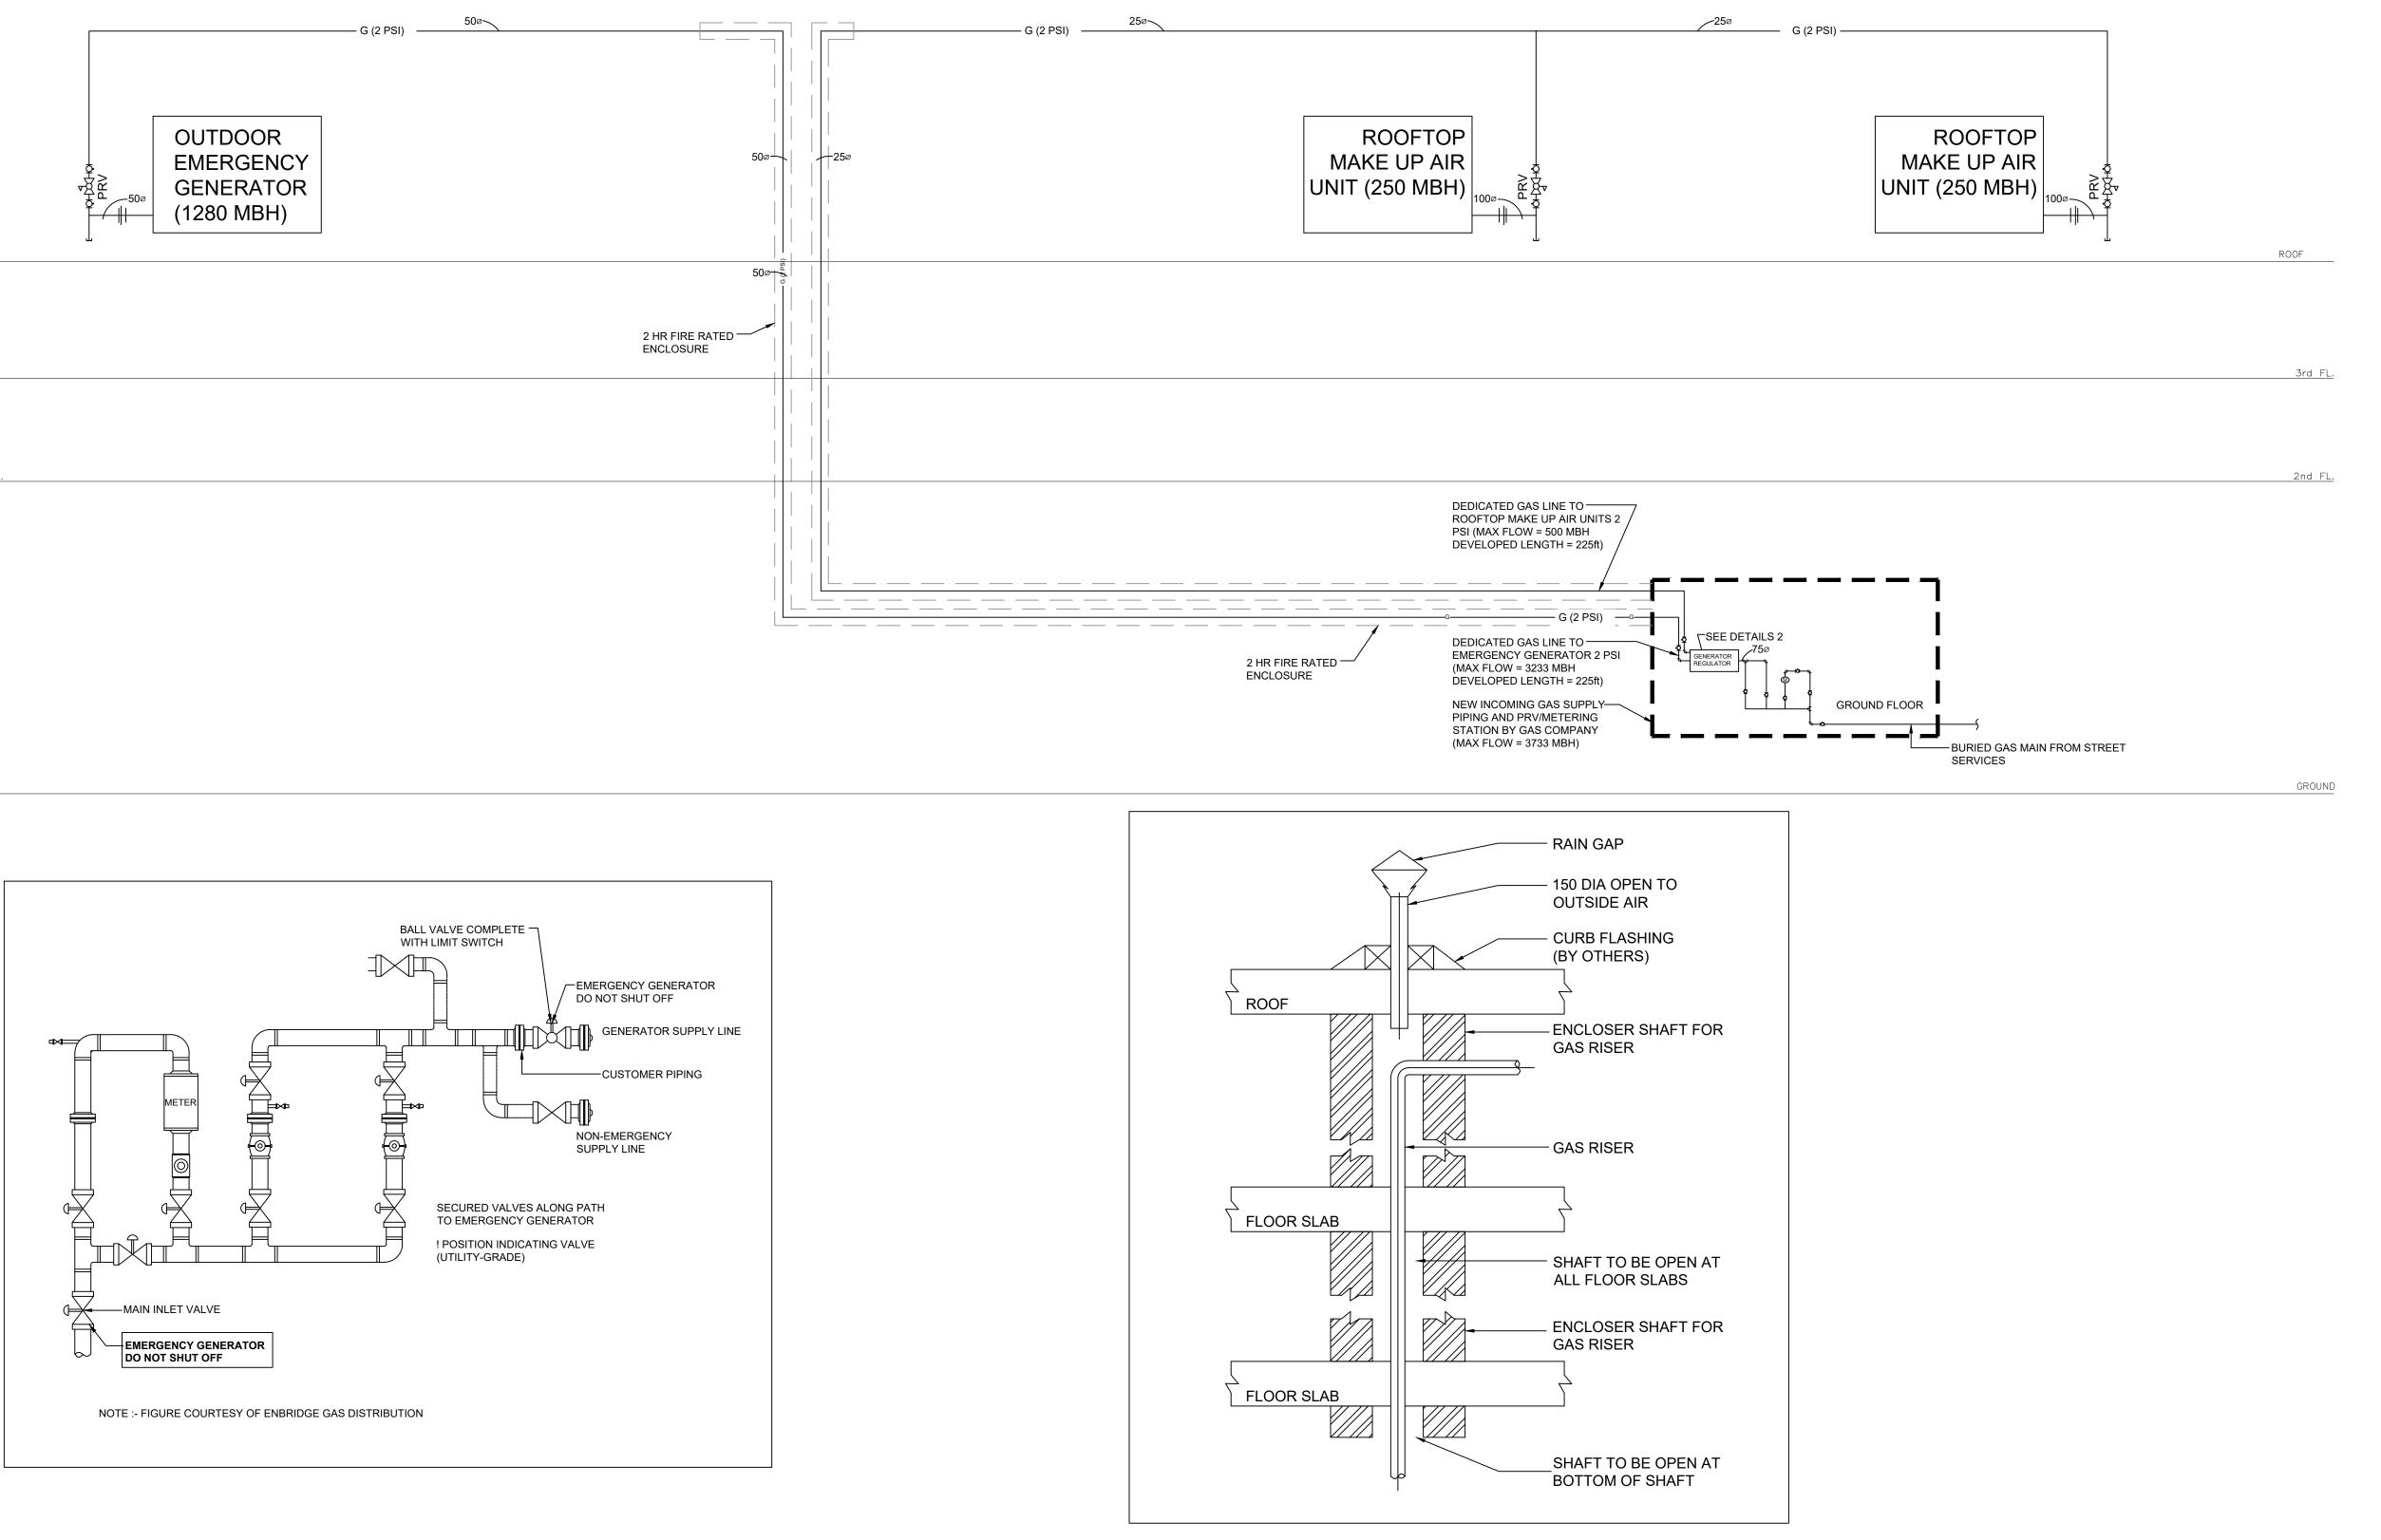
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6	REISSUED FOR TENDER	JUL 31/24
5	ISSUED FOR TENDER	JUL 12/24
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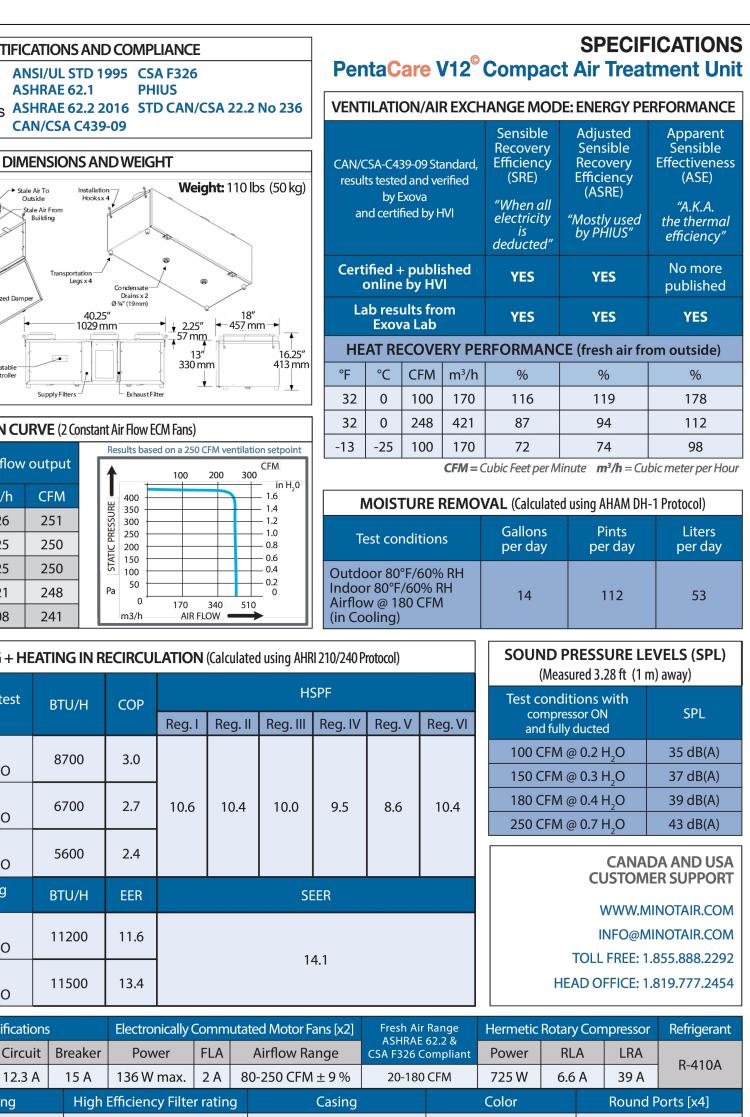
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ONTARIO, CANADA	23006	AS NOTED	APRIL 2023	M.452	


F			
	B 2100 HOV CERTIFI Home Ventilating www.hvi.or	ED C	CERTI
			D
	Fresh Air From Outside Fresh Air To • Building		
			Motorized
	Overflow x 2		USB-Upd atabl Microcontrolle
			FAN
	Static p	oressure	Air flo
	Pa	inH ₂ O	m ³ /h
	100 200	0.4	426 425
	250	1.0	425
	300	1.2	421
	400	1.6	408
		COO	LING +
	Heat p	ump hea conditior	ting tes
	Outdoo Indoor 7 Airflow	r 47°F/43 70°F/60°F 250 CFM	°F , 1 H_O
		r 35°F/33 70°F/60°F 250 CFM	
		r 17°F/15 70°F/60°F 250 CFM	
		pump conditi	
		r 95°F/75 30°F/67°F 250 CFM r 82°F/65	
	Airflow	r 82°F/65 30°F/67°F 250 CFM	: , 1 H ₂ O
	. .	Electrical	
	Tension 120 V	Phase/	
		Coils Filte	rs rating
		MERV 8 (EN G4)
			, A. M.
			CL.
	>		
	16" (40.cm)		18"
	M	inimum ance under front of un	40 cm
2 MI	NOTAIF		DET
M.500/ SCA	LE N.T.S.		

This drawing is the property of the Galang Consulting Services, and must be returned upon completion of the work. All information shown on this drawing is for use on this specific project. Contractor must verify all dimensions on the job and report any discrepancies to the Architect before proceeding with the work.

#	RESSURED FOR BUILDING PERMIT	MAR D44/1212
2	ISSUED FOR TENDER	APR 08/24
3	REISSUED FOR BUILDING PERMIT	JUN 24/24
4	ISSUED FOR TENDER	JUN 28/24
5	ISSUED FOR TENDER	JUL 12/24
6	REISSUED FOR TENDER	JUL 31/24

#	REVISIONS		DATE	



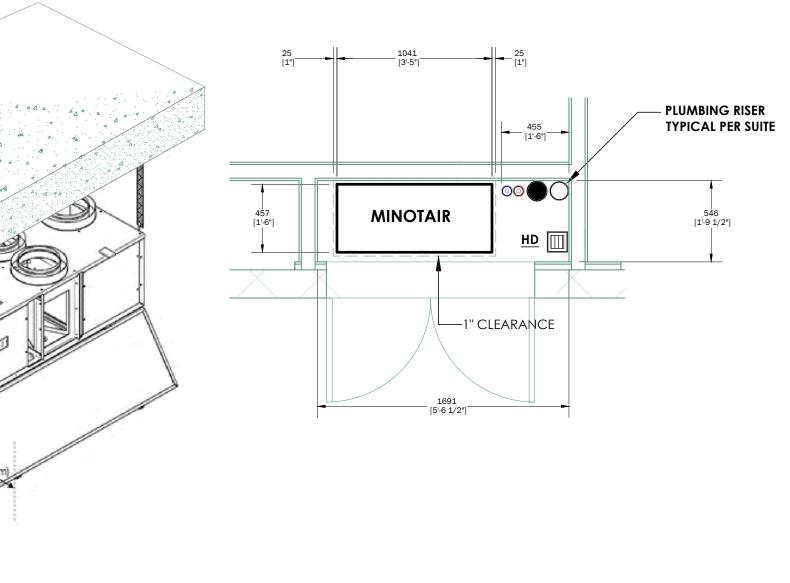

100% Aluminium


ø 6-8 in (150-200 mm)


Glossy White

TAIL (HEAT PUMP-HP)

HEPA MERV 15 (EN F9)



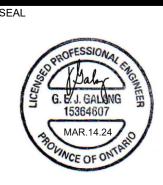

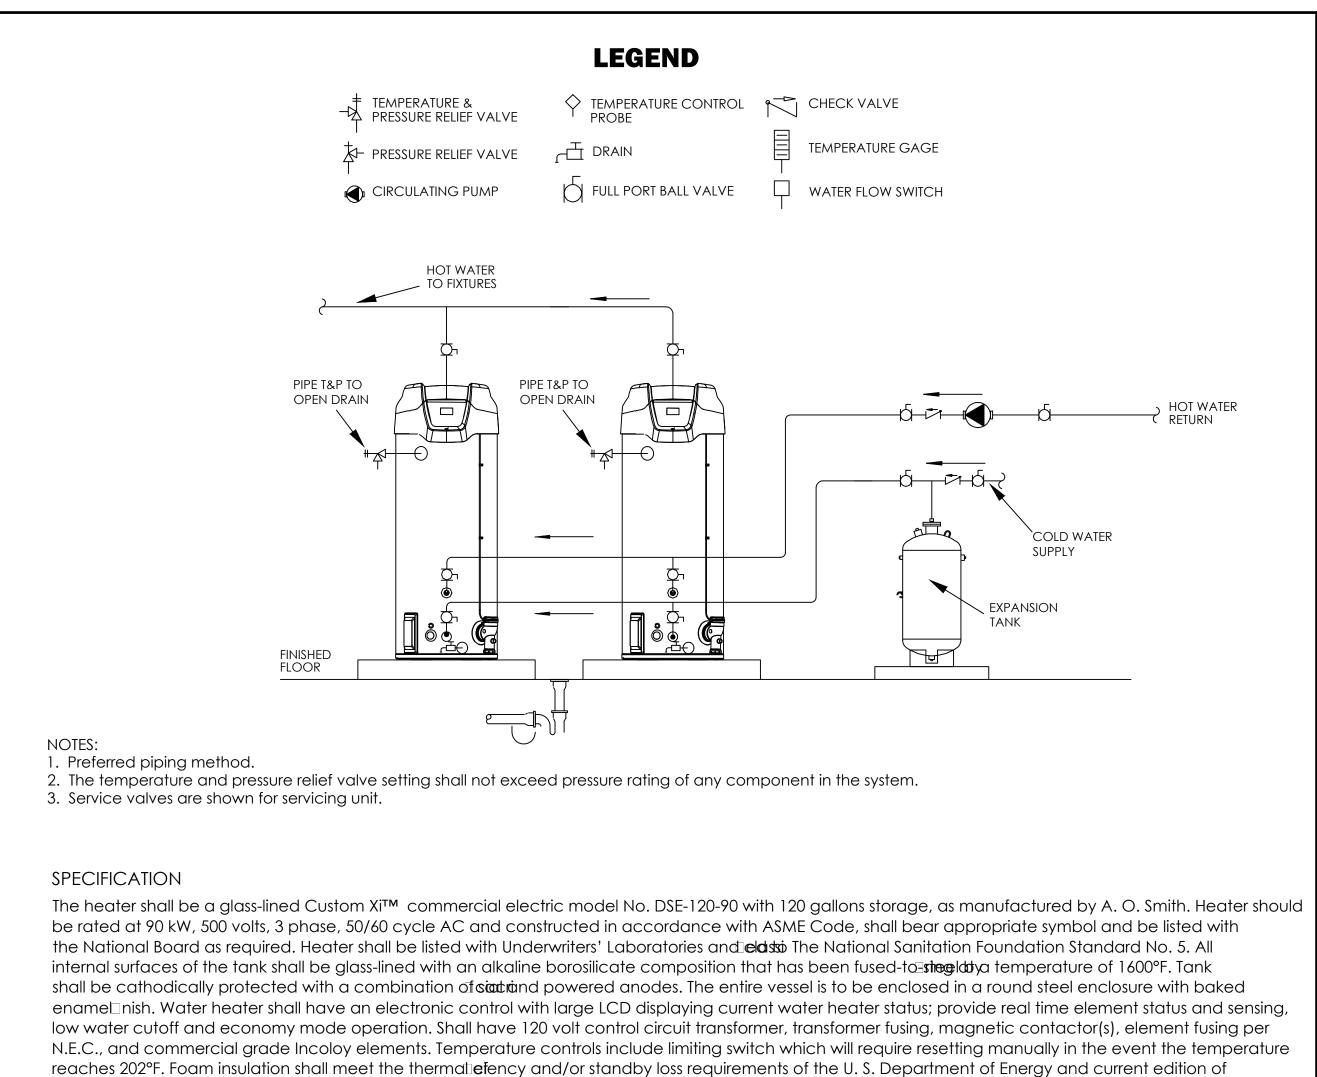


(1) ELECTRIC WATER HEATER DETAIL M.500 SCALE N.T.S.



ASHRAE/IES 90.1. Heater shall include a CSA Certiled and ASME Rated T&P relief valve and a drain valve. Water heater units(s) shall be compatible with building management systems using Modbus or BACnet with optional ICC interface.

	DRAWING SHEET TITLE			REVIEWED BY	
			- 4	j	bb
SING APT BLDG		ETAIL SHEE	11	DRAWN BY	GG
OUTH STREET, TRENTON	PROJECT NUMBER	SCALE	DATE	DRAWING NUMBER	
ONTARIO, CANADA	23006	AS NOTED	APRIL 2023	M.50	0

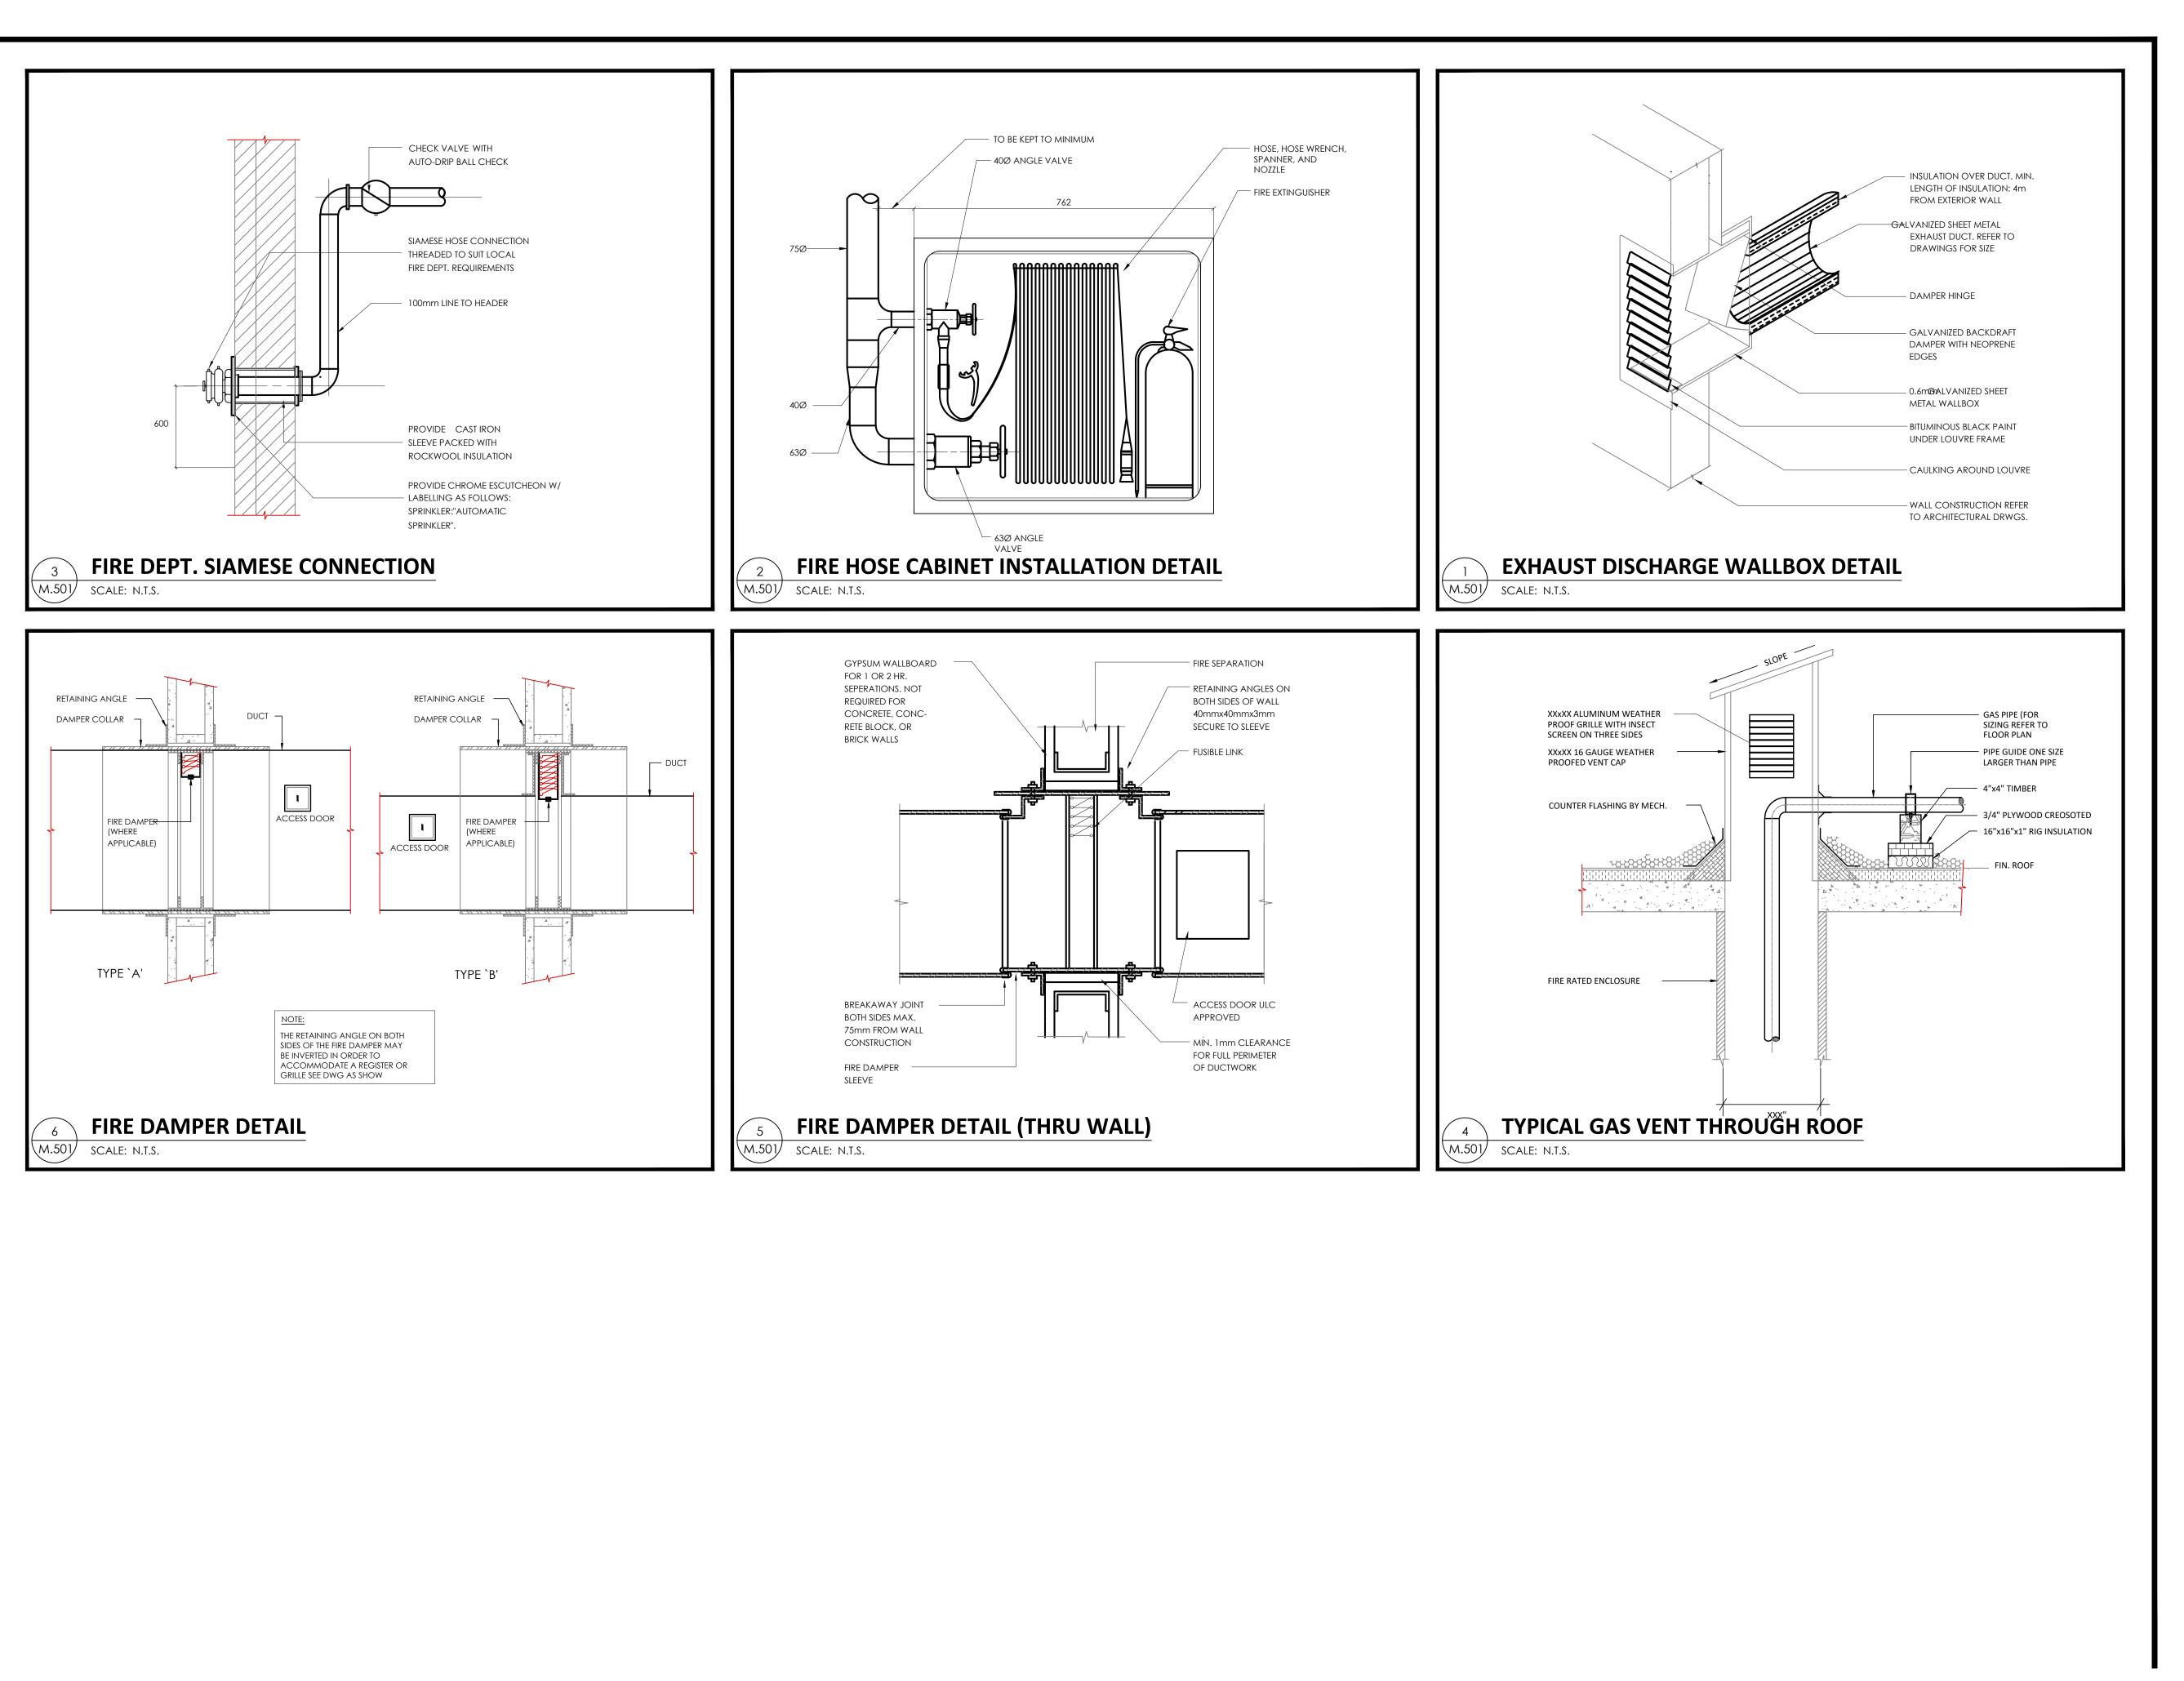

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_	6	REISSUED FOR TENDER	JUL 31/24
	5	ISSUED FOR TENDER	JUL 12/24
	4	ISSUED FOR TENDER	JUN 28/24
-	3	REISSUED FOR BUILDING PERMIT	JUN 24/24
-	2	ISSUED FOR TENDER	APR 08/24
-	#	RESSUED FOR BUILDING PERMIT	Mar D4/12 24

#	REVISIONS	DATE	






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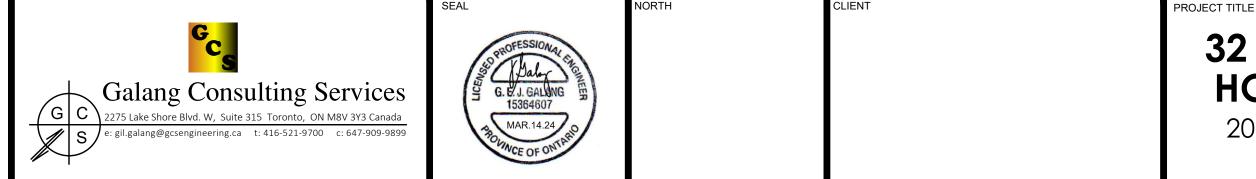
				REVIEWED BY	jbb
SING APT BLDG	DETAIL SHEET 2		DRAWN BY	GG	
UTH STREET, TRENTON	PROJECT NUMBER	SCALE		DRAWING NUMBER	
ONTARIO, CANADA	23006	AS NOTED	APRIL 2023	M.50)1




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6	REISSUED FOR TENDER	JUL 31/24
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3	REISSUED FOR BUILDING PERMIT	JUN 24/24
2	ISSUED FOR TENDER	APR 08/24
#	RESSURED FOR BUILDING PERMIT	MAR D4/12 24

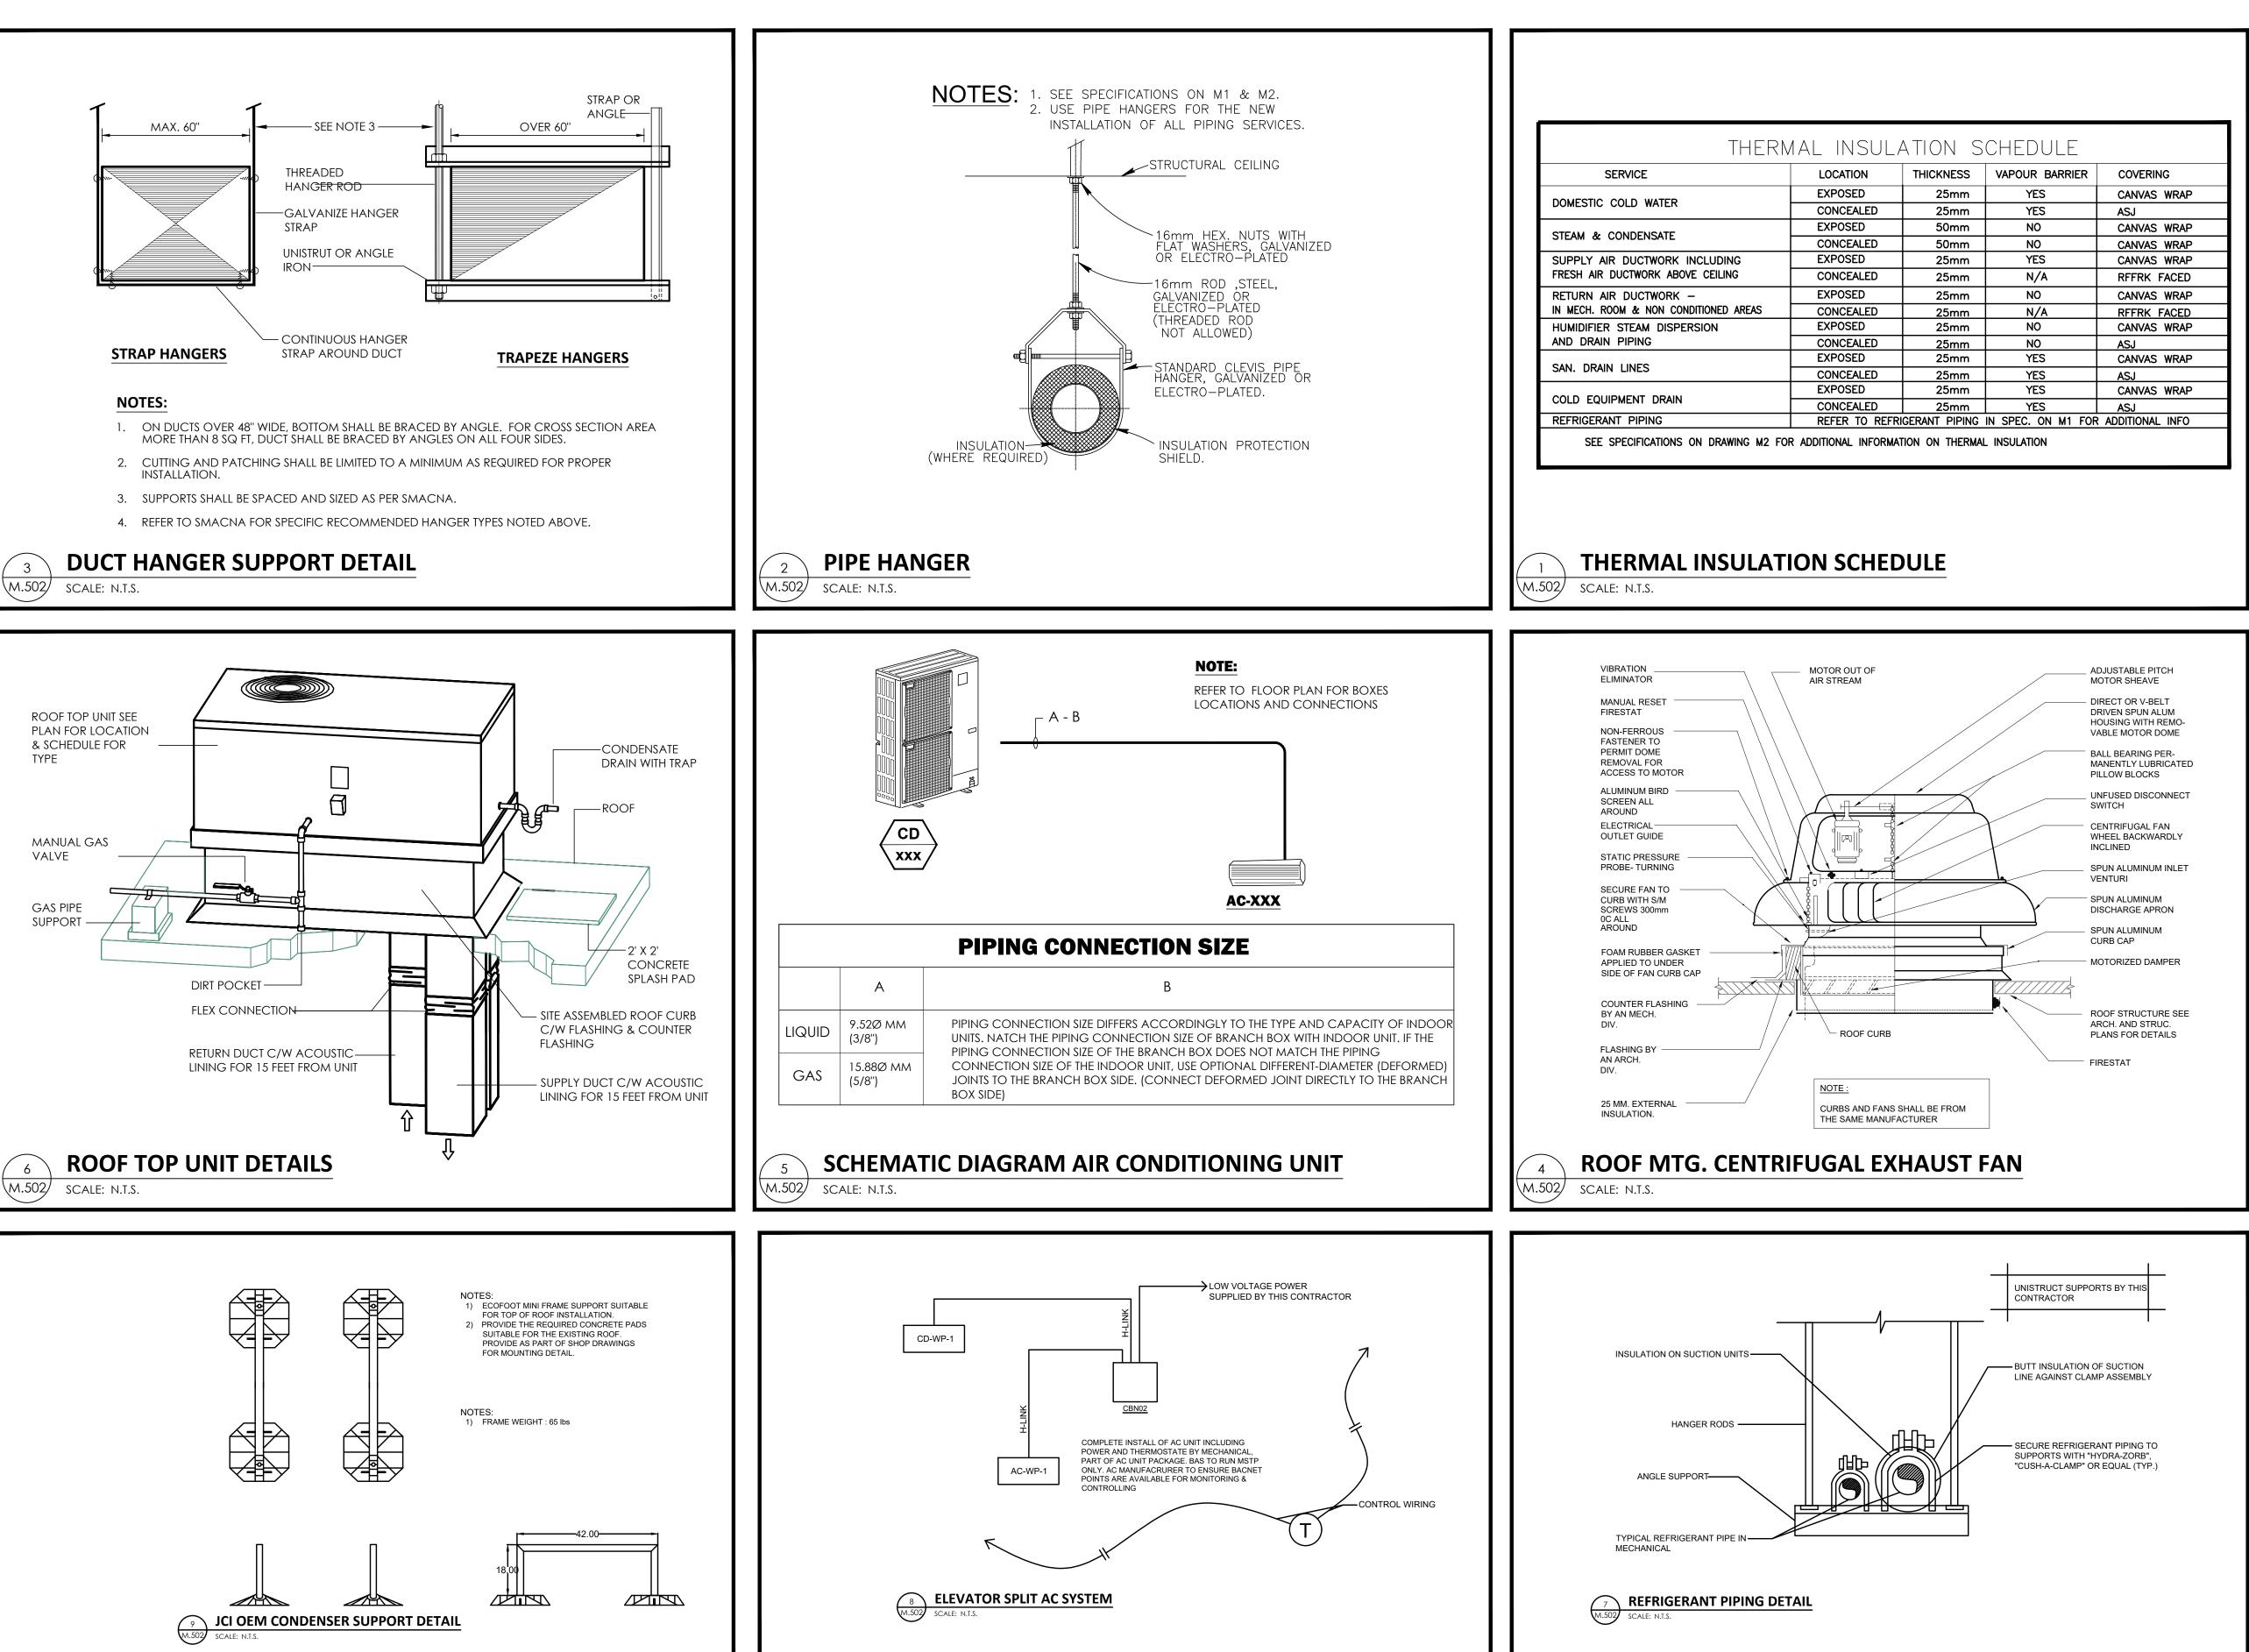			G
#	REVISIONS	DATE	



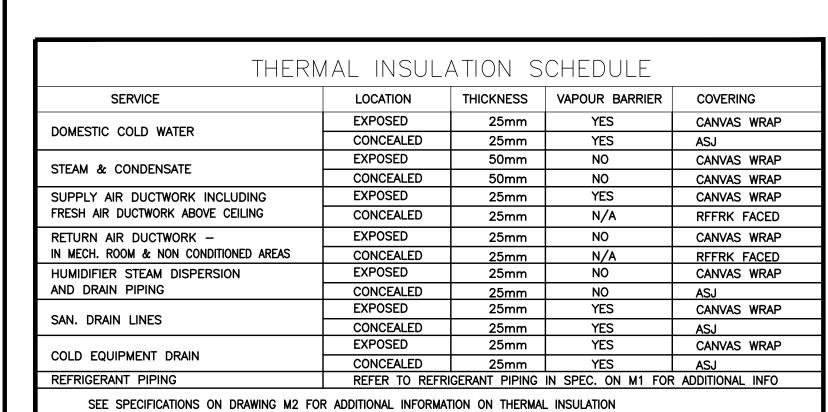

RAWING SHEET TITLE REVIEWED BY jbb **32 UNIT AFFORDABLE DETAIL SHEET 3** DRAWN BY HOUSING APT BLDG GG ROJECT NUMBER DRAWING NUMBER 20 SOUTH STREET, TRENTON SCALE APRIL AS NOTED 23006 **M.502** ONTARIO, CANADA 2023

VIBRATION ISOLATO 50 INSULATION - PREFINISHED GALVA STEEL FLASHING EX'G. ROOF CONSTRUCTION GALVANIZED STEEL DECK
STEEL CHANNEL SE STRUCT'L. DUCT
FINISHED ROOF
AS PIPING SUPP ILE: N.T.S.

6	REISSUED FOR TENDER	JUL 31/24
5	ISSUED FOR TENDER	JUL 12/24
4	ISSUED FOR TENDER	JUN 28/24
3	REISSUED FOR BUILDING PERMIT	JUN 24/24
2	ISSUED FOR TENDER	APR 08/24
#	RESSURED FOR BUILDING PERMIT	MAR D4/12 12

ŧ	REVISIONS	DATE	

