


REFLECTED CEILING PLAN - DEMOLITION

SCALE: 1:25


MAKE GOOD ALL SURFACES DAMAGED BY REMOVALS


| NEW DOOR SCHEDULE (ALL ITEMS ARE NEW U.O.N.) | | | | | | | | | | |
|--|---------------|------|----------|--------|------|----------|----------|----------------------------|--|--|
| | DOOR | | | | | FRAME | COMMENTS | | | |
| Door No. | SIZE | TYPE | MATERIAL | FINISH | TYPE | MATERIAL | FINISH | | | |
| 1 | 965 x 2132 mm | А | H.M. | PT | А | H.M. | PT | CLOSER - 3/4 HR FIRE RATED | | |
| 2 | 965 x 2132 mm | Α | H.M. | PT | А | H.M. | PT | CLOSER - 3/4 HR FIRE RATED | | |

CONFIRM DOOR HEIGHT - TO MATCH EXISTING ON SITE

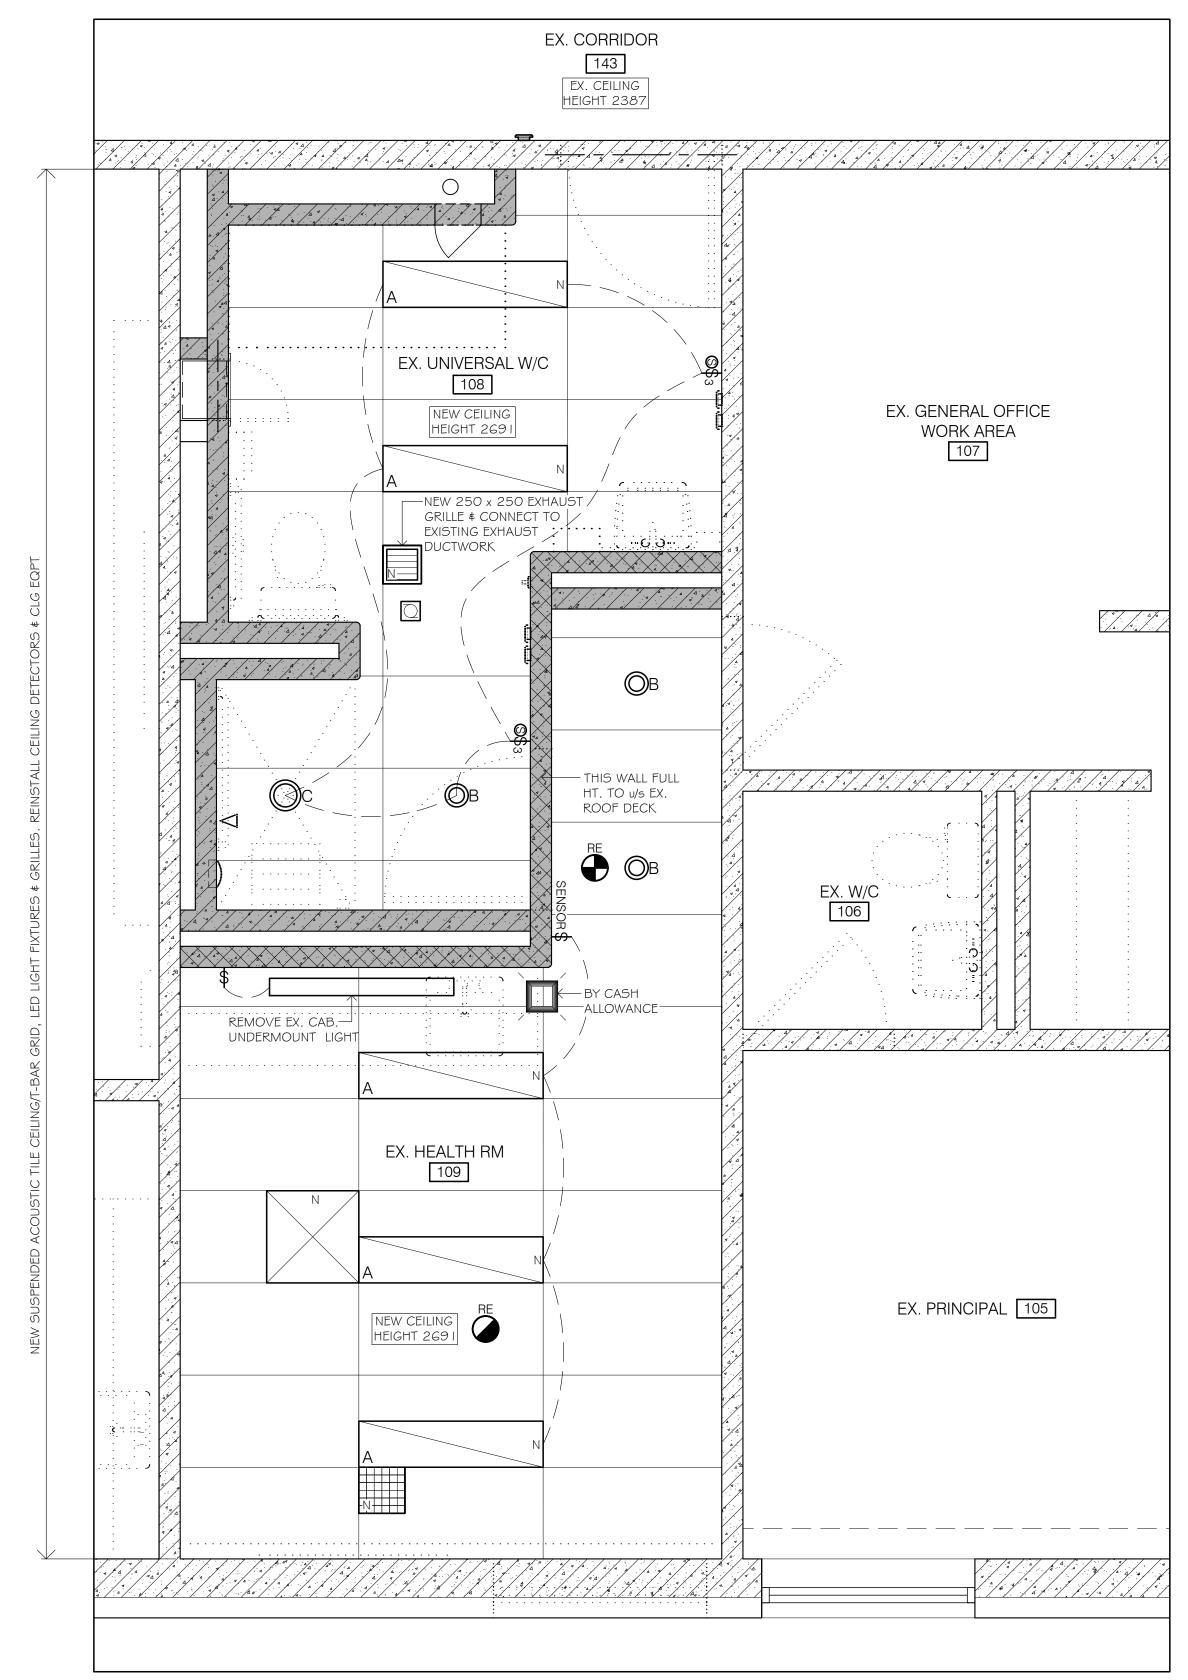


2 REFLECTED CEILING PLAN - NEW WORK
A2 SCALE: 1:25

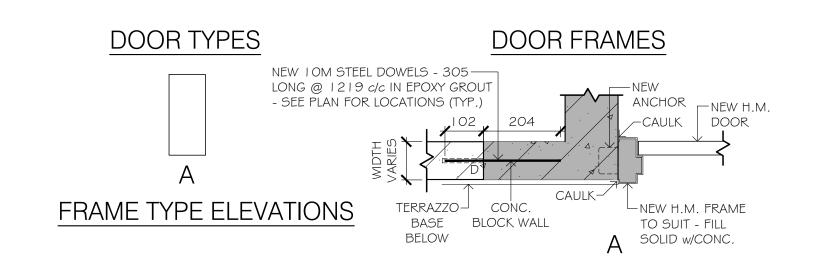

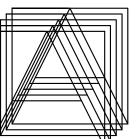

ARCHITECTS INC.
74 LINDSAY ST. SOUTH LINDSAY, ONTARIO PHONE: 705-328-0175 wilcox.off@gmail.com



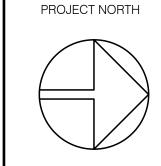



| SYMBOL | DESCRIPTION | | | | |
|--------------|---|--|--|--|--|
| | EX. 304 x 1219 LIGHT FIXTURE (DEMO) | | | | |
| A | NEW 304 x 1219 LIGHT FIXTURE | | | | |
| | NEW CAB. UNDER MOUNT LIGHT FIXTURE | | | | |
| © В | POT LIGHTS | | | | |
| O C | VAPOUR PROOF SHOWER POT LIGHT | | | | |
| | AIR SUPPLY GRILLE | | | | |
| | EX. FLUSH MT. METAL ACCESS PANEL - SIZE VARIES | | | | |
| | SURFACE MTD SMOKE DETECTORS | | | | |
| • | SURFACE MTD HEAT DETECTOR | | | | |
| Ф | RECEPTACLE | | | | |
| ₩ | RECEPTACLE - ABOVE COUNTER | | | | |
| ∇ | TELEPHONE | | | | |
| \$ | LIGHT SWITCH | | | | |
| ©\$ 3 | 3 WAY LIGHT SWITCH W/SENSOR | | | | |
| (1) | P/A | | | | |

EX = EXISTING
RE = RELOCATE
R = REMOVE
N = NEW

FOR TENDER & PERMIT FEB 26, 2005

ISSUED: DATE:

THIS DRAWING IS COMPLIMENTARY & MUST BE READ II CONJUNCTION WITH ALL THE OTHER DRAWINGS AND/ OR SPECIFICATIONS. REPORT ANY INCONSISTENCIES TO THE ARCHITECT.

PVNCCDSB ST. JOSEPH C.E.S. COBOURG - UNIVERSAL W/C IMPROVEMENTS

919 D'ARCY ST., COBOURG, ONTARIO K9A 4B4

EX. & NEW REFLECTED
CEILING PLANS

SCALE: AS NOTED DRA

RAWN BY:

CHECKED BY: GW

DRAWING NUMBER:

OF 3
24056

GENERAL NOTES FOR UNIVERSAL WASHROOM: (ALL FIXTURES TO BE BARRIER FREE U.O.N.)

• WATER SUPPLY TEMPERATURE TO BE SET AT MAX. 43°C OR INSULATE PIPES WHERE THEY

WOULD OTHERWISE PRESENT A BURN HAZARD.

• FAUCETS TO HAVE LEVER TYPE HANDLES WITHOUT SPRING LOADING OR MUST OPERATE AUTOMATICALLY.

• EQUIP WITH A BACK SUPPORT WHERE THERE IS NO SEAT LID OR TANK.

SHOWER

• PROVIDE A PRESSURE EQUALIZING OR THERMOSTATIC MIXING VALVE CONTROLLED BY A LEVER OR OTHER DEVICE OPERABLE USING A CLOSED FIST FROM A SEATED POSITION. HAND HELD SHOWER HEAD WITH NO LESS THAN 1800 OF FLEXIBLE HOSE REACHABLE FROM THE SEAT POSITION. ACCESSORIES

SOAP DISPENSER (LAVATORY)

- MUST OPERATE AUTOMATICALLY & SINGLE HAND OPERABLE AND REACHABLE FROM A SITTING POSITION. TOWEL DISPENSER or HAND DRYING EQP'T/RECEPTACLE (SINGLE HAND OPERABLE). CHOICE TO BE CONFIRMED BY

GRAB BARS

- GRAB BARS SHALL BE MIN. 35 AND 40 MAX. IN DIAMETER, BE MIN. 38mm \$ MAX. 50mm FROM THE WALL TO THE INSIDE SURFACE OF THE GRAB BAR, HAVE A SLIP RESISTANT SURFACE AND BE SECURELY ANCHORED TO RESIST A LOAD OF AT LEAST 1.3kN APPLIED VERTICALLY OR HORIZONTALLY. COORDINATE WGENERAL CONTRACTOR TO PROVIDE WALL SUPPORT AS REQUIRED.

SAFETY COAT HOOK - PROJECTING NO MORE THAN 50 FROM WALL.

RECESSED SOAP DISH - REACHABLE FROM THE FLIP DOWN SHOWER SEAT POSITION. SEE DWGS FOR LOCATION.

TOILET PAPER DISPENSOR

- LOCATE BELOW GRAB BAR WHERE POSSIBLE W/THE CLOSEST EDGE OF THE DISPENSER 300 FROM FRONT OF WATER CLOSET SEAT AND THE BOTTOM OF THE DISPENSER GOOMM MIN. TO 800mm ABOVE FINISHED FLOOR. • PROVIDE ADEQUATE BLOCKING IN FRAME PARTITIONS WALLS FOR SUPPORT OF ALL FIXTURES.

LOCATE COAT HOOK ON WASHROOM WALL @ MAX. I 200mm ABOVE FINISHED FLOOR PROJECTING MAX. 50 FROM

• DOOR MUST BE CAPABLE OF BEING LOCKED FROM THE INSIDE AND RELEASED FROM THE OUTSIDE IN CASE OF EMERGENCY. IT MUST HAVE A GRASPABLE LATCH OPERATING MECHANISM LOCATED NO LESS THAN 900 AND MAX.

I I OO ABOVE FIN. FLOOR. • DOOR CLOSER WSPRING HINGES OR GRAVITY HINGES WITH A CLOSING PERIOD OF NO LESS THAN 3 SECONDS FROM WHEN THE DOOR IS IN AN OPEN POSITION OF 70° TO THE DOORWAY, TO WHEN THE DOOR REACHES A POINT 75mm FROM THE CLOSED POSITION, MEASURED FROM THE LEADING EDGE OF THE LATCH SIDE OF THE DOOR.


• ACCESSIBILITY SIGN FOR BARRIER FREE WASHROOM LOCATED AT W/C ENTRY DOOR BETWEEN 1200 \$ 1500 A.F.F. • POWER DOOR OPERATOR WITH SIGN INCORPORATING THE INTERNATIONAL SYMBOL OF ACCESS. LOCATE ON LATCH SIDE AND OPERABLE USING A CLOSED FIST. DOOR OPENING DEVICE (CONTROLS) TO BE MOUNTED MIN. 900mm TO MAX. I I OOMM ABOVE FINISHED FLOOR, LOCATE NO LESS THAN GOOMM AND NO MORE THAN I 500MM BEYOND THE DOOR SWING WHERE THE DOOR OPENS TOWARD THE CONTROL.

• THE CONTROLS FOR THE POWER DOOR OPERATOR SHALL HAVE A FACE DIMENSION NO LESS THAN I 50 Ø IF CIRCULAR OR 50x100 WHERE RECTANGULAR.

• PROVIDE A EMERGENCY CALL SYSTEM THAT CONSISTS OF AUDIBLE AND VISUAL SIGNAL DEVICES INSIDE # OUTSIDE OF THE WASHROOM THAT ARE ACTIVATED BY A CONTROL DEVICE INSIDE THE WASHROOM AND AN EMERGENCY SIGN THAT CONTAINS THE WORDS IN THE EVENT OF AN EMERGENCY PUSH EMERGENCY BUTTON AND AUDIBLE AND VISUAL SIGNAL WILL ACTIVATE IN LETTERS AT LEAST 25 HIGH WITH A 5 STROKE AND THAT IS POSTED ABOVE THE EMERGENCY BUTTON. • PROVIDE LIGHTING CONTROLLED BY A MOTION SENSOR AS PER O.B.C. FOR UNIVERSAL - SEE ELEC'L

TYPICAL CABINETRY NOTES:

- CABINET/COUNTER FINISH/COLOUR \$ EDGE PROFILE TO BE CONFIRMED BY OWNER. • ALL SHELVES TO BE 3/4" \$ FULLY ADJUSTABLE U.O.N. w/METAL PILASTERS COUNTERSUNK IN SIDES OF CABINETS (FACE FLUSH) & ADJUSTABLE METAL SHELF
- ALL EXPOSED OPEN SHELVES IN CABINETS TO BE FINISHED GRADE.
 DOOR/DRAWER PULLS TO BE STAINLESS STEEL U.O.N. DRAWER HARDWARE TO BE
- FULL EXTENSION, SOFT CLOSE \$ DOOR HARDWARE TO BE SOFT CLOSE. • ALL EXPOSED FINISH ENDS, PANELS, FILLERS TO HAVE MATCHING CABINET FINISH. TOEKICK TO HAVE MATCHING CABINET FINISH OR AS PER SPECIFICATIONS.
- ALL DOOR ¢ DRAWER FRONTS TO BE ¾". DRAWER BOTTOMS ¢ BACKS TO BE ½". • COUNTERS TO BE POSTFORMED WITH 4" BACK SPLASH & LAMINATE FINISH.
- PROVIDE ALL COUNTER BUILD UP AS REQUIRED. • SCRIBE COUNTERTOPS & CLEAR CAULK AT BACKSPLASH.
- SCRIBE FILLERS TO SUIT ADJACENT WALLS. • CONSTRUCT & INSTALL NEW CABINETS TO INCORPORATE ALL BUILDING SITE CONDITIONS.

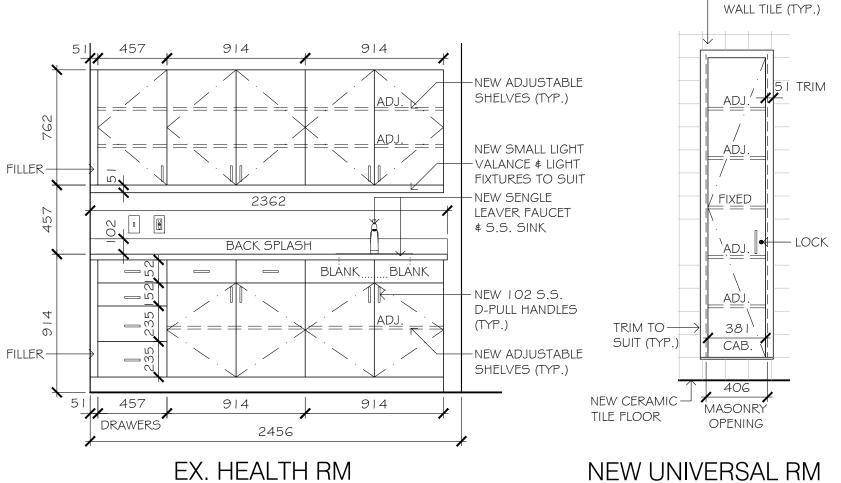


NEW CABINETRY ELEV.


A3/ SCALE: 1:25 109




- NEW CERAMIC


NEW UNIVERSAL RM 2 NEW CABINETRY ELEV. 3 NEW CABINETRY SECTION A3 SCALE: 1:25 108

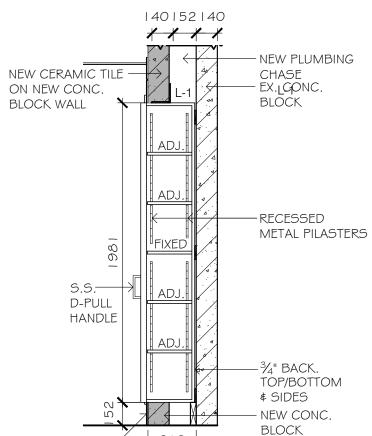


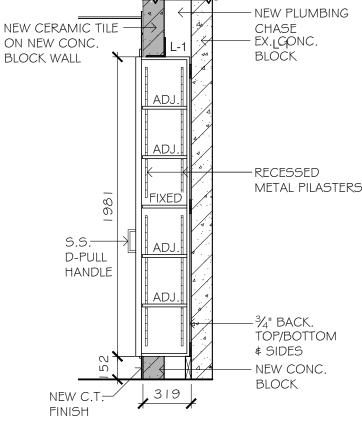


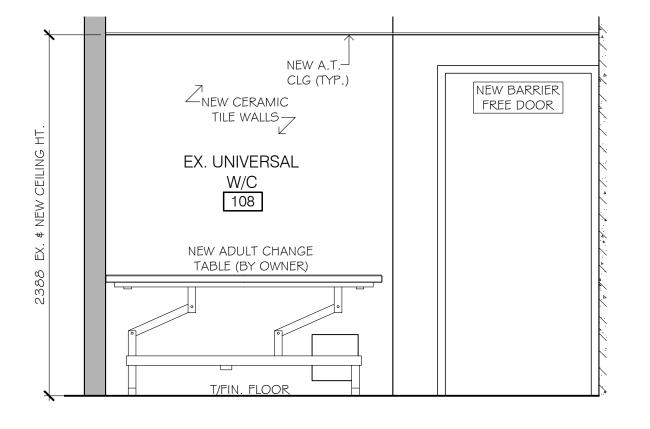




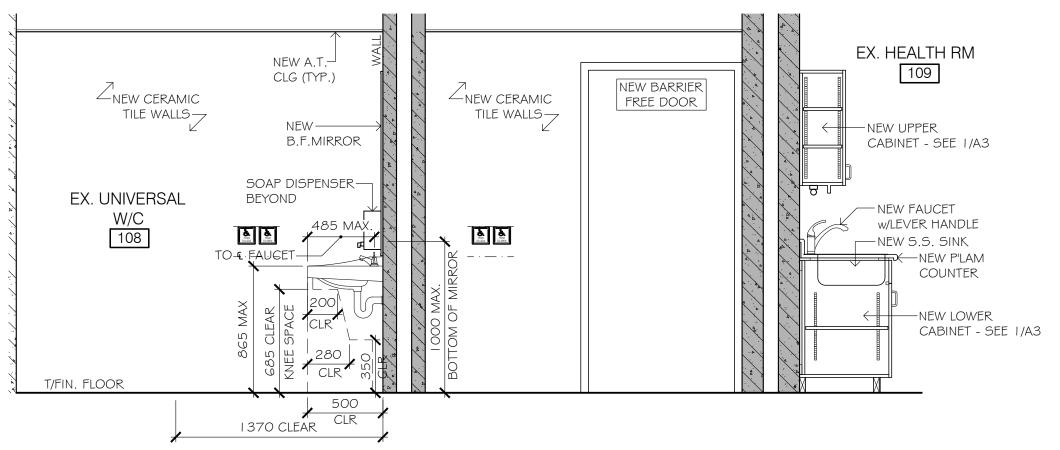


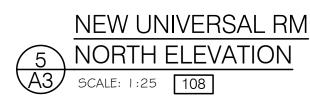


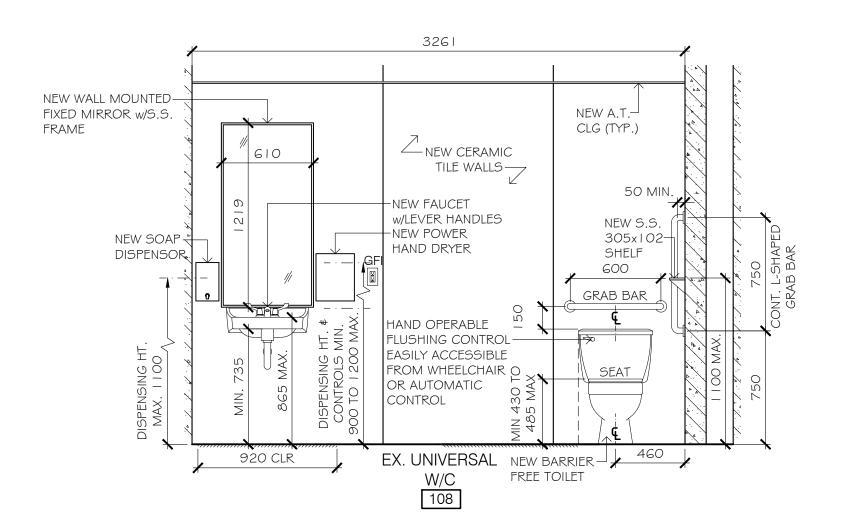




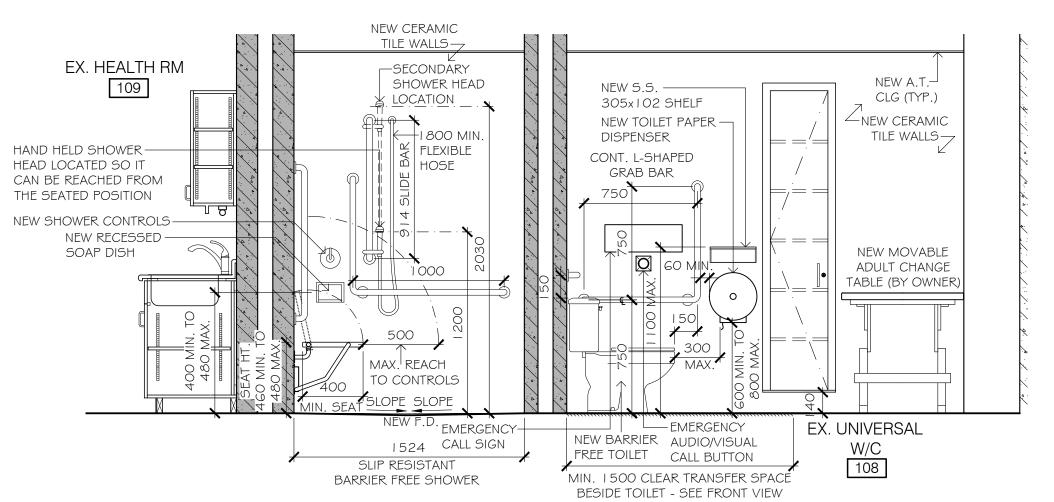

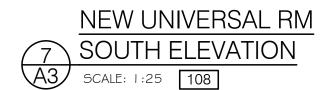

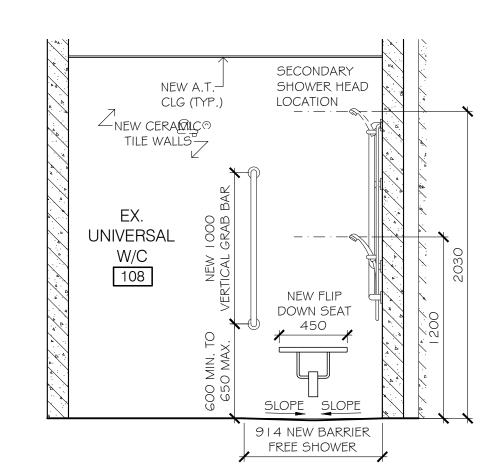


| | NEW UNIVERSAL RM | | | | | | | |
|-----------|------------------|--|--|--|--|--|--|--|
| 8 | EAST ELEVATION | | | | | | | |
| A3 | SCALE: 1:25 108 | | | | | | | |

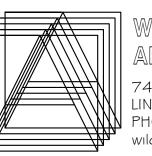

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PROJECT NORTH



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EX. & NEW REFLECTED CEILING PLANS

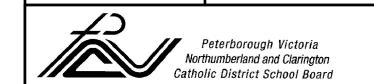AS NOTED DRAWING NUMBER: PRAWN BY:

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